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Architectural Review Board Staff Report

Project Type: Amended Site Development Plan (3rd)

Meeting Date: September 12, 2019

From: Mike Knight, Planner

Location: A 48.2 acre tract of land located north of North Outer 40 Road and east of

Boone's Crossing.

Description: Chesterfield Outlets (17107 N Outer 40 Road – The District): An Amended

Site Development Plan, Landscape Plan, Lighting Plan, Architectural Elevations and Architect's Statement of Design for a 48.2 acre tract of land located north of N Outer 40 Road and east of Boone's Crossing. (17T420027)

PROPOSAL SUMMARY

This request is to allow for the construction of phase one of an entertainment district within the Chesterfield Outlets subdivision known as The District. The applicant has taken control of the property in an effort to redevelop and reposition the property into a regional entertainment district with a variety of entertainment themed options, including restaurants, a food hall, live music venue, and complementary retail/entertainment uses. Phase one has three primary components: a 3,000 seat indoor theatre, a 2-story structured parking garage, and a 48,559 square foot recreational facility.

SITE HISTORY

St. Louis County zoned the subject site "NU" Non-Urban District in 1965. On November 21, 2011, the City of Chesterfield approved Ordinance 2682, which zoned the subject site from a "NU" Non-Urban District to a "PC" Planned Commercial District.

Subsequent to the change in zoning, a Site Development Plan was submitted proposing a 472,282 square foot outlet retail center on the site. The plan was approved by the City of Chesterfield on March 26, 2012. A minor amendment was approved in October of 2012 to relocate the management office from the westernmost building to the easternmost building.

In May of 2019, the current governing ordinance, City of Chesterfield Ordinance 3049, was approved by City Council. The primary purpose of this ordinance amendment was to establish a maximum height of 60 feet for the proposed pavilion and indoor theater uses, including rooftop mechanical equipment, screening, and architectural features.



Figure 1: Aerial Site Photo

STAFF ANALYSIS

Chesterfield Valley Design Policies: The City of Chesterfield's Comprehensive Plan has a specific Chesterfield Valley Policies Element. The policies include commercial development with particular concern over the image presented by development along I-64. There are six specific policies of which four are applicable to the design of this project. Staff outlines the applicable policies below and how the Amended Site Development Plan relates to those policies.

Policy 1: Facades of Buildings Along I-64 and Arterial Roadways – Care should be taken to make sure that any portion of a building is equally uniform in materials and attractiveness as the primary facade. The intent is to avoid projects having their view from I-64/US 40 or the roadways appear to be the rear or side of a development.

The primary view of the entertainment district would be from the south, east, and west as one would see the buildings driving east to west/ west to east along I-64 and North Outer 40 Road. Rivers Edge Park and the Levee Trail system are located directly to the north of the subject site.

Policy 2: Lighting of Buildings Along I-64/US 40 - The facades of buildings facing I-64 should be lighted to provide an attractive image at night for individuals traveling along I-64.

The lighting currently submitted consists of both decorative and utilitarian lighting. Lights that are not fully shielded flat lensed fixtures that enhance the architecture (decorative) will require approval from Planning Commission.

Policy 3: Automobile Parking for Buildings Along I-64 - Parking should be primarily located to the side or rear of any building façade facing I-64/US 40 or along North Outer 40.

Surface parking shown on the Amended Site Development Plan is primarily shown in the front of all the existing buildings, as seen in Figure 1 on the previous page. There is minimal change in surface parking for the site compared to the existing conditions. A new 2 story parking garage is being constructed on the site and the proposed location is west of both the existing and proposed building footprint.

Policy 4: Pedestrian Circulation - In order to promote pedestrian movement, each development is required to address pedestrian circulation within and between all developments. This pedestrian system shall be designed in an overall safe, clearly understood plan meeting ADA (American Disabilities Act) requirements.

The site currently does not have a sidewalk along N Outer 40 Road, and there is not one being proposed within the scope of the redevelopment. The neighboring site to the east has an approved site plan that depicts a sidewalk connection internally from the Summit-Topgolf subdivision to a positioned cross walk on the eastern edge of the subject site.

General Requirements for Site Design:

The applicant has stated that The District project is being proposed in phases. This submittal is for Phase one, which consists of some existing buildings to remain and three proposed buildings: (1)parking garage, (2)music venue, and (3)recreational facility. Below (Figure 2) is an image of the overall conceptual master plan, followed by Figure 3, which solely depicts the scope of phase one.



Figure 2: Conceptual Master Plan for The District



Figure 3: Completion of Phase One Color Site Plan

A. Site Relationships

The subject site is located north of North Outer 40 Road and east of Boone's Crossing in what is classified as the Chesterfield Valley Area within the City's Comprehensive Land Use Plan. Given that North Outer 40 Road is a major arterial in accordance to the City of Chesterfield Street Classification Map and given the site's close proximity to I-64, the south, east, and west façades are highly visible. The site is also visible from the north from the Monarch Chesterfield Levee Trail. Directly to the east is Lot A of the Summit-Topgolf subdivision in which there is an approved site plan for a hotel that is 4 stories in height and roughly 85,000 square feet of gross floor area. The Topgolf facility is Lot B of the Summit Topgolf subdivision and is directly east of the proposed hotel. Directly to the west of the subject site are two bank/office buildings and combined have roughly 28,000 square feet of gross floor area.

The Unified Development Code outlines specific desirable and undesirable practices within site relationships. A desirable practice is to provide public plazas, courtyards, assembly areas, etc. Although Phase one does not specifically embody this practice, it should be noted that the conceptual master plan does include an outdoor pavilion at the center of the site which serves as one of the primary visual and physical focuses for the development as a whole.

B. Circulation and Access

Vehicular access is composed of four entrances from N Outer 40 Road. The far western entrance will be relocated in conformance to the positioning as defined in the Traffic Study accomplished within the most recent ordinance amendment. It has been stated that the new parking garage will be primarily used for the proposed music venue. A traffic management plan has also been submitted in conjunction with the Amended Site Development Plan submittal to ensure the best traffic control for larger events.

Pedestrian access can largely be seen in two areas of the site. The first being on the west side of the tract via the Monarch Levee Trail and from the east internally with Lot A of the neighboring Summit-Topgolf subdivision.

C. Topography

The site is relatively flat with a couple of feet of grade change from east to west and north to south for drainage. There is a large drainage channel along the southern edge of the site to remain. The finish floor elevation of the buildings are roughly 468'. For reference, the finish floor elevation for the neighboring Top Golf facility to the east is at 462' and the office/bank buildings to the west have finish floor elevations of 467' and 466'. There are no retaining walls existing or planned for this development.

General Requirements for Building Design:

This request is to permit the construction of phase one of the re-development of the existing outlet mall located within the Chesterfield Outlets subdivision. Phase one has three primary components: A 2-story structured parking garage, a 3,000 seat indoor theatre, and a 48,559 square foot recreational facility. The parking garage has a gross floor area of 66,452 square feet and contains 375 spaces, which is roughly 15% of the total parking for the site. The indoor theatre is 52,063

4 | Page

square feet and is roughly 60 feet in height which is the largest habitable structure on the site. The recreational facility is 48,559 square feet and roughly 38' in height.

A. Scale

Given this development will ultimately be achieved in phases, new buildings will be situated adjacent to the existing buildings and this review is for the development incorporating these changes. There are no planned changes to the existing buildings to remain. The existing buildings have a base height of 20' with accents ranging from 24-28' in height. Feature elements at the corners reach a maximum height of 40'. The new buildings will range in maximum height from 38' (Recreational Facility) to 60' (Music Venue). The height differential between existing and proposed buildings is depicted in blue in Figure 4 below. The appearance will also change visually from east to west. Approximately 946' of the total 2,566 linear feet of virtually contiguous buildings, or 37% of the visual frontage, will be new in appearance, as seen in orange also in Figure 4.

Existing Proposed Existing Proposed Proposed 60' 31'8" 40' 40' BUILDING "E BUILDING "G" BLDG "L BUILDING BUILDING BLDG "M BUILDING "H" BUILDING BUILDING "K" Proposed Existing Existing Proposed 1440 180 180

Maximum Height (Overall 60')

Building Length (Overall 2,566)

Figure 4: Existing vs Proposed Height and Length

B. Design

The applicant states within the provided Architectural Statement that Vintage Industrial is the architectural style chosen for the redevelopment. As previously mentioned, the development will be completed in phases, and when completed, the central portion will contain a main steel structure. This structure or "pavilion" is intended to be a communal area with a stage and open space to be used for concerts and a variety of entertainment options. Also in a future phase are multiple restaurant uses that surround or flank the community gathering space. The pavilion and flanking restaurants may be seen in Figure 2 on page 3.

The design of the current outlet mall was intended to be a classic retail pedestrian "shopping street" as stated in the associated previous ARB submittal. The project has an alternating series of

landscaped open court yards and sky lit covered pavilions. The far east anchor building acts as a "bookend" to the west and is scheduled to remain.

C. Materials and Colors

The existing buildings have a neutral/earthy palette of colors and materials. The colors include beiges, tans, terra cotta, and tones of gray, with a primarily white trim for much of the buildings. The materials include veneer brick, veneer stone, along with painted tilt-up concrete panels and applied EIFS trim and cornices.

The proposed buildings include materials primarily consisting of brick, stone, concrete tilt-up panels, EIFS systems, with aluminum glass and glazing. The colors of the proposed buildings are also earthy including beige, sand, walnut, gray and black. One exception to the neutral/earthy colors to both the existing and proposed buildings would be the utilization of Cobalt Stone Blue and Alpolic CFB Blue on the recreational facility and the utilization of yellow with the associated recreational facility bollards in front of the building as seen in Figure 7 on the following page.

North Outer 40 Road and I-64 are major arterials in accordance with the City of Chesterfield Street Classification Map and travel east to west parallel to the site and thus renders the south elevation the most prominent of all the elevations. Figures 5-7 depict the south elevations of all 3 proposed buildings in order from west to east. Each elevation will call out the primary materials and their associated (color).

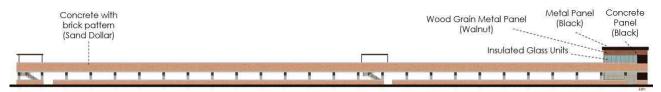


Figure 5: Parking Garage - South Elevation



Figure 6: Music Venue - South Elevation



Figure 7: Recreational Facility - South Elevation

D. Landscape Design and Screening

A Landscape Plan has been submitted in conjunction with the submittal. Most of the existing plantings are scheduled to remain, with most of the changes to the existing incorporated through adjusted landscape islands within the updated parking configuration. In total, there is a mixture of 13 new trees (Birch, Maple, and Oak) being proposed and 938 new shrubs of various species. All screening of rooftop mechanical units of proposed buildings is to be screened naturally by the building parapets. All trash enclosures and ground mechanical units are scheduled to remain or match the existing enclosures and can be seen in Figure 8 below.





Figure 8: Existing Trash, Electrical Switchgear, and Utility Screening

E. Lighting

Lighting consists of utilitarian and decorative lighting within the Amended Site Development Plan submittal. The development will utilize several different lighting strategies. For the site lighting, 20' high silver pole mounted, black flat lensed fixtures with full cut features are used. This is for general light levels in the parking and other site spaces. Lights that are not fully shielded flat lensed fixtures that enhance the architecture (decorative) will require approval from Planning Commission.

Figure 9 below depicts the decorative lighting for the Music Venue. This lighting will include two features that are directed upward. One is a flood light approximately 1 foot above grade and one is

an ingrade uplight. The Unified Development Code specifically states to avoid floodlighting for facades of buildings facing I-64. The applicant has also stated that no uplighting will trespass beyond the roofline of any structure. Other decorative fixtures include a canopy downlight and wall sconces solely on the south façade.

Figure 10 below depicts the decorative lighting for the Recreational Facility. There is one decorative fixture which is a linear LED grey light fixture programmed with a static white output.

All three proposed buildings will include various utilitarian wall packs.


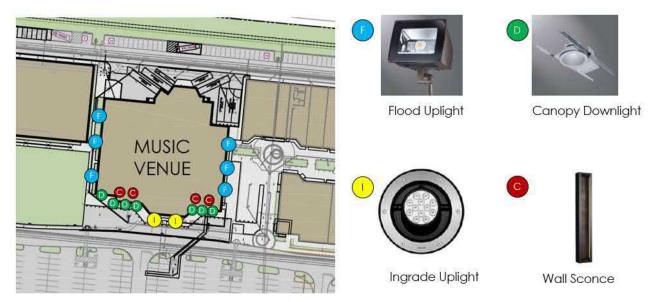


Figure 9: Music Venue Lighting





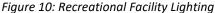

DEPARTMENT INPUT

Be advised, this project is still going through development review by City Staff and will not proceed to the Planning Commission until all outstanding items have been addressed. All recommendations made by the ARB will be included in Staff's report to the Planning Commission.

Staff requests review and recommendation on this submittal for Chesterfield Outlets (17107 N Outer 40 Road – The District)

MOTION

The following options are provided to the Architectural Review Board for consideration relative to this application:

- 1) "I move to forward the Amended Site Development Plan, Landscape Plan, Lighting Plan, Architectural Elevations and Architect's Statement of Design for Chesterfield Outlets (17107 N Outer 40 Road The District), as presented, with a recommendation for approval (or denial) to the Planning Commission."
- 2) "I move to forward the Amended Site Development Plan, Landscape Plan, Lighting Plan, Architectural Elevations and Architect's Statement of Design for Chesterfield Outlets (17107 N Outer 40 Road The District) to the Planning Commission with the following recommendations..."

Attachments

1. Architectural Review Packet Submittal



ARCHITECTURAL REVIEW BOARD SUBMITTAL PACKAGE

AUGUST 16, 2019 REVISED AUGUST 28, 2019

DEVELOPER

PREPARED BY



The Staenberg Group
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St. Louis, Missouri 63114 - 314.513.1500
tsgproperties.com

Chiodini Architects
1401 South Brentwood Blvd.
St. Louis, Missouri 63144 - 314.725.5588
chiodini.com





ARCHITECTURAL REVIEW BOARD Project Statistics and Checklist

Date	of First Comment Letter Received from the City of Chesterfield	
Project	Title: Chesterfield Outlets - The District Location: 17107 North Outer Forty Road	
Develo	er: TSG Chesterfield Lifestyle Architect: Chiodini Architects Engineer: Stock & Associates	
PROJE	ET STATISTICS:	
Size of	site (in acres): 48.151 Total Square Footage: Building Height: Varies	
Propos	PC - Planned Commercial - Retail, Office, Entertainment	
	Building Materials: Brick, stone, EIFS, metal panels, Concrete Tilt-up walls	
	Membrane roof system over rigid insulation	
	ng Material & Design: Perforated metal panels on Steel structure	
	tion of art or architecturally significant features (if any):	
•	ral portion of The District, under the main steel structure of the development, will be a communal area with a	a stac
<u>ADDITI</u>	NAL PROJECT INFORMATION:	
Checkli	st: Items to be provided in an 11" x 17" format	
X	Color Site Plan with contours, site location map, and identification of adjacent uses.	
X	Color elevations for all building faces.	
X	Color rendering or model reflecting proposed topography.	
X	Photos reflecting all views of adjacent uses and sites.	
X	Details of screening, retaining walls, etc.	
X	Section plans highlighting any building off-sets, etc. (as applicable)	
X	Architect's Statement of Design which clearly identifies how each section in the Standard has been addressed and the intent of the project.	S
X	Landscape Plan.	
X	Lighting cut sheets for any proposed building lighting fixtures. (as applicable)	
	Large exterior material samples. (to be brought to the ARB meeting)	
X	Any other exhibits which would aid understanding of the design proposal. (as applicable))
×	Pdf files of each document required.	
A	690 Chesterfield Parkway West, Chesterfield, MO 63017-0760 Ph. (636)537-4746 Fax (636)537-4798 www.chesterfield.mo.us Page 1 of 2	



THE DISTRICT – Architectural Statement

We see the reimagining of the old Taubman Outlet Mall to be a chance to bring people together to eat, drink, shop and play in a convenient one-stop center to be rebranded, The District. A development that combines a variety of uses brings vitality to the area, providing young and old from Chesterfield and the metropolitan St. Louis area with a safe, convenient and fun place to gather.

Site Relationship - The District is located on North Outer Forty just west of Top Golf development and east of the Boone's Crossing bridge. Surrounding the development is The Midwest Bank Building, proposed Hotel and Top Golf.

Circulation and access – The District have four entrances from North Outer Forty to the development. The entrance on the west end of the development will be relocated to accommodate the proposed changes to the development based on the traffic study.

Topography – The site is relatively flat with a slight grade east to west and north to south for drainage.

Retaining walls – There are no retaining walls on the existing development nor are any planned for the proposed changes to the development.

Design Materials - The development is an established project with existing materials that will be used or enhanced to the new "Vintage Industrial" look. The materials consist of brick, stone, concrete tilt-up panels, EIFS systems, Aluminum glass and glazing.

Landscape Design and Screening - The landscape is established for the development and the new landscaping will match the existing landscaping and the guidelines established by the City of Chesterfield. There are various screening methods developed for the development and all new screens required will match the establish existing screening methods and materials.

Site Lighting - The site lighting will remain and will be adjusted to accommodate the new buildings being added on the west end of the development.

The development will be done in phases and when the development is completed the central portion of The District, under the main steel structure of the development, will be a communal area with a stage and open space to be used for concerts and a variety of entertainment options. Flanking this community gathering space will be a myriad of restaurant, retail and entertainment choices.

Vintage Industrial is the architectural style chosen for the redevelopment. The raw simplicity of industrial style buildings combined with the retro feel of vintage architecture creates a statement of sleek but simple sophistication and a vibe that's comfortable, accessible and fun. The architectural design of industrial buildings depends mostly on how pronounced the standard features and characteristic lines of the structures are. Characteristic features include various engineering structures, such as flues and ventilation ducts, pipelines, and exposed equipment. The appearance of industrial buildings depends in great part on the artistic treatment of the materials and structures used, the shape of structures, the system used to divide walls into prefabricated elements, the surface finish, and the color of structural and finishing materials.

The beauty of Vintage Industrial architecture is that it's timeless, neutral, simple and natural.

Programming | Planning | Architecture | Interior | Graphics 1401 South Brentwood Blvd. | Suite 575 | Saint Louis, Missouri 63144 314.725.5588 | FAX 314.733.9999 | arch@chiodini.com












CONCEPTUAL MASTER PLAN






OVERALL COLOR SITE PLAN



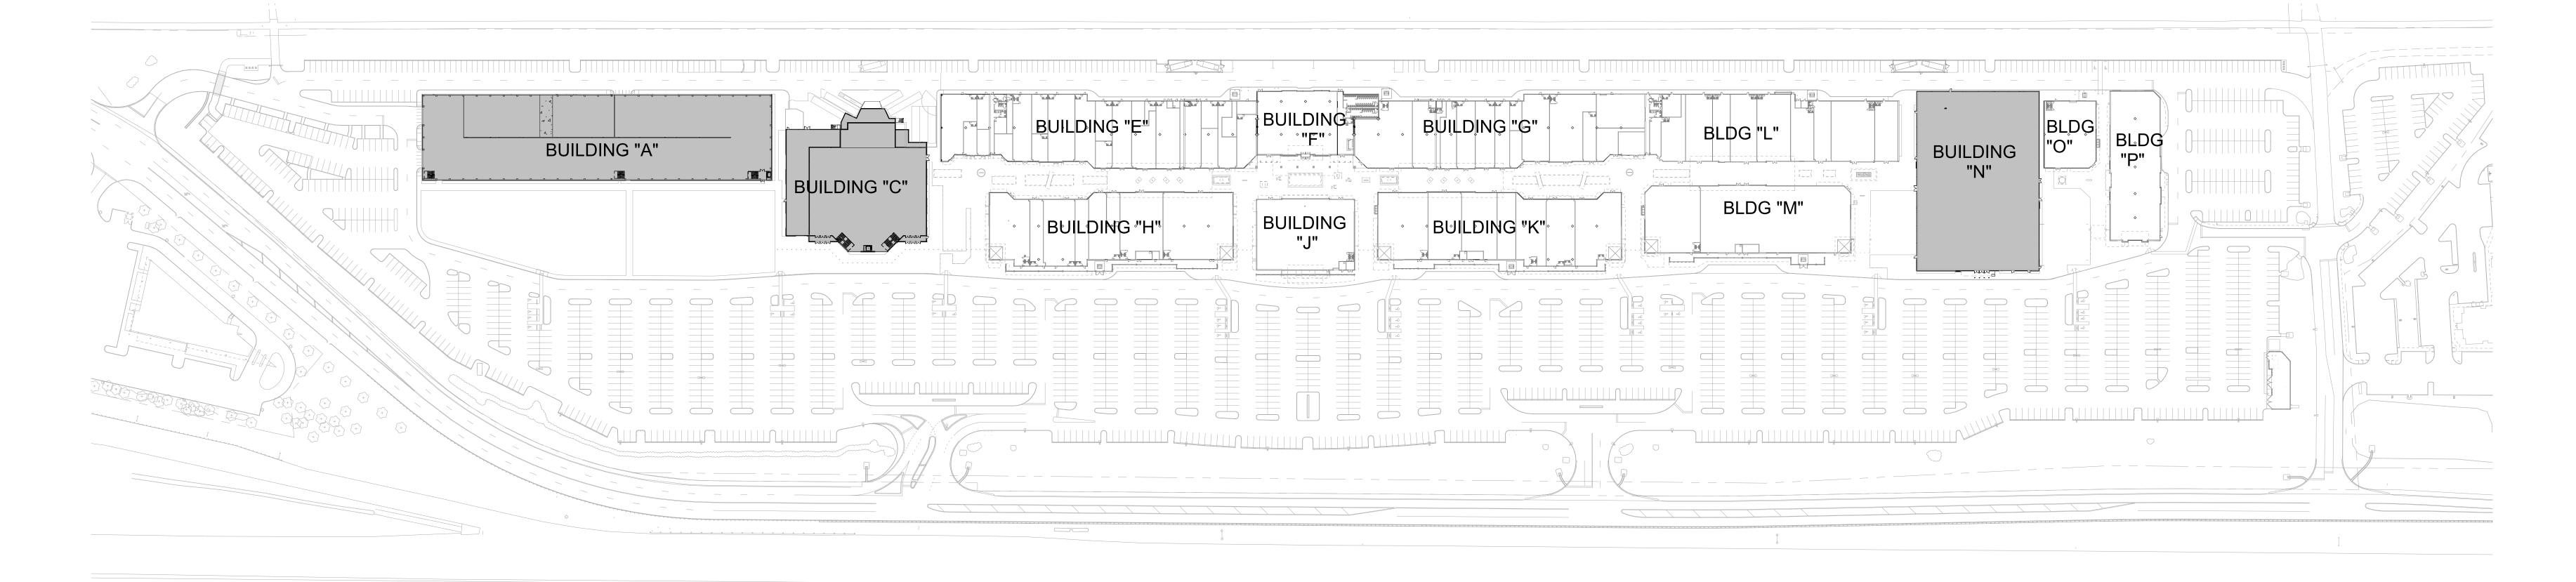


OVERALL SITE PLAN - PHASE 1

scale: 1" = 100'

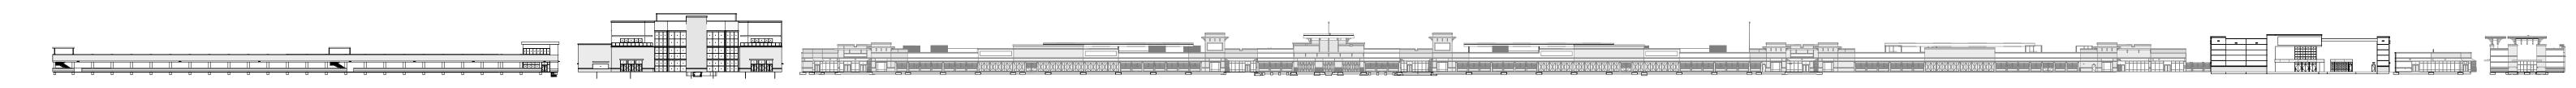


OVERALL SOUTH ELEVATION - PHASE 1

scale: 1" = 80'

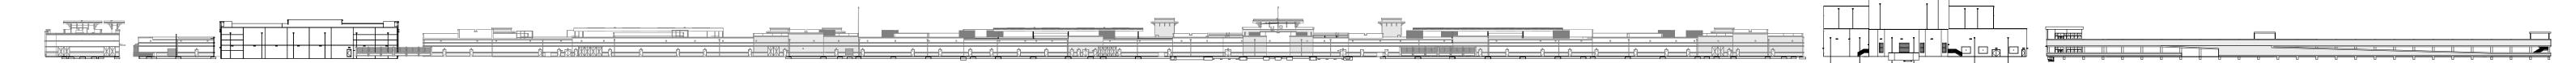


OVERALL NORTH ELEVATION - PHASE 1

scale: 1" = 80'

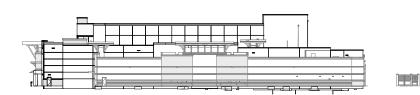

OVERALL EAST ELEVATION - PHASE 1

scale: 1" = 80'

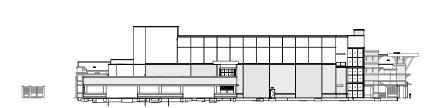

OVERALL EAST ELEVATION - PHASE 1

scale: 1" = 80'

Sheet Name: PHASE 1 - OVERALL PLAN & ELEVATIONS Date: AUGUST 16, 2019










TOP GOLF ON THE EAST SIDE OF THE DEVELOPMENT

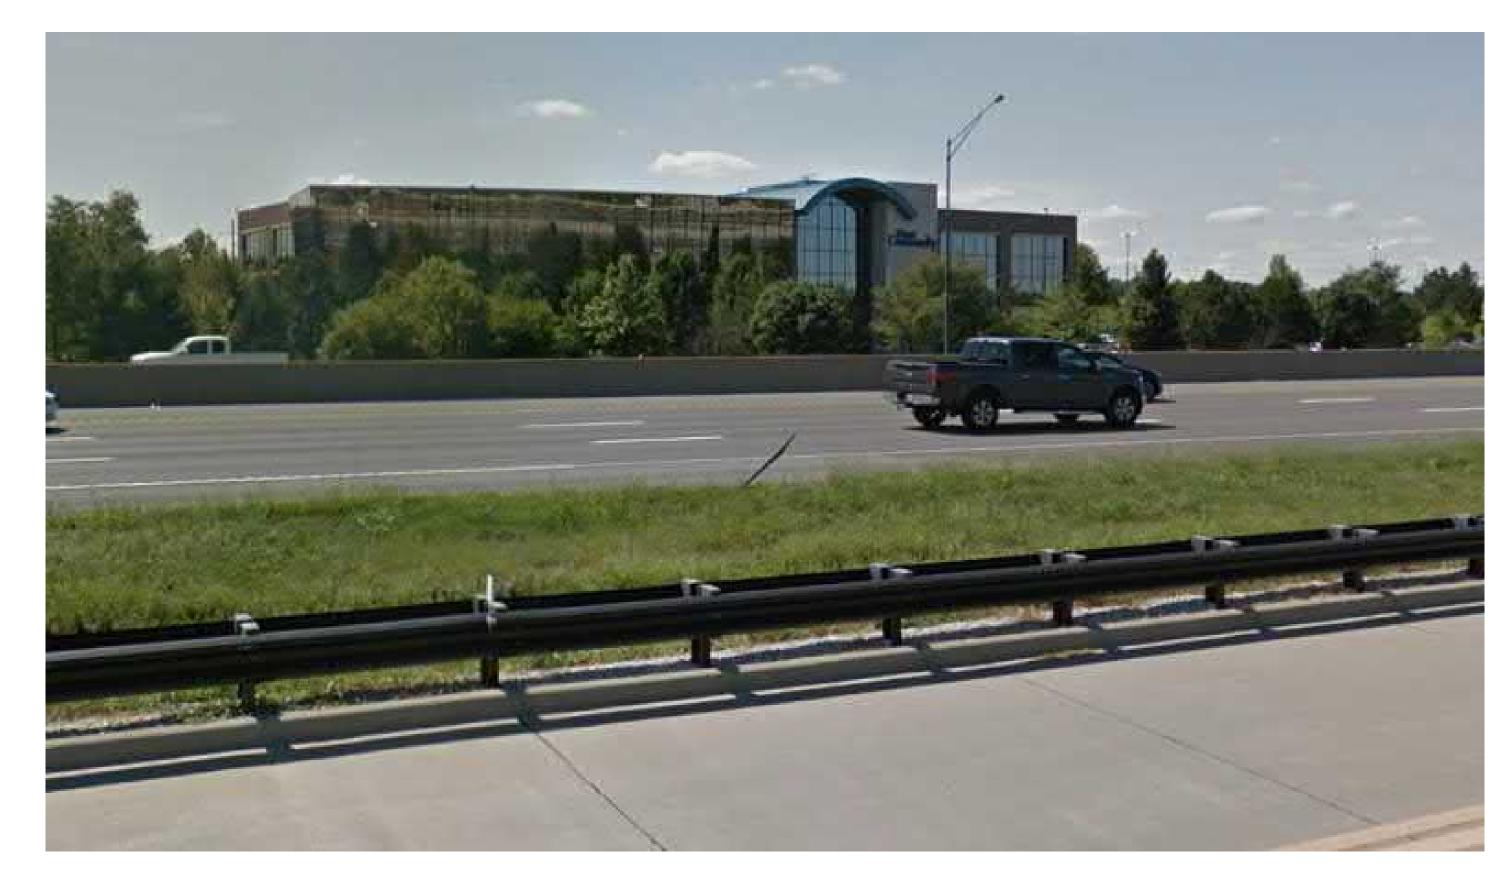

FIRST COMMUNITY BUILDING ACROSS HIGHWAY ON THE SOUTH SIDE OF THE DEVELOPMENT



BANK BUILDING ON THE WEST SIDE OF THE DEVELOPMENT

Sheet Name: SURRONDING AREA PHOTOGRAPHS Date: AUGUST 16, 2019







LOOKING SOUTHEAST FROM BACK DRIVE @ NEW BUILDING "A & C"



LOOKING EAST FROM EAST ENTRY @ NEW BUILDING "A"



LOOKING NORTH FROM FRONT DRIVE @ NEW BUILDING "N"



LOOKING NORTHEAST FROM FRONT DRIVE @ NEW BUILDING "A & C"




LOOKING NORTHWEST FROM FRONT DRIVE @ NEW BUILDING "C"




Date: AUGUST 16, 2019


Sheet Name: EXISTING SITE PHOTOGRAPHS



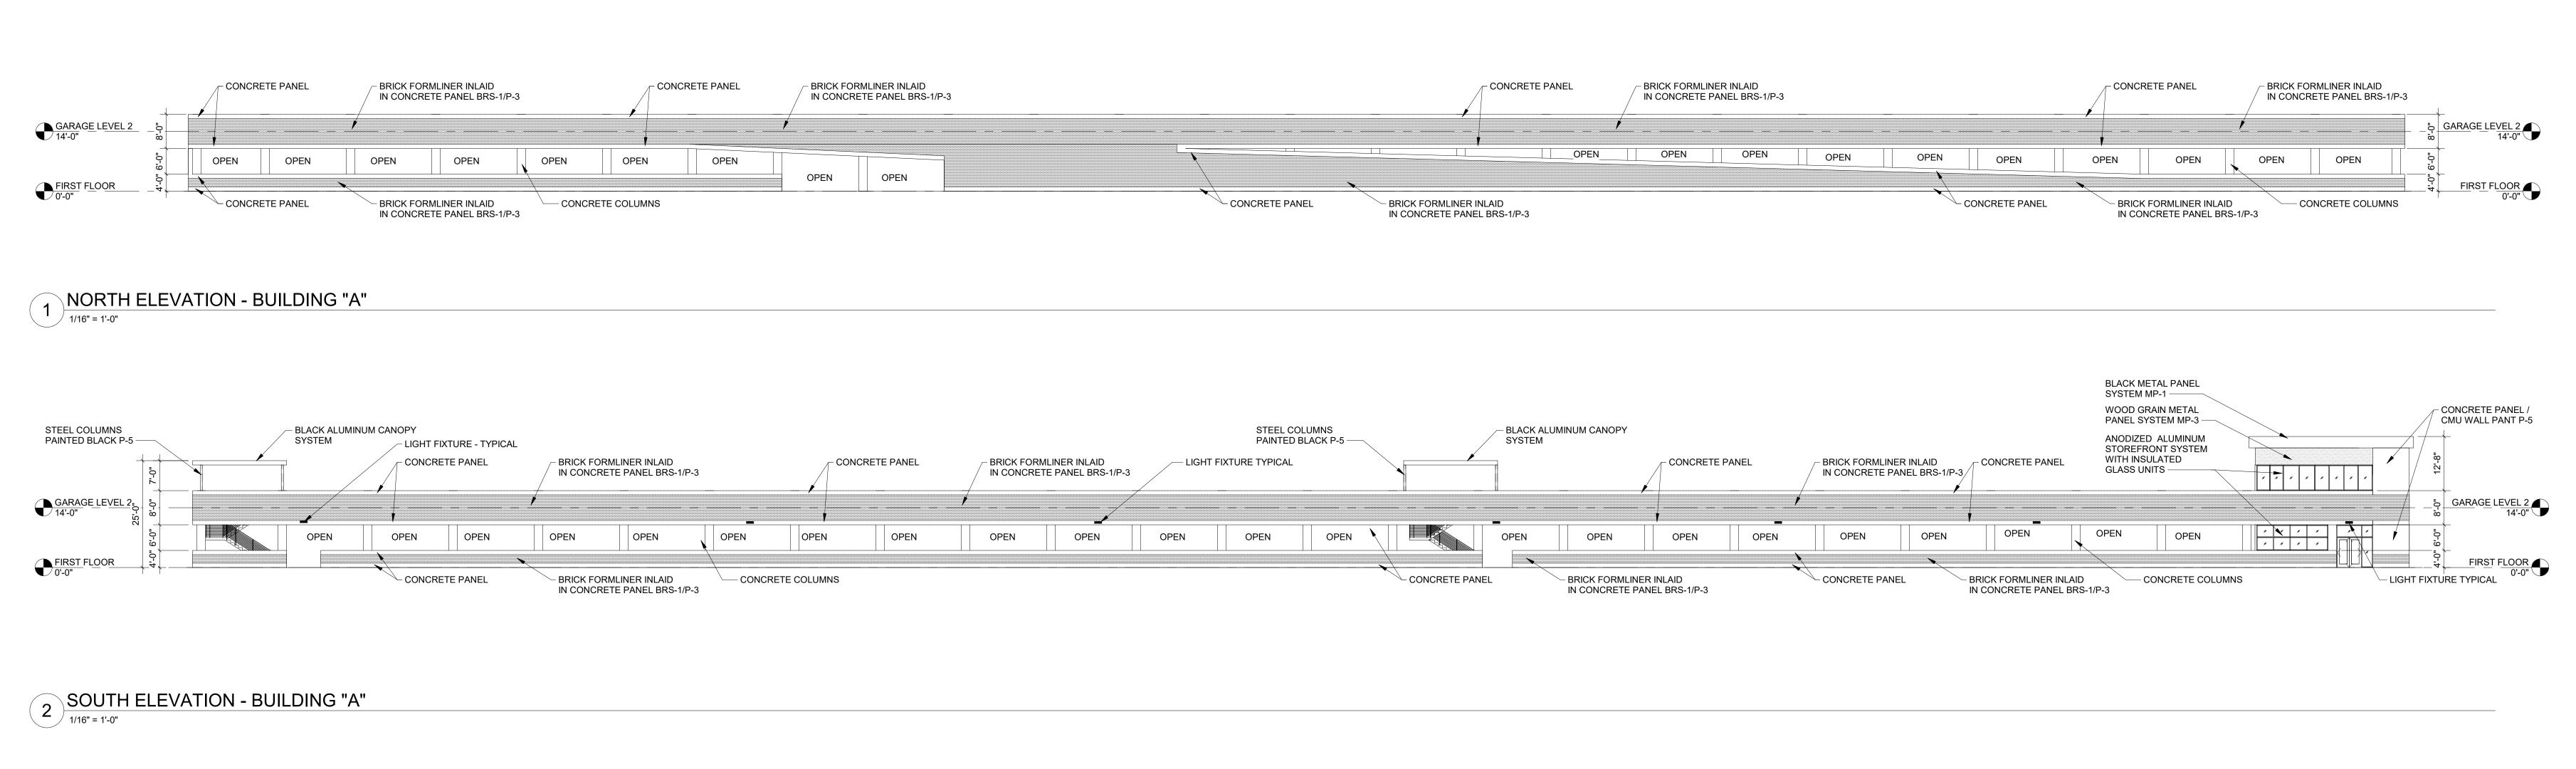

BLACK METAL PANEL
SYSTEM MP-1

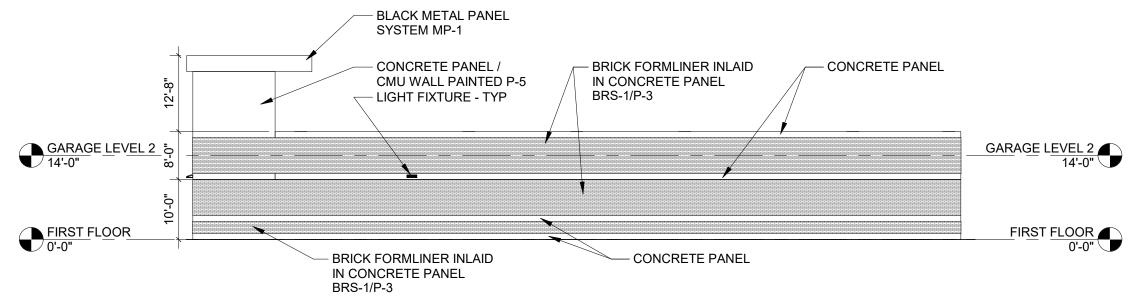

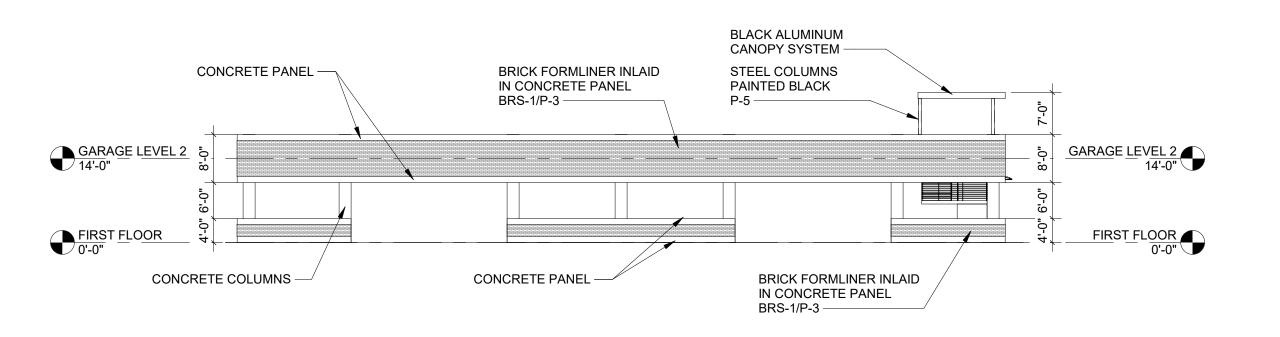

WEST ELEVATION - BUILDING "A"

1/16" = 1'-0"

EXTERIOR FINISH MATERIAL LEGEND - BUILDING A

BRS-1 BRICK STAMP PATTERN IN CONCRETE

PAINT - EXTERIOR PAINT SYSTEM
SHERWIN WILLIAMS CUSTOM COLOR #SANDLEWOOD BEIGE

PAINT - EXTERIOR PAINT SYSTEM
SHERWIN WILLIAMS CUSTOM COLOR #SAND DOLLAR

PAINT - EXTERIOR PAINT SYSTEM
BENJAMIN MOORE #2119-10 "SPACE BLACK"

METAL COPING SYSTEM


METAL PANEL SYSTEM
BLACK

METAL PANEL SYSTEM ROLLFAB ALUMABOARD 6" PLANK - LIGHT NATIONAL WALNUT TEXTURED

3 EAST ELEVATION - BUILDING "A"


1/16" = 1'-0"

THERE ARE NO ROOF TOP UNITS PLANNED FOR THIS BUILDING, THEREFORE THERE WILL BE NO UNITS THAT ARE REQUIRED TO BE SCREENED.

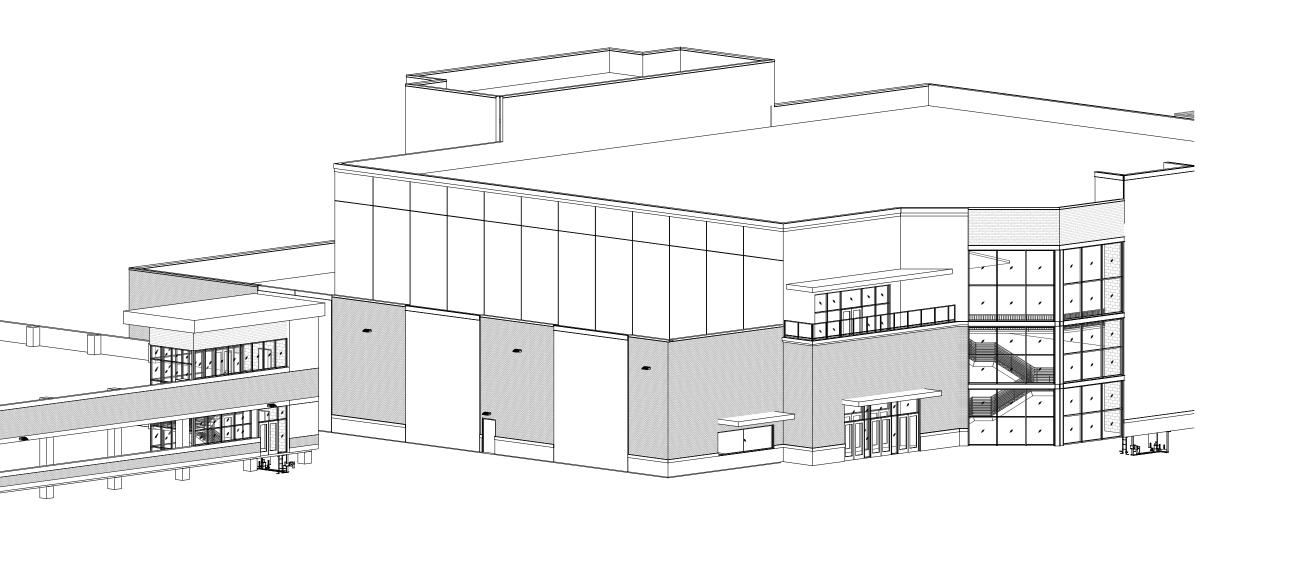



PERSPECTIVE VIEW



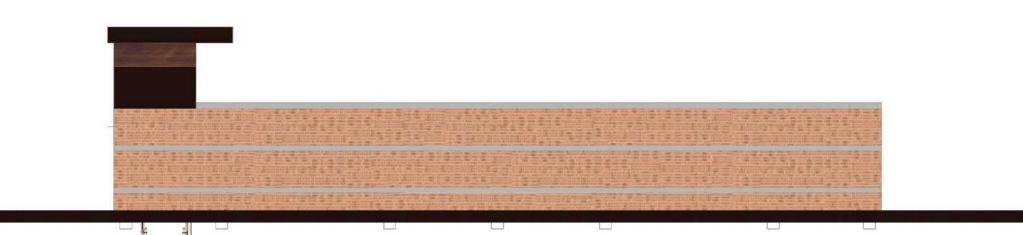

EAST ELEVATION

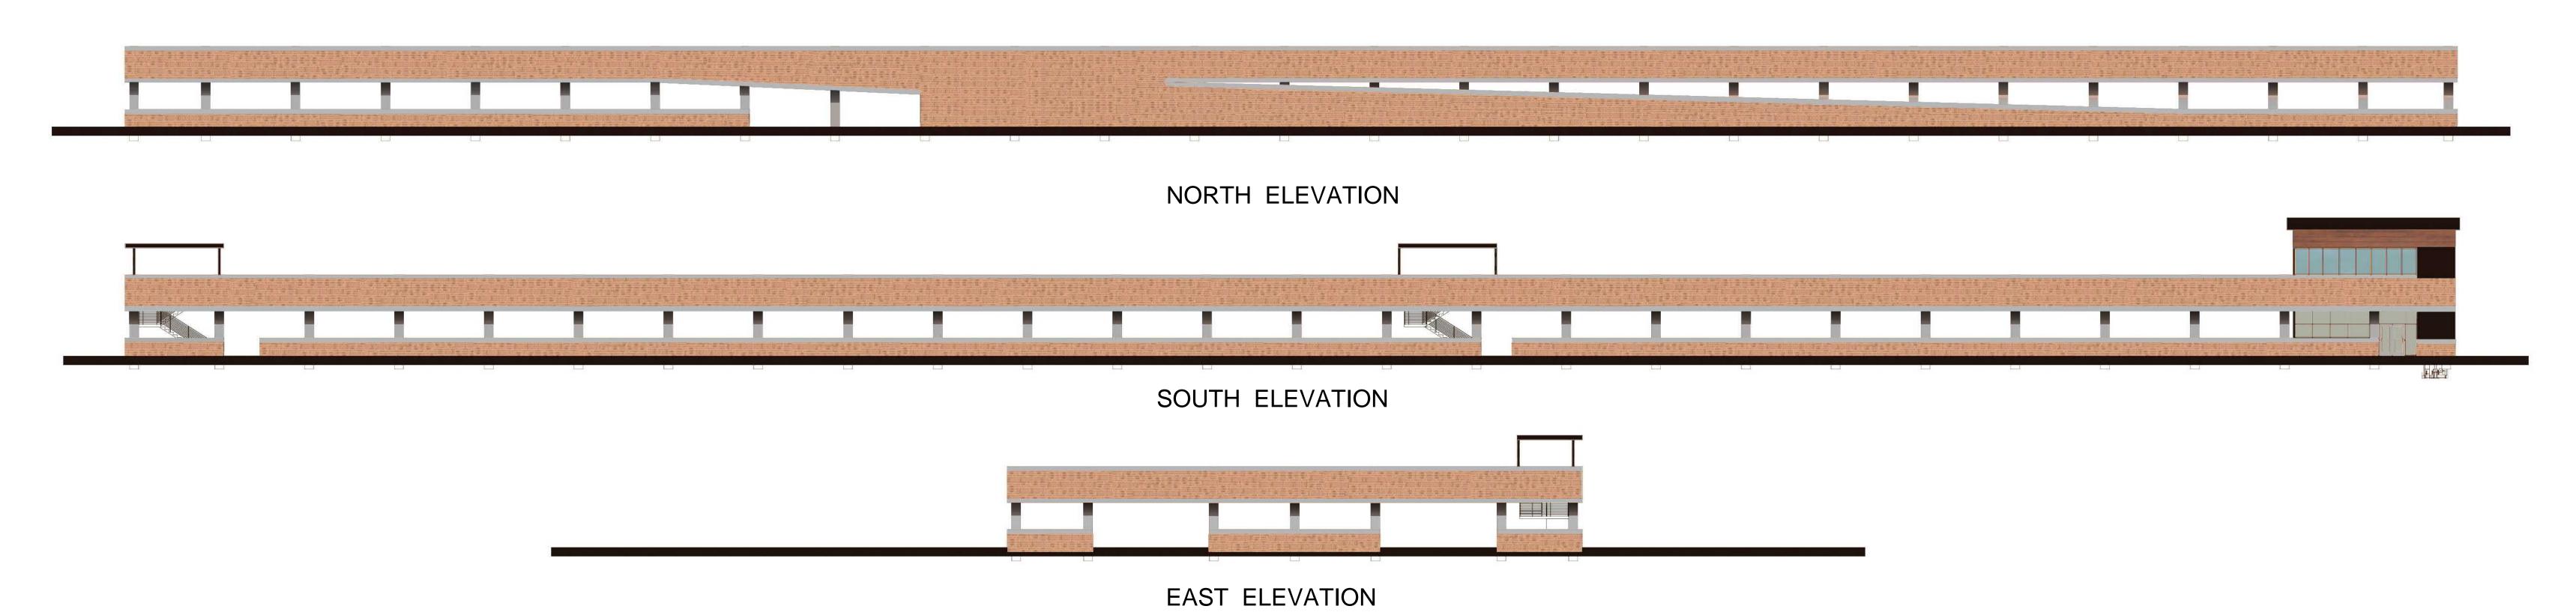

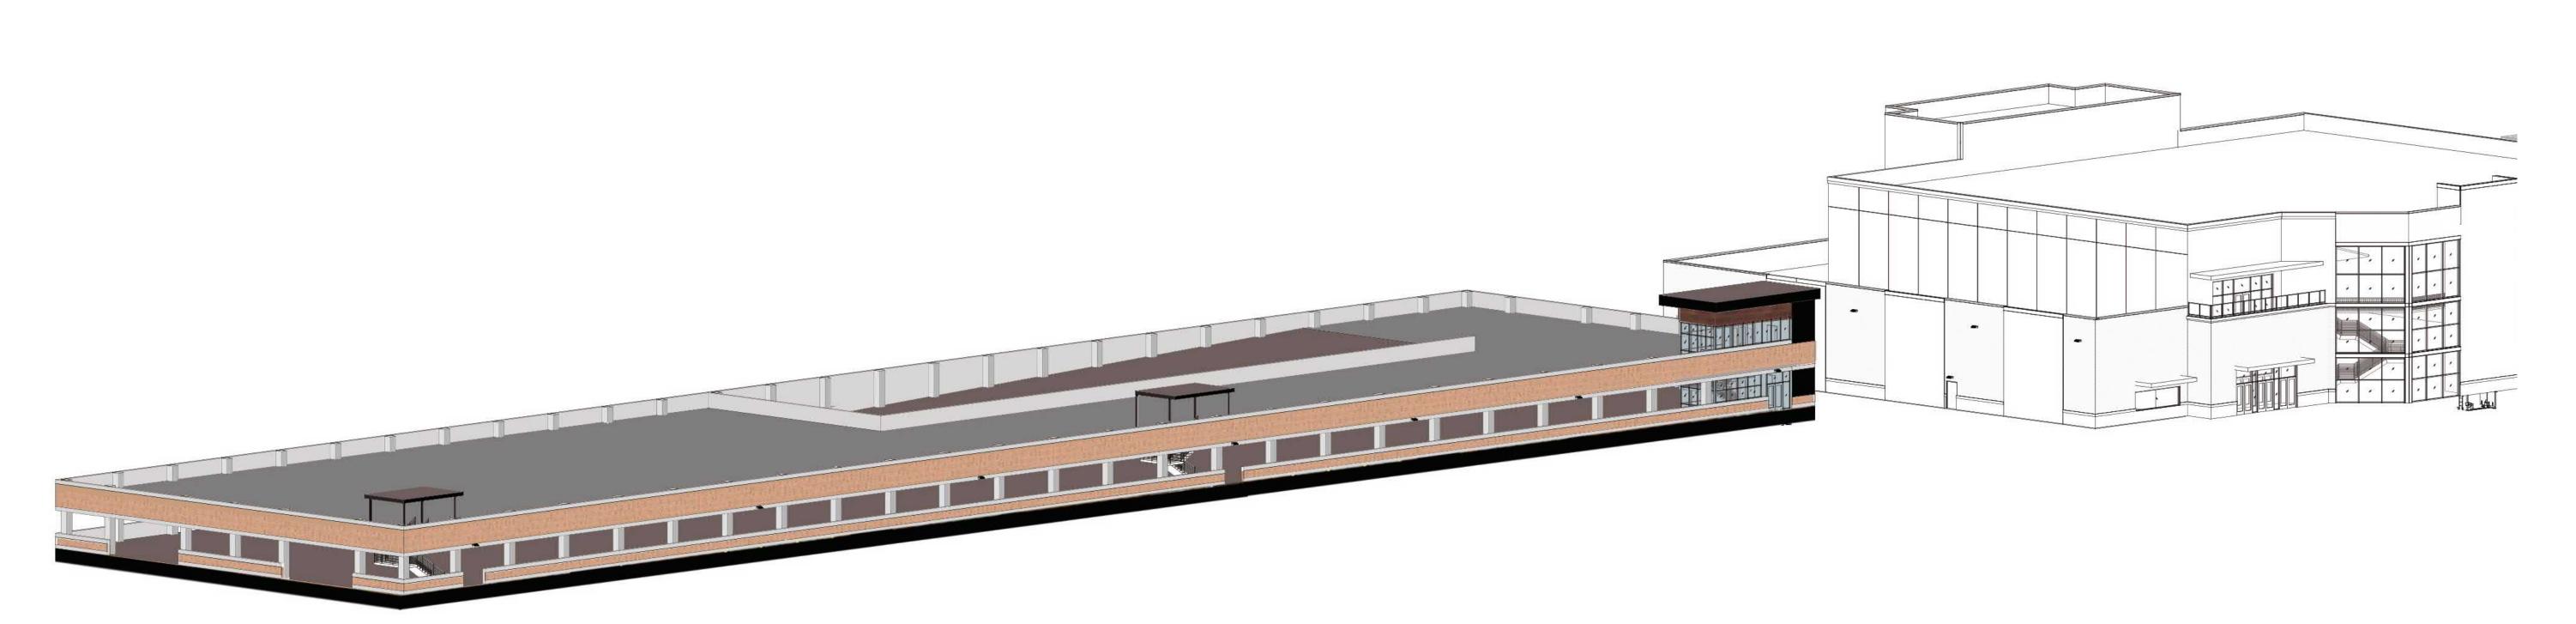

PERSPECTIVE VIEW

Sheet Name: COLOR ELEVATIONS - BLDG "A"


Date: AUGUST 16, 2019





Proposed Renonovation and Expansion 17057 North Outer 40 Road Chesterfield, Missouri 63005



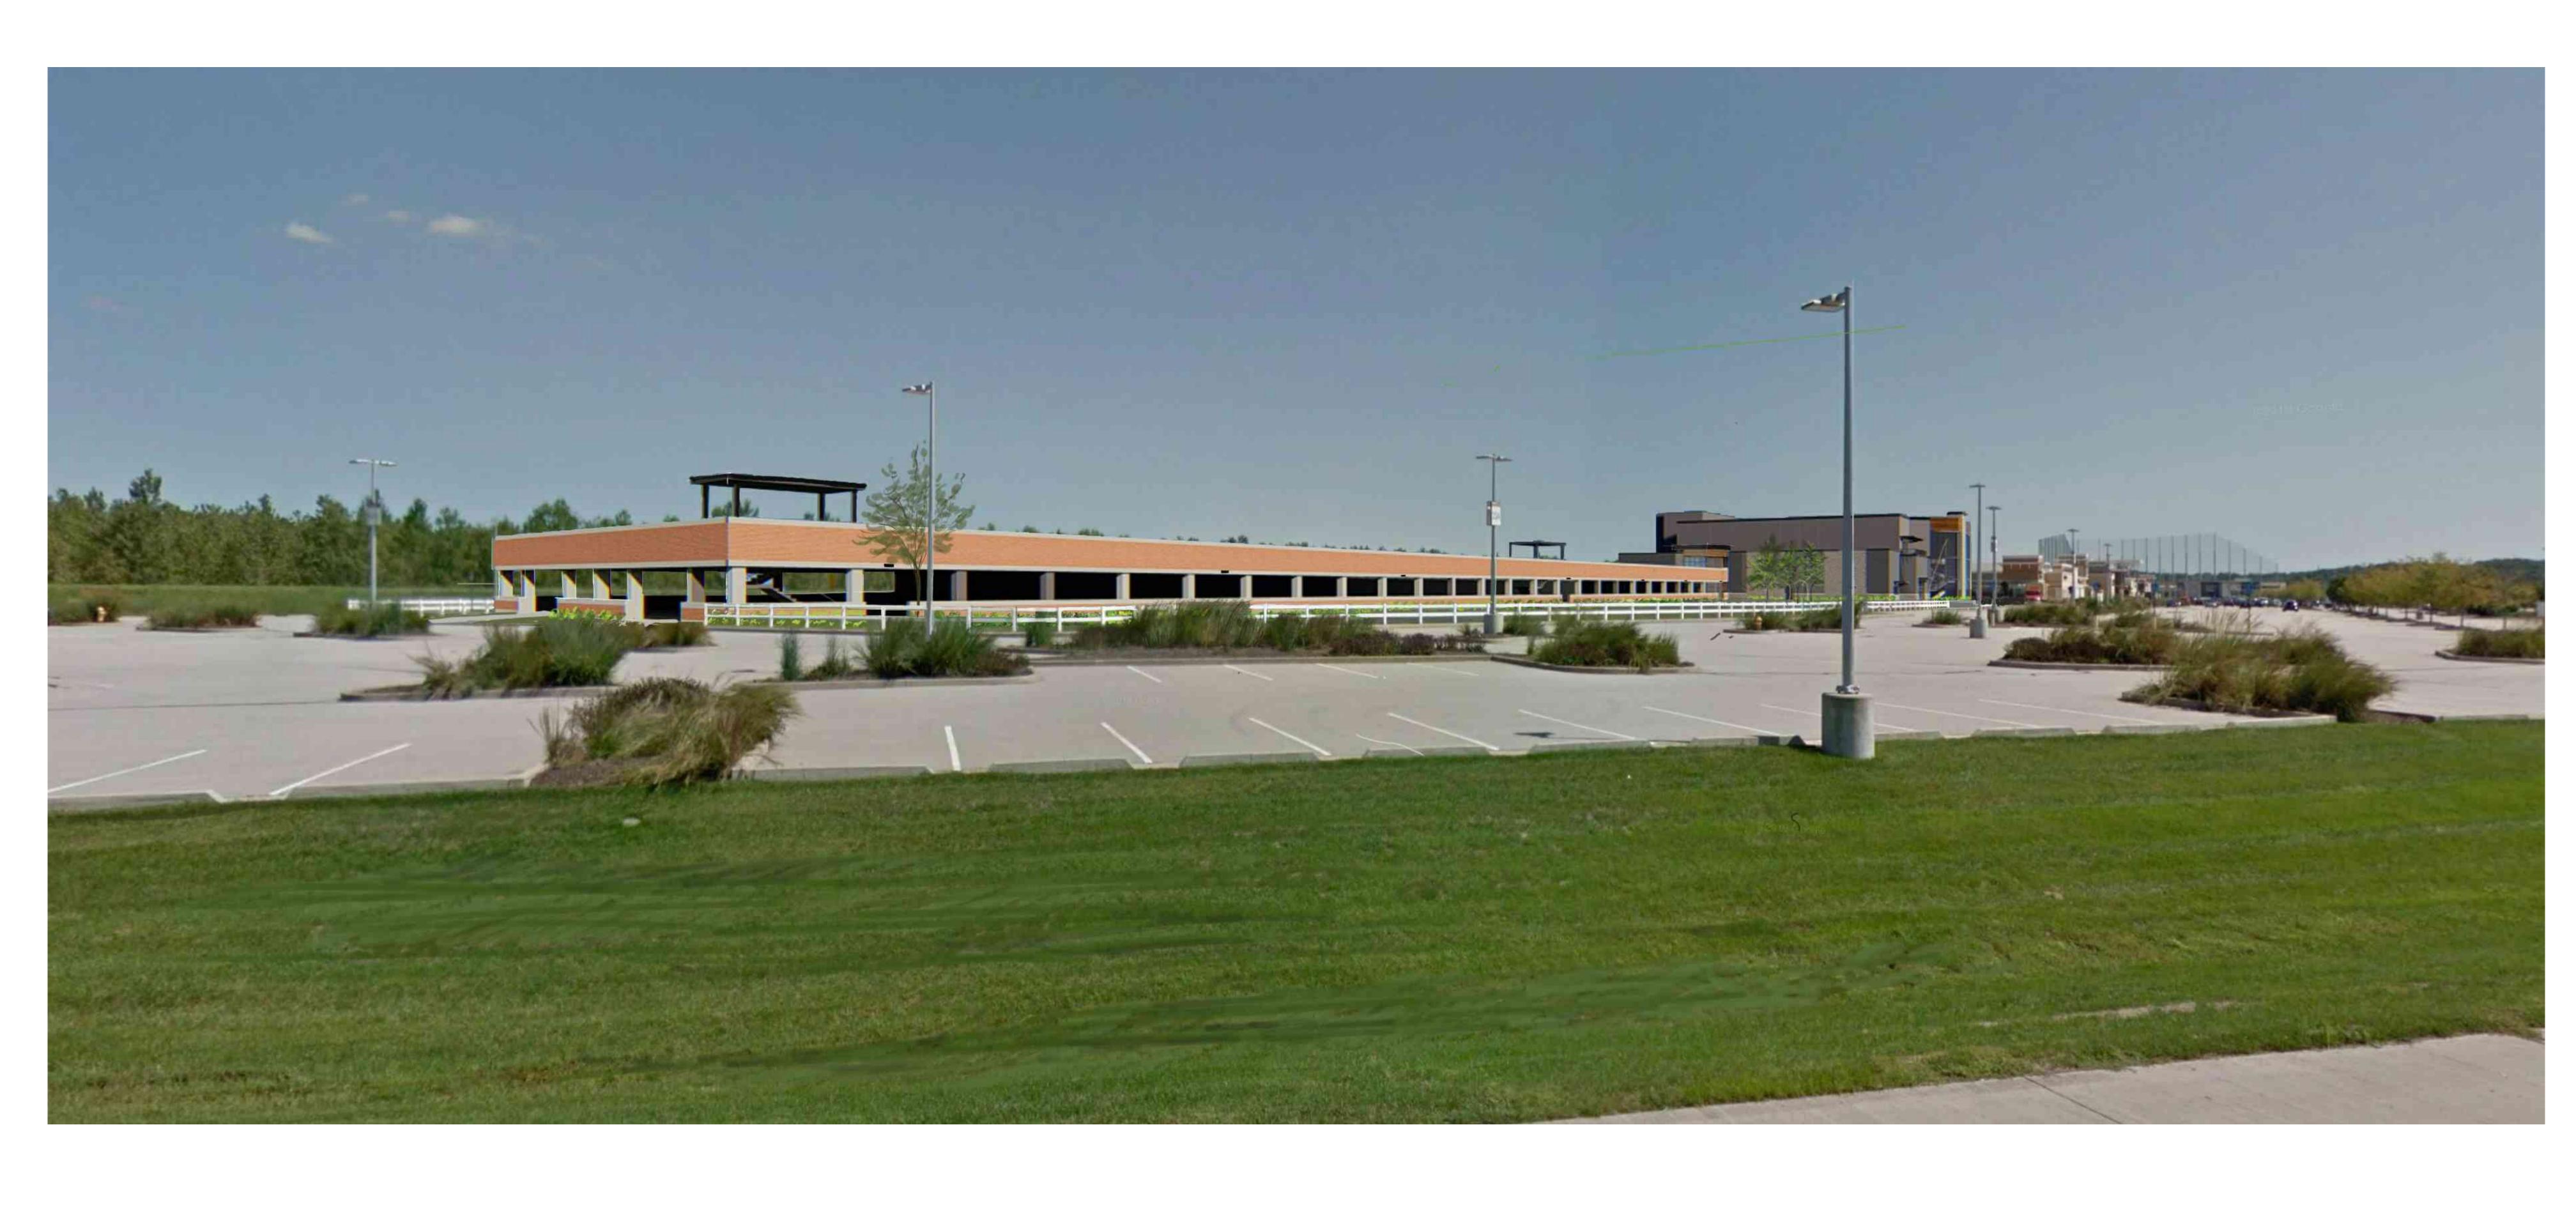

Sheet Name: RENDERING - BUILDING "A"


Date: AUGUST 16, 2019






Proposed Renonovation and Expansion 17057 North Outer 40 Road Chesterfield, Missouri 63005




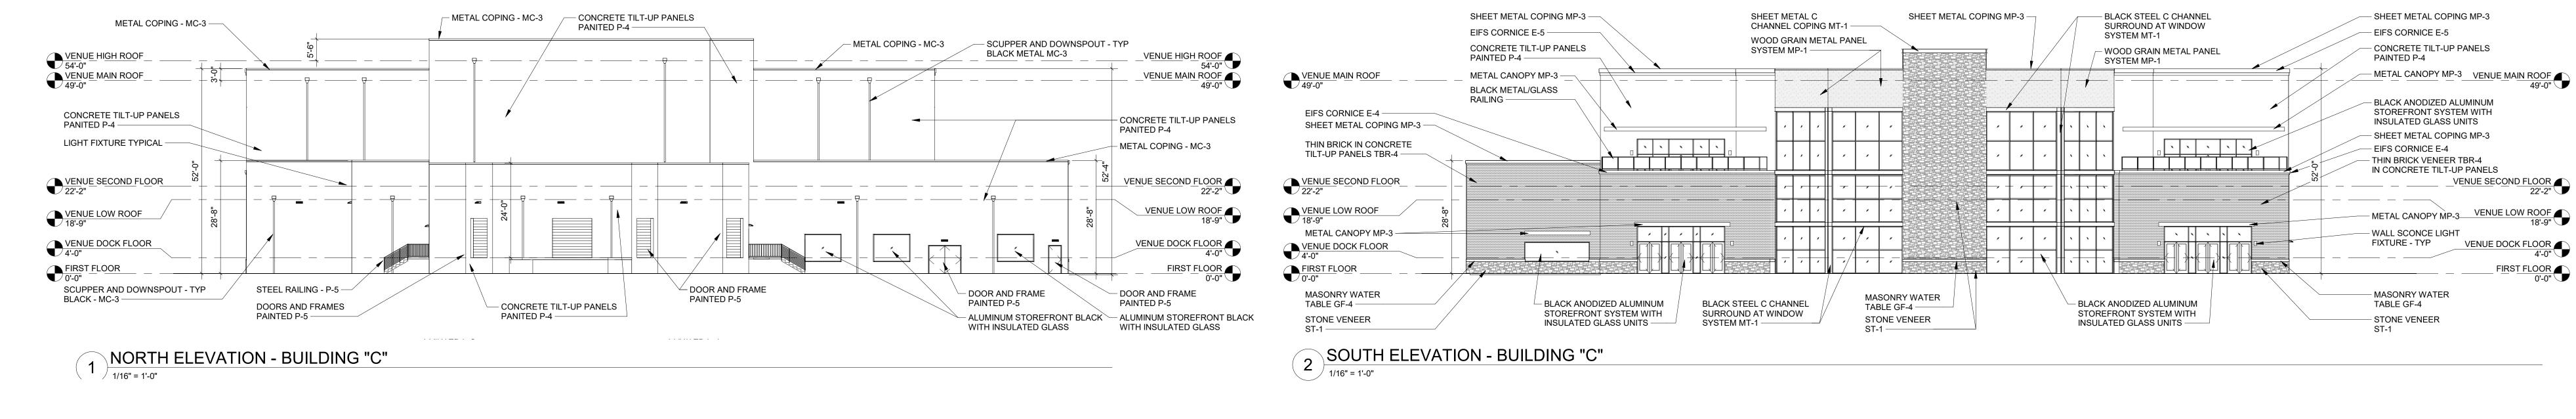

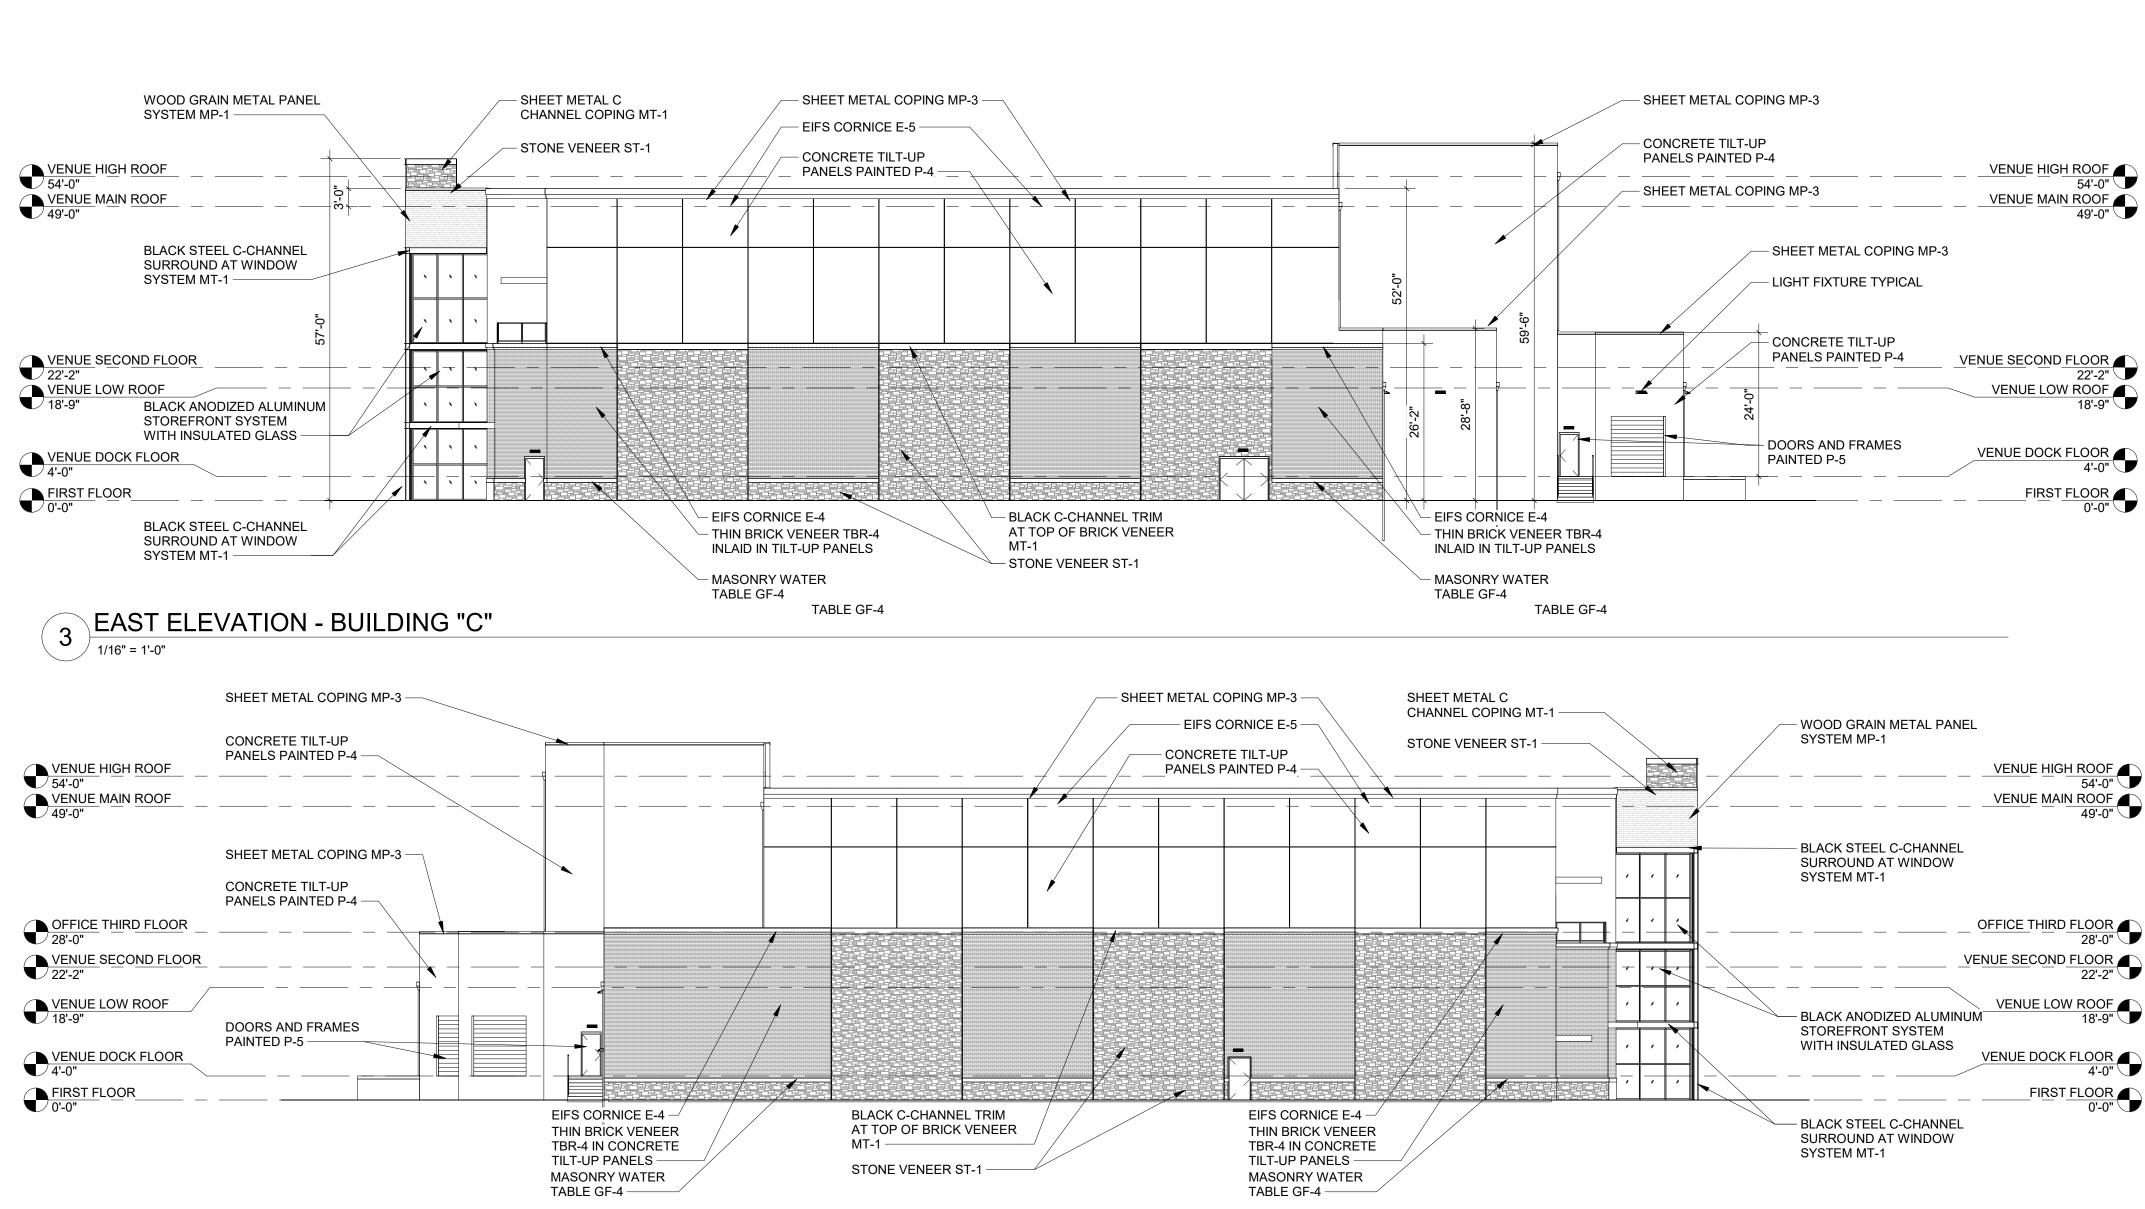


WEST ELEVATION - BUILDING "C"

1/16" = 1'-0"

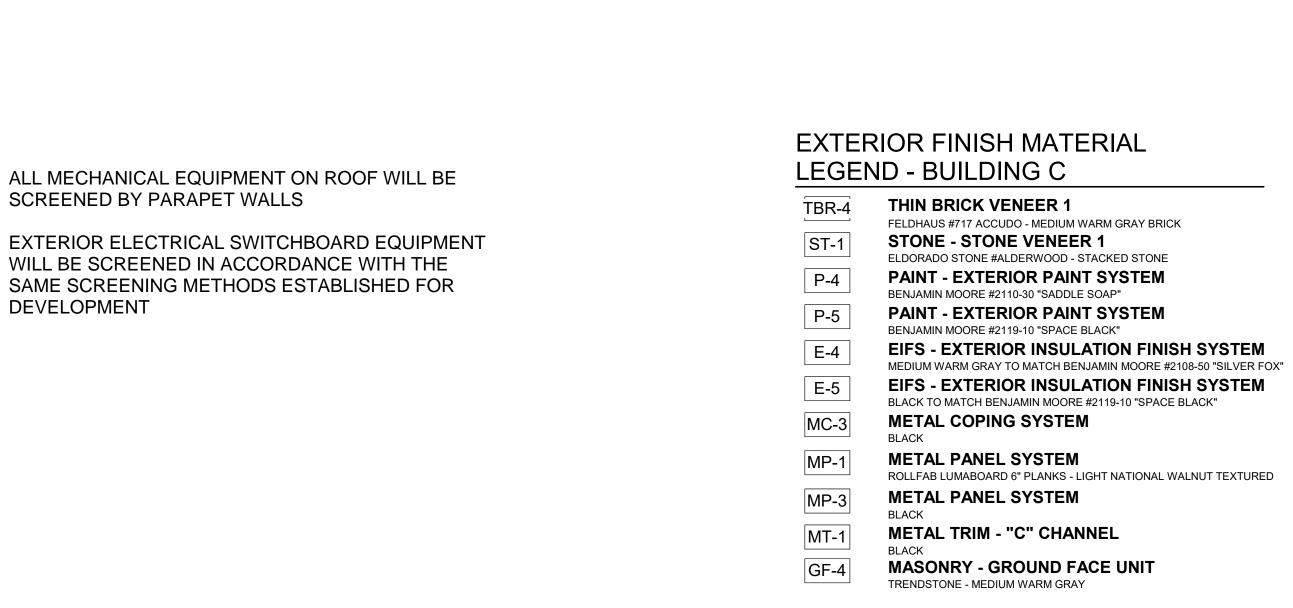




PERSPECTIVE VIEW - BUILDING "C"

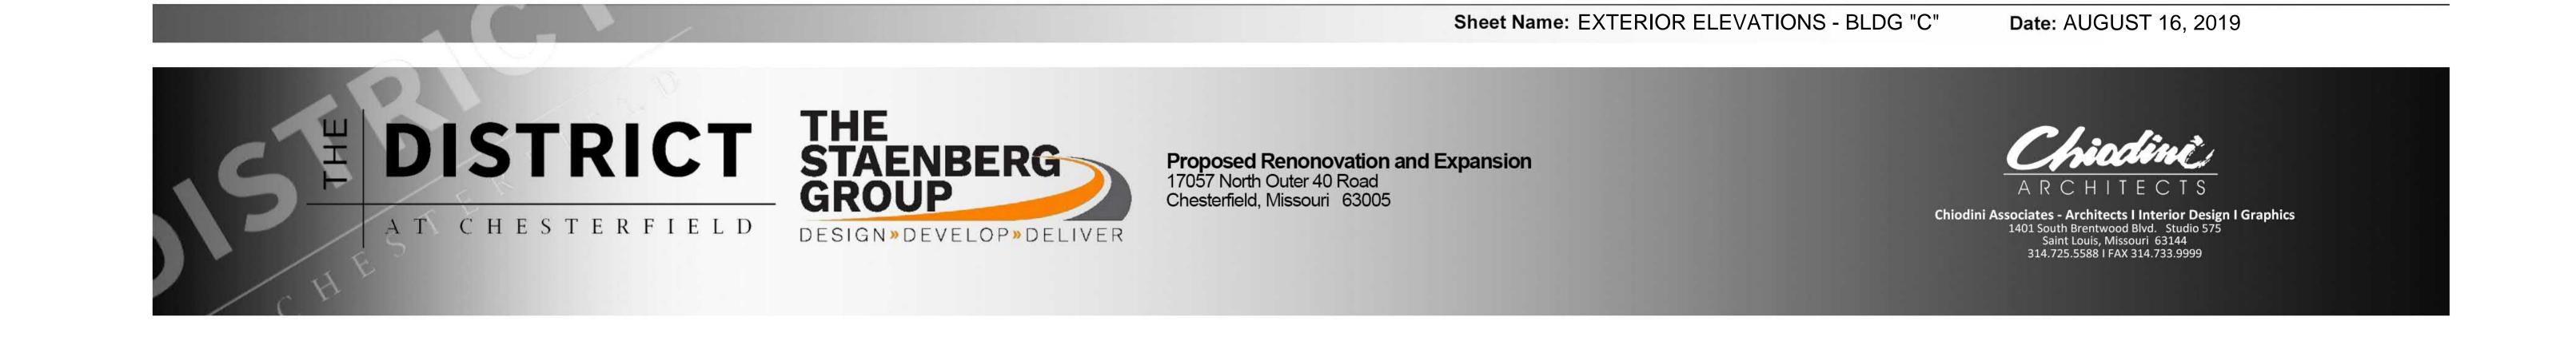




SOUTH ELEVATION

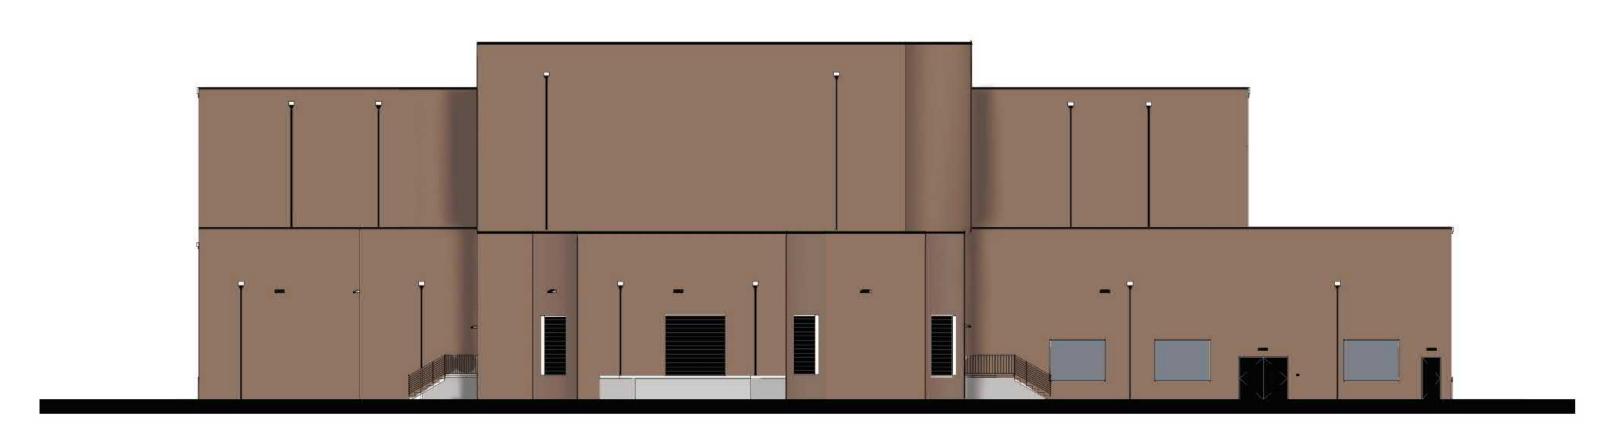

NORTH ELEVATION



EAST ELEVATION

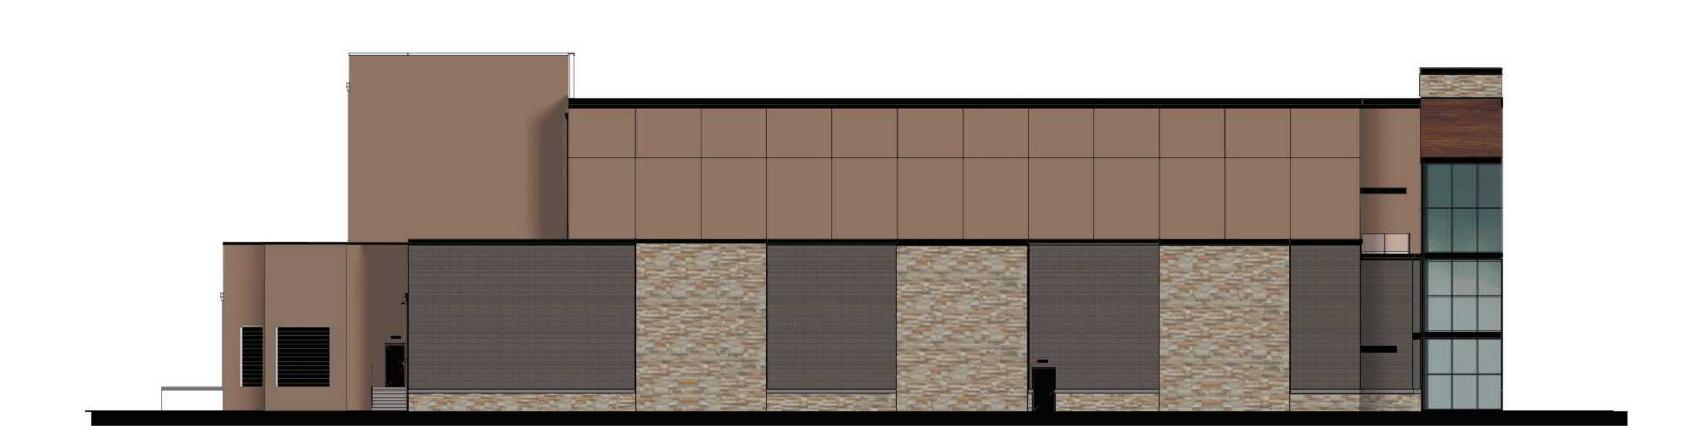

WEST ELEVATION



PERSPECTIVE VIEW

Sheet Name: COLOR ELEVATION - BLDG "C"

Date: AUGUST 16, 2019







Sheet Name: RENDERING - BUILDING "C"


Date: AUGUST 16, 2019






Proposed Renonovation and Expansion 17057 North Outer 40 Road Chesterfield, Missouri 63005



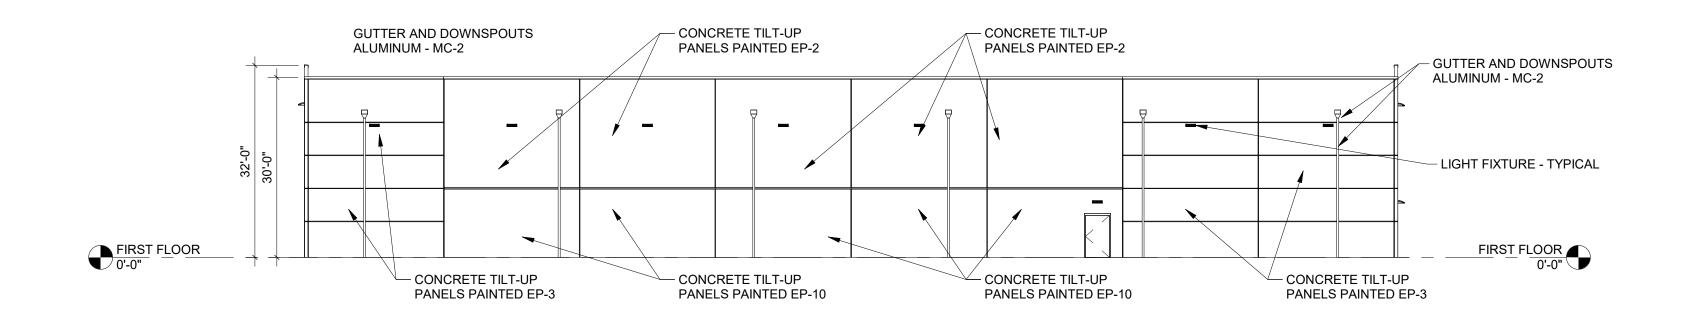


1 NORTH ELEVATION - BUILDING "N" 1/16" = 1'-0"

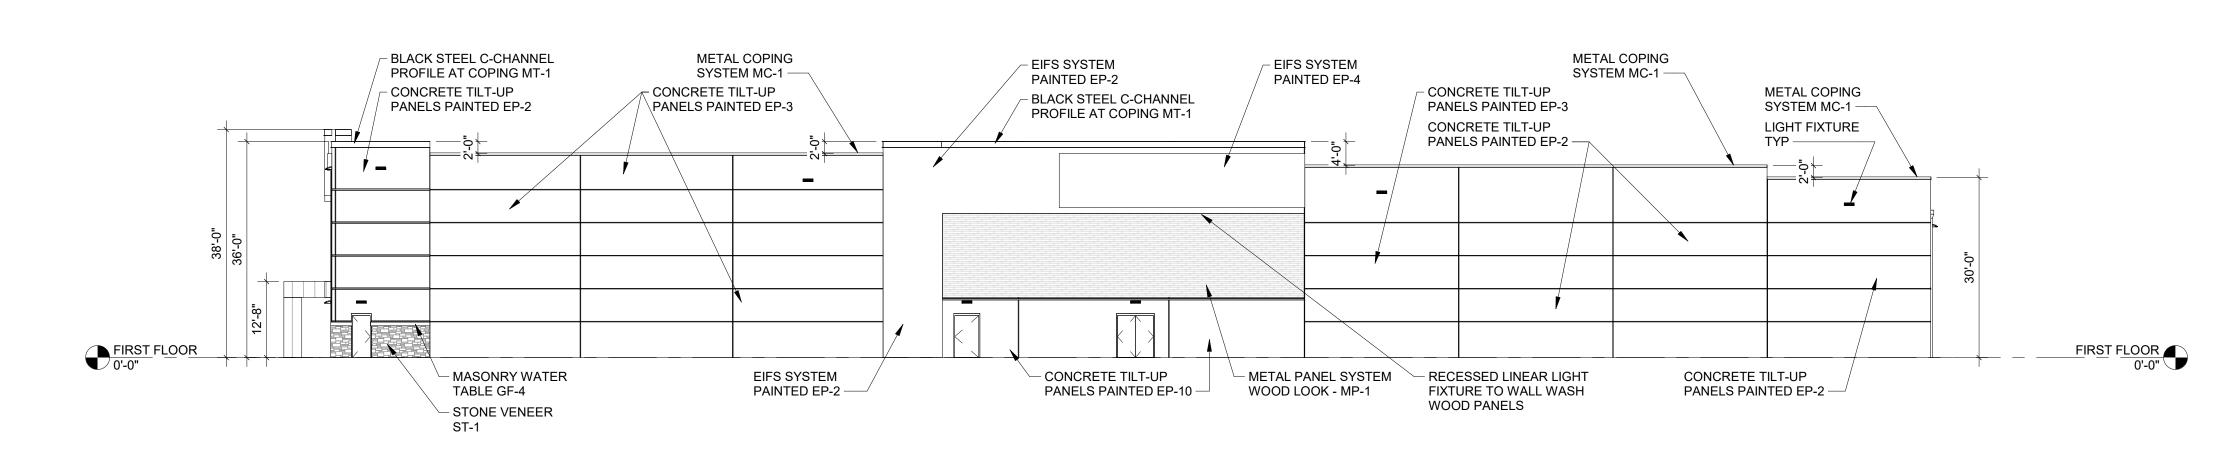


PERSPECTIVE VIEW

2 EAST ELEVATION - BUILDING "N"

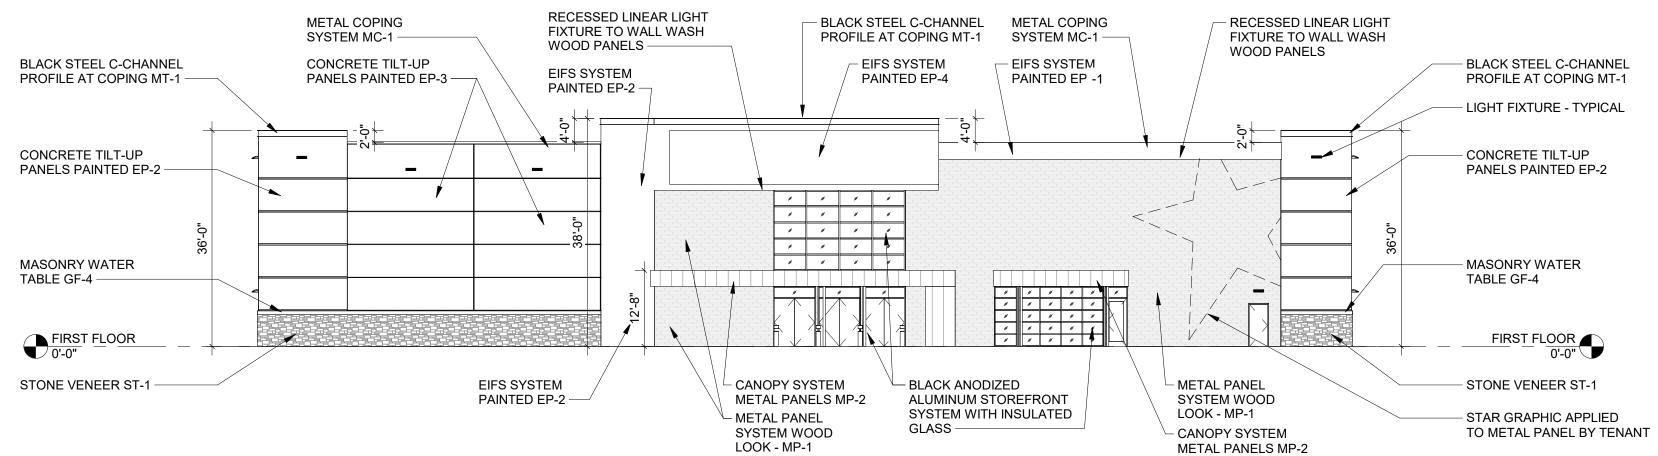

3 SOUTH ELEVATION - BUILDING "N"

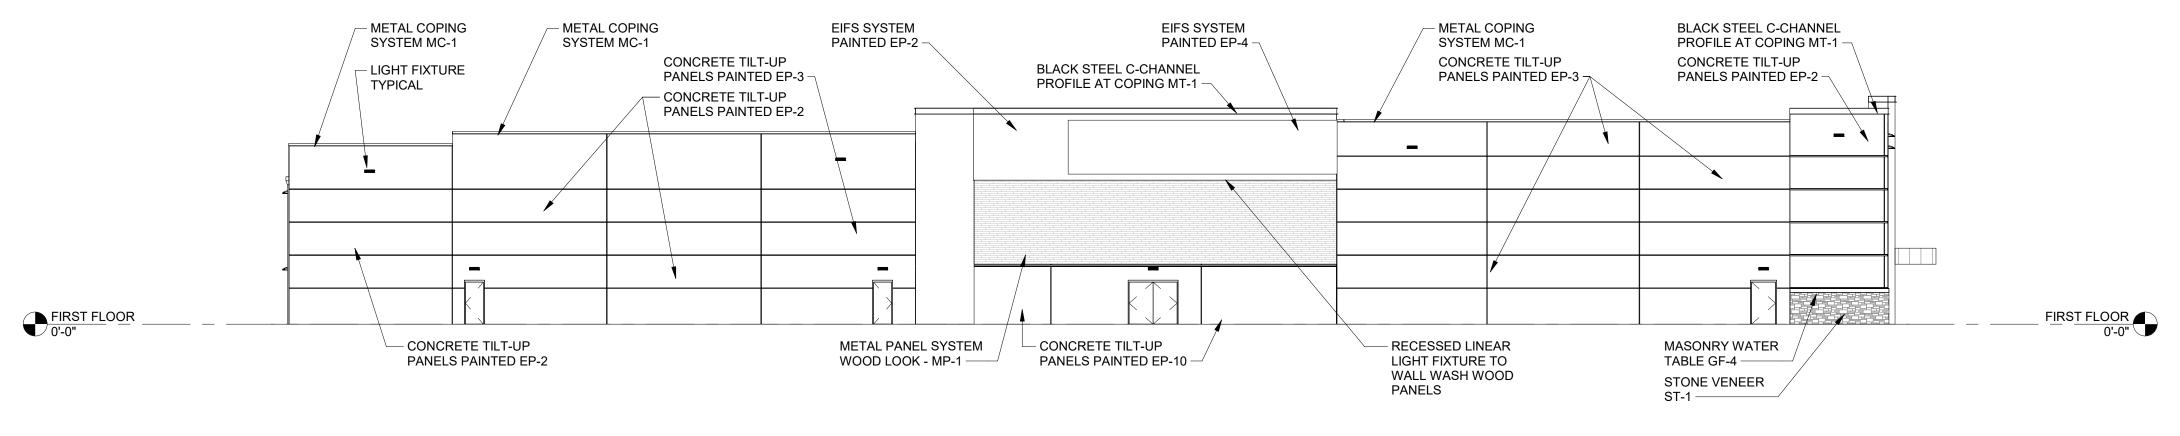

4 WEST ELEVATION - BUILDING "N"

1/16" = 1'-0"

ALL MECHANICAL EQUIPMENT ON ROOF WILL BE SCREENED BY PARAPET WALLS

EXTERIOR ELECTRICAL SWITCHBOARD EQUIPMENT WILL BE SCREENED IN ACCORDANCE WITH THE SAME SCREENING METHODS ESTABLISHED FOR **DEVELOPMENT**

EXTERIOR FINISH MATERIAL

LEGEND - BUILDING N

- STONE STONE VENEER 1
- ELDORADO STONE #ALDERWOOD PAINT - EXTERIOR PAINT SYSTEM
- SHOJI WHITE SW 7042 **PAINT - EXTERIOR PAINT SYSTEM**
- ACCESSIBLE BEIGE SW7036 PAINT - EXTERIOR PAINT SYSTEM
- VIRTUAL TAUPE SW7039 PAINT - EXTERIOR PAINT SYSTEM
- COBALT STONE PPG 1241-7 **PAINT - EXTERIOR PAINT SYSTEM**
- METAL COPING SYSTEM
- METAL SCUPPERS & DOWNSPOUTS

ROLLFAB - SUPER OAK TEXTURED

- BERRIDGE SIERRA TAN MP-1 **METAL PANEL SYSTEM**
- METAL PANEL SYSTEM ALPOLIC CFB BLUE
- METAL TRIM "C" CHANNEL
- MASONRY GROUND FACE UNIT TRENDSTONE MEDIUM WARM GRAY

Sheet Name: EXTERIOR ELEVATIONS - BLDG "N"

Date: AUGUST 16, 2019 REVISED AUGUST 28, 2019






Proposed Renonovation and Expansion 17057 North Outer 40 Road Chesterfield, Missouri 63005

Chiodini Associates - Architects I Interior Design I Graphics 1401 South Brentwood Blvd. Studio 575 Saint Louis, Missouri 63144 314.725.5588 I FAX 314.733.9999





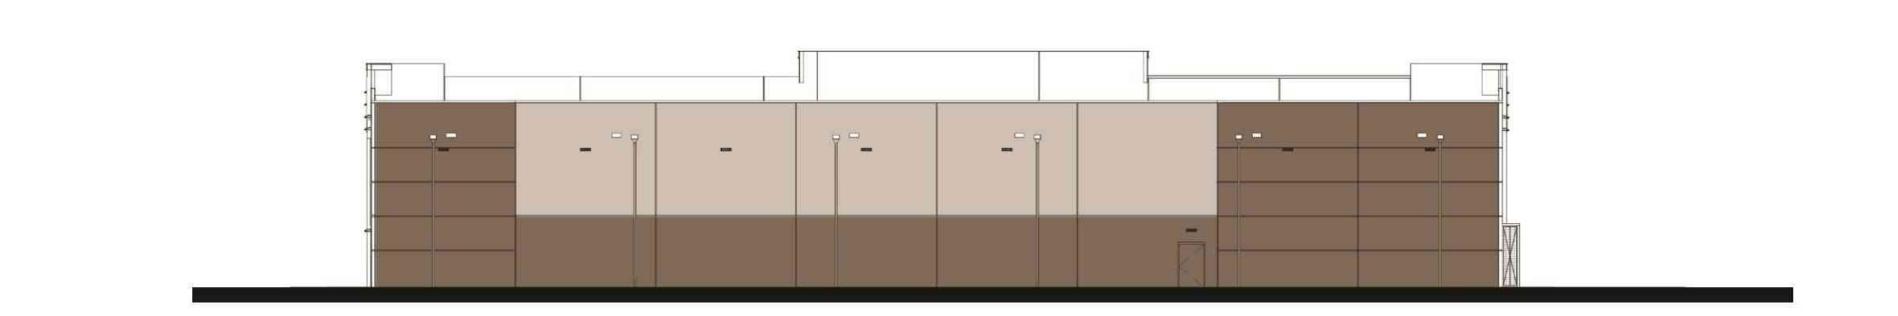



EAST ELEVATION



PERSPECTIVE VIEW

Sheet Name: COLOR ELEVATIONS - BLDG "N"

Date: AUGUST 16, 2019 REVISED AUGUST 28, 2019





Proposed Renonovation and Expansion 17057 North Outer 40 Road Chesterfield, Missouri 63005





Sheet Name: RENDERING - BUILDING "N"


Date: AUGUST 16, 2019





Proposed Renonovation and Expansion 17057 North Outer 40 Road Chesterfield, Missouri 63005




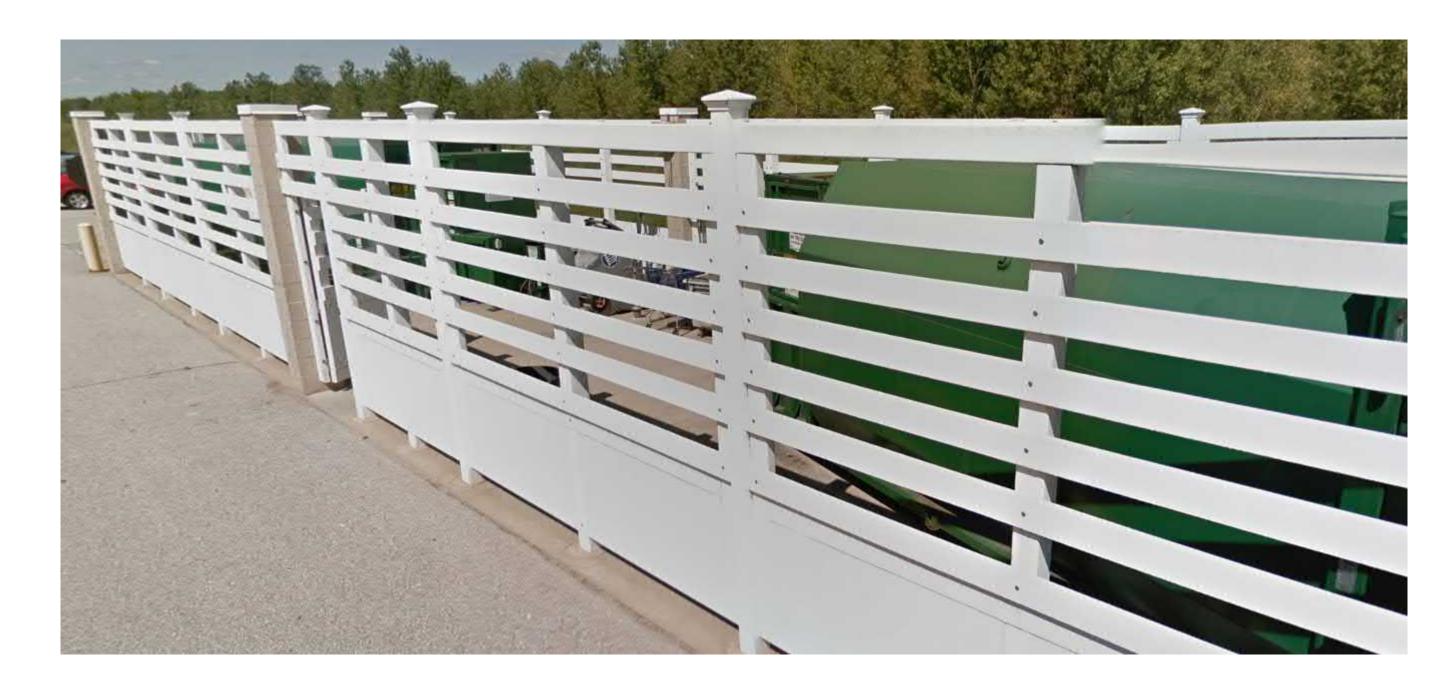

EXISTING SCREENING SYSTEM FOR TRASH ENCLOSURES



EXISTING SCREENING SYSTEM FOR SOUTH ELEVATION OF DEVELOPMENT AT UTILITY LOCATIONS

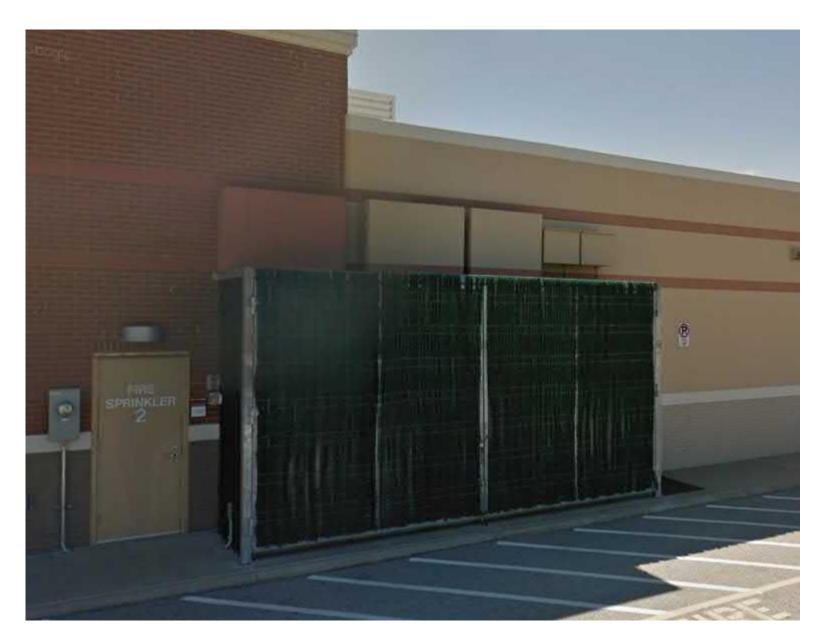

EXISTING SCREENING SYSTEM FOR ELECTRICAL **SWITCHGEAR**



EXISTING SCREENING SYSTEM FOR SANITARY PUMP STATION



EXISTING SCREENING SYSTEM FOR SOUTH ELEVATION OF DEVELOPMENT AT UTILITY LOCATIONS


ALL NEW SCREENING REQUIRED FOR DEVELOPMENT WILL MATCH THE EXISTING SCREENING SYSTEMS ESTABLISHED AND APPROVED FOR THE DEVELOPMENT


> Sheet Name: PHOTOGRAPHS - EXISTING SCREENING SYSTEMS


Date: AUGUST 16, 2019





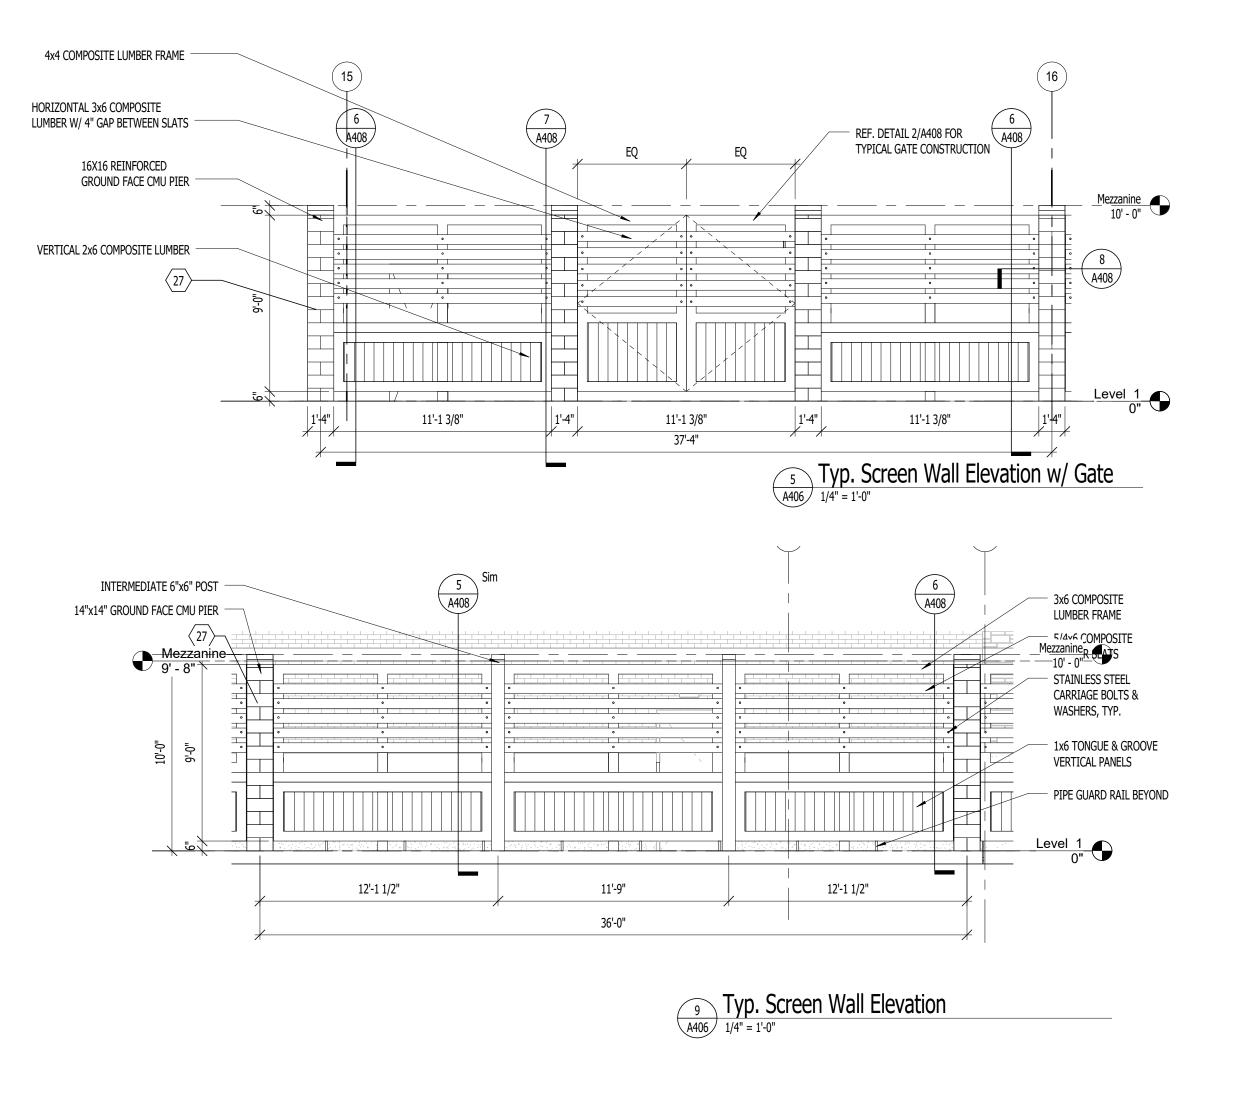

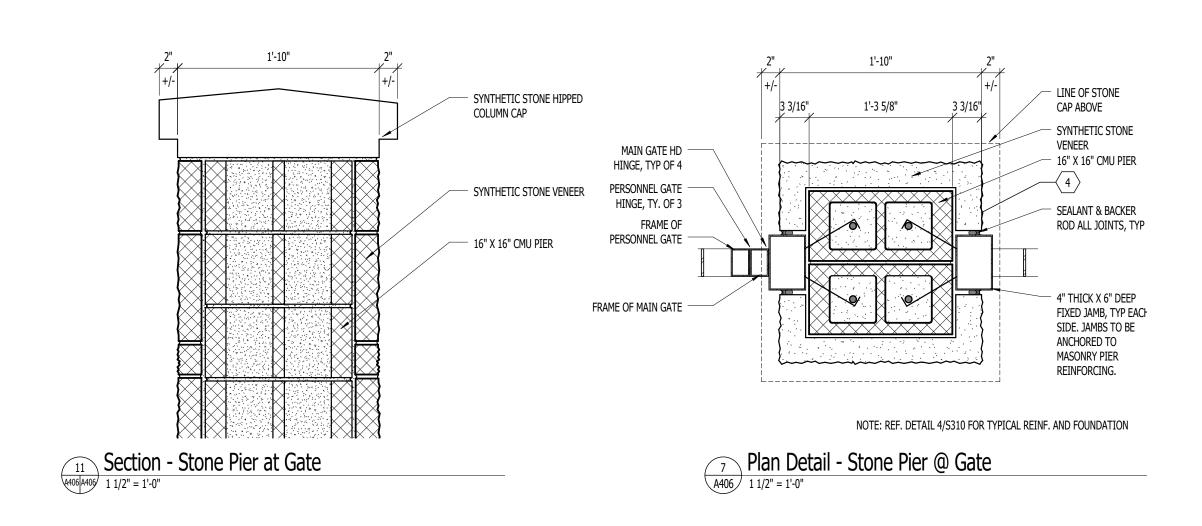

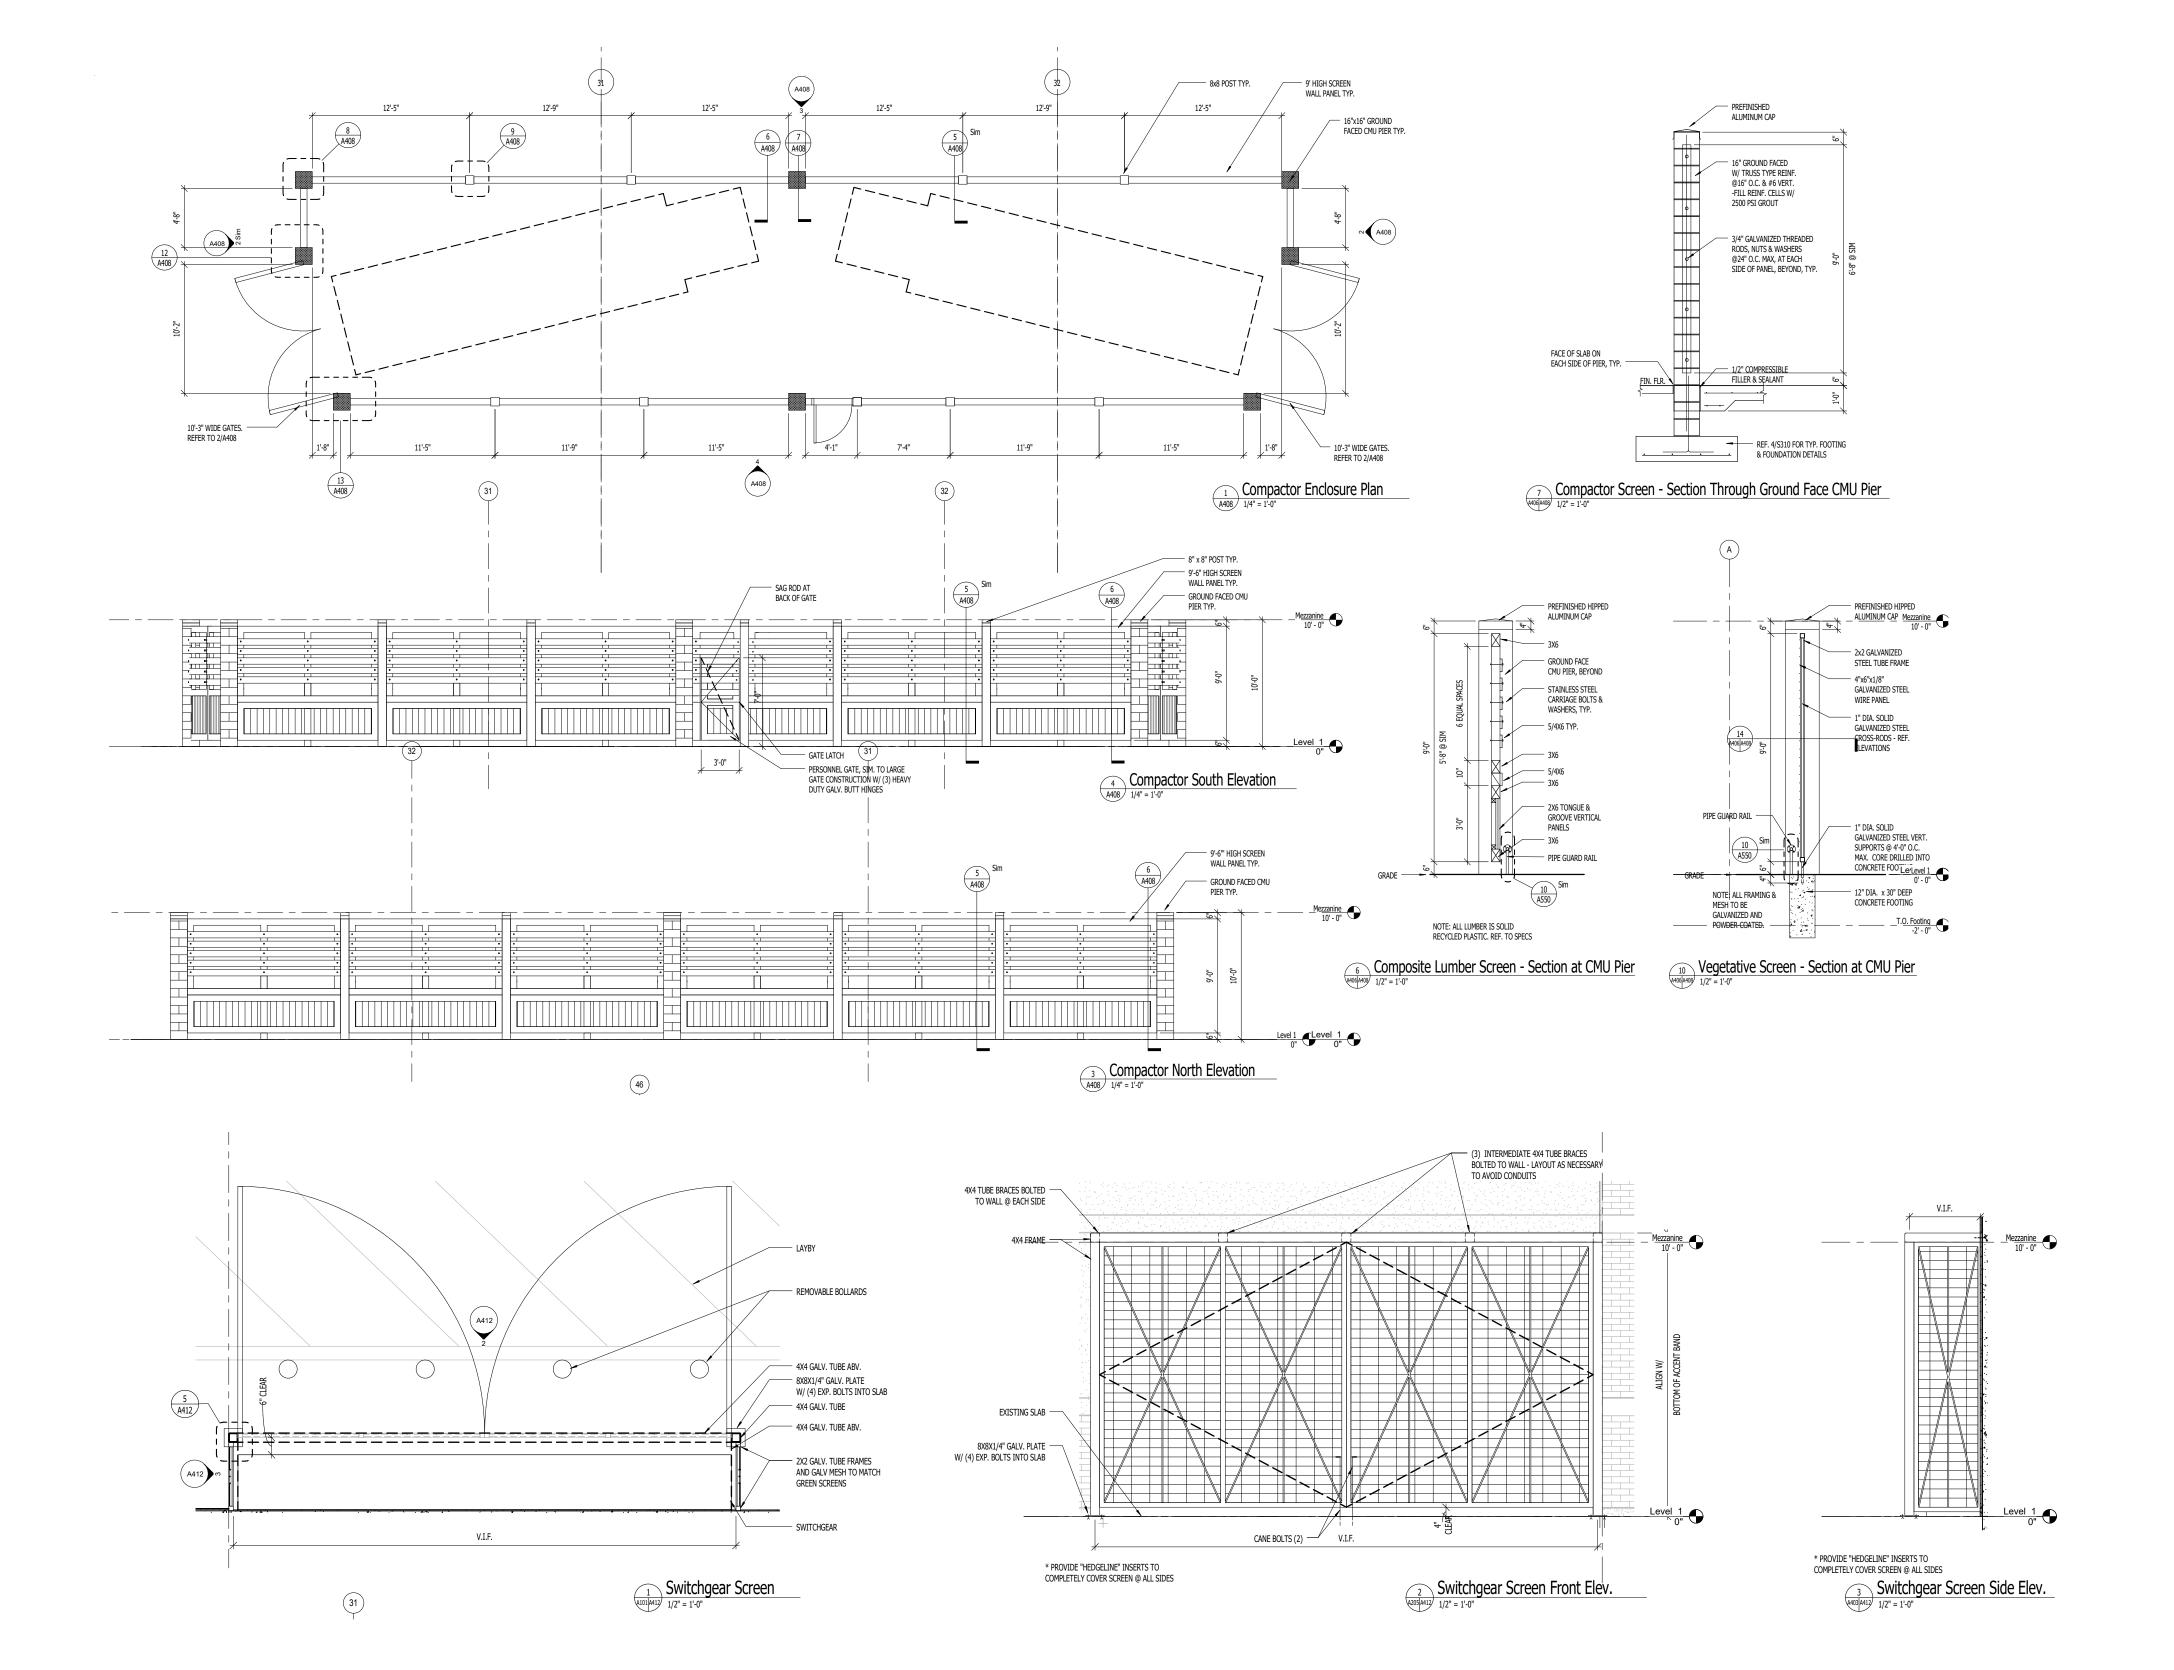

* ALL MECHANICAL EQUIPMENT ON THE ROOF WILL BE EITEHR SCREENED BY THE PARAPET WALLS OF THE BUILDING OR PER THE MECH SCREENWALL THAT EXISTS CURRENTLY IN THE DEVELOPMENT

CLOSURE/COPING BY MFR.

VERTICAL GIRTS BY SIDING MFR.

PRE FINISHED HORIZONTAL METAL SIDING

CLOSURE/COPING BY MFR.

BOTTOM CLOSURE BY MFR.

(REF. STRUCTURE)

TERMINATION BAR

Mech. Screenwall Detail

A552 1" = 1'-0"

DRAWING 3 - S410

- * ALL THE EXISTING TRASH ENCLOSURES WILL REMAIN AS SCREENED CURRENTLY WITHIN THE DEVELOPMENT, ANY NEW TRASH ENCLOSURES ADDED WILL BE SCREEN IN THE SAME MANNER AS THE EXISTING ENCLOSURES
- * ALL EXISTING MAIN DISTRIBUTION ELECTRICAL **BOARDS CURRENTLY SCREEN ON TEH** DEVELOPMENT WILL REMAIN SCREEN AND ANY NEW MAIN ELECTRICAL DISTRIBUTION BOARDS WILL BE SCREEN IN THE SAME MANNER AS TEH **EXISTING ENCLOSURES**

Sheet Name: SCREENING @ RTU'S & TRASH


Date: AUGUST 16, 2019





Proposed Renonovation and Expansion 17057 North Outer 40 Road Chesterfield, Missouri 63005



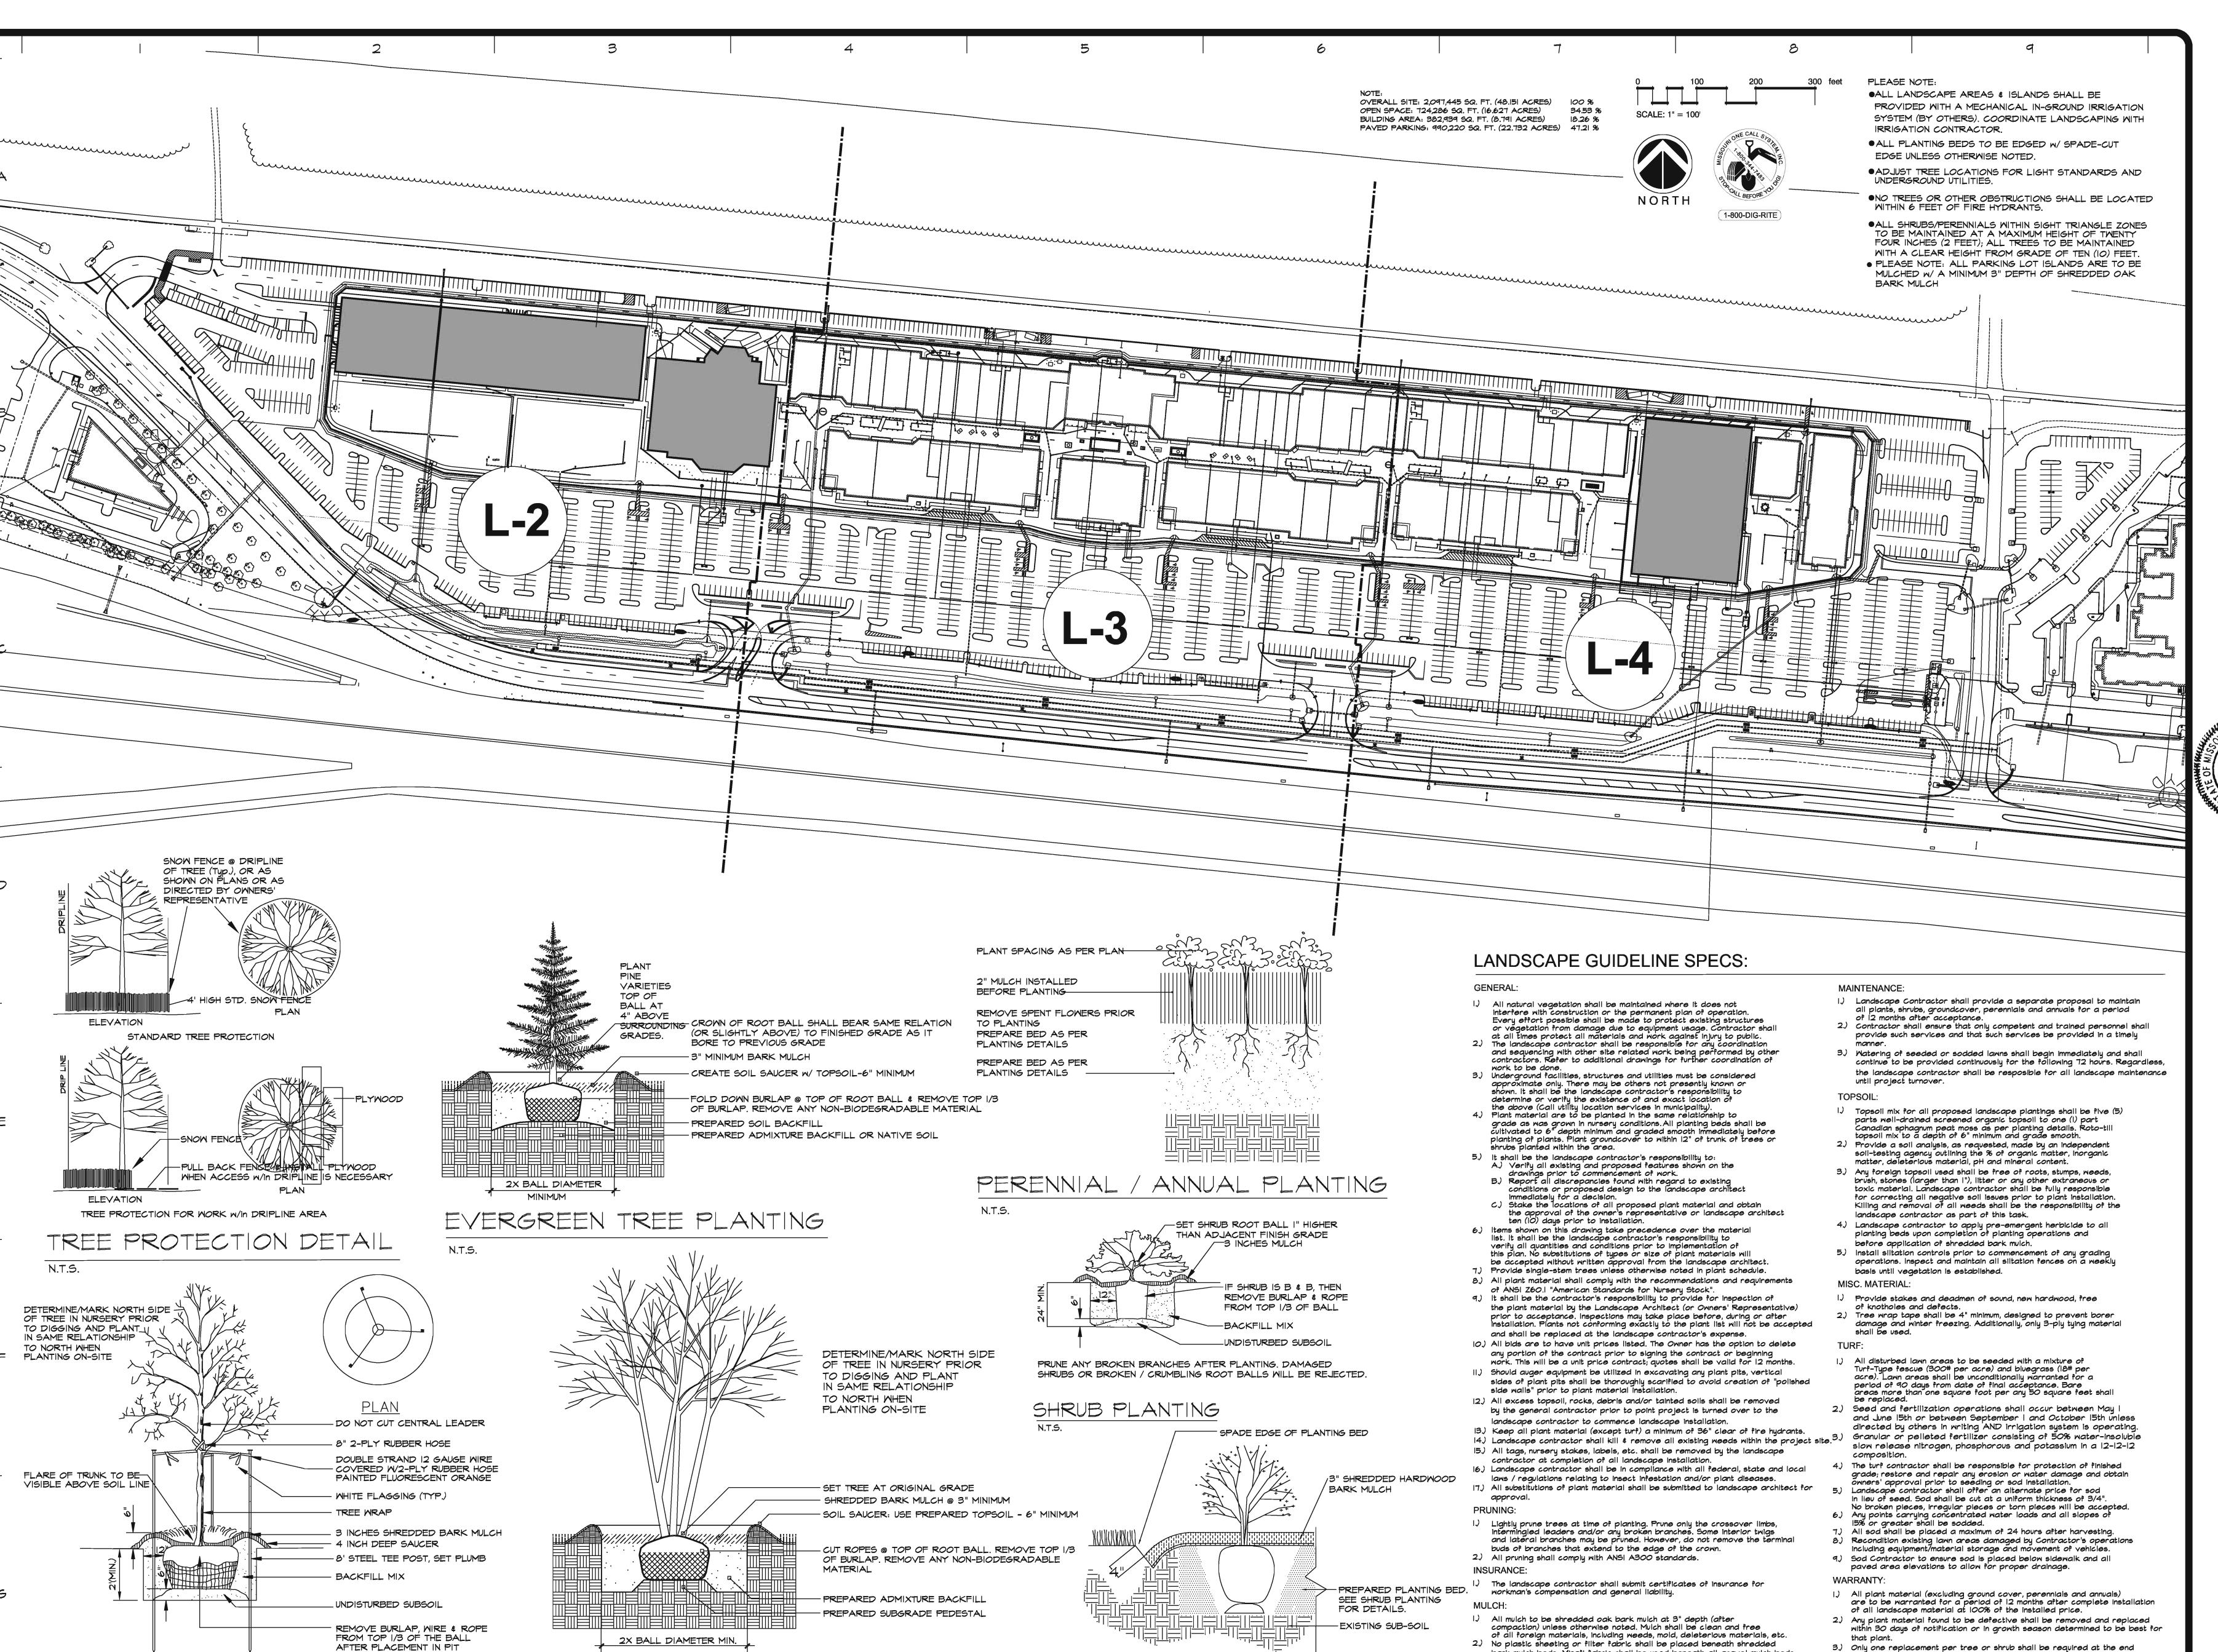


SPADE-CUT EDGE DETAIL

N.T.S.

MULTI-STEM TREE PLANTING

DECIDUOUS TREE PLANTING

8/13/19

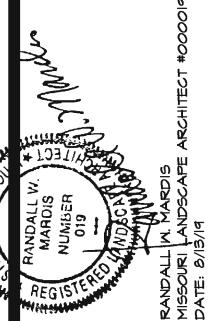

DATE 6/14/19 SCALE 1"=100'-0" 2019-143 SHEET

OF SIX SHEETS

3.) Only one replacement per tree or shrub shall be required at the end

of the warranty period, unless loss is due to failure to

4.) Lawn establishment period will be in effect once the lawn has been moved three times. Plant establishment period shall commence on the date of acceptance and

5.) A written guarantee shall be provided to the owner

per conditions outlined in #1 above.


comply with the warranty.

100% completion.

bark mulch beds. Mirafi fabric shall be used beneath all gravel mulch beds.

Lap fabric 6" over adjacent coverages.

3.) Edge all beds with spade-cut edge unless otherwise noted.

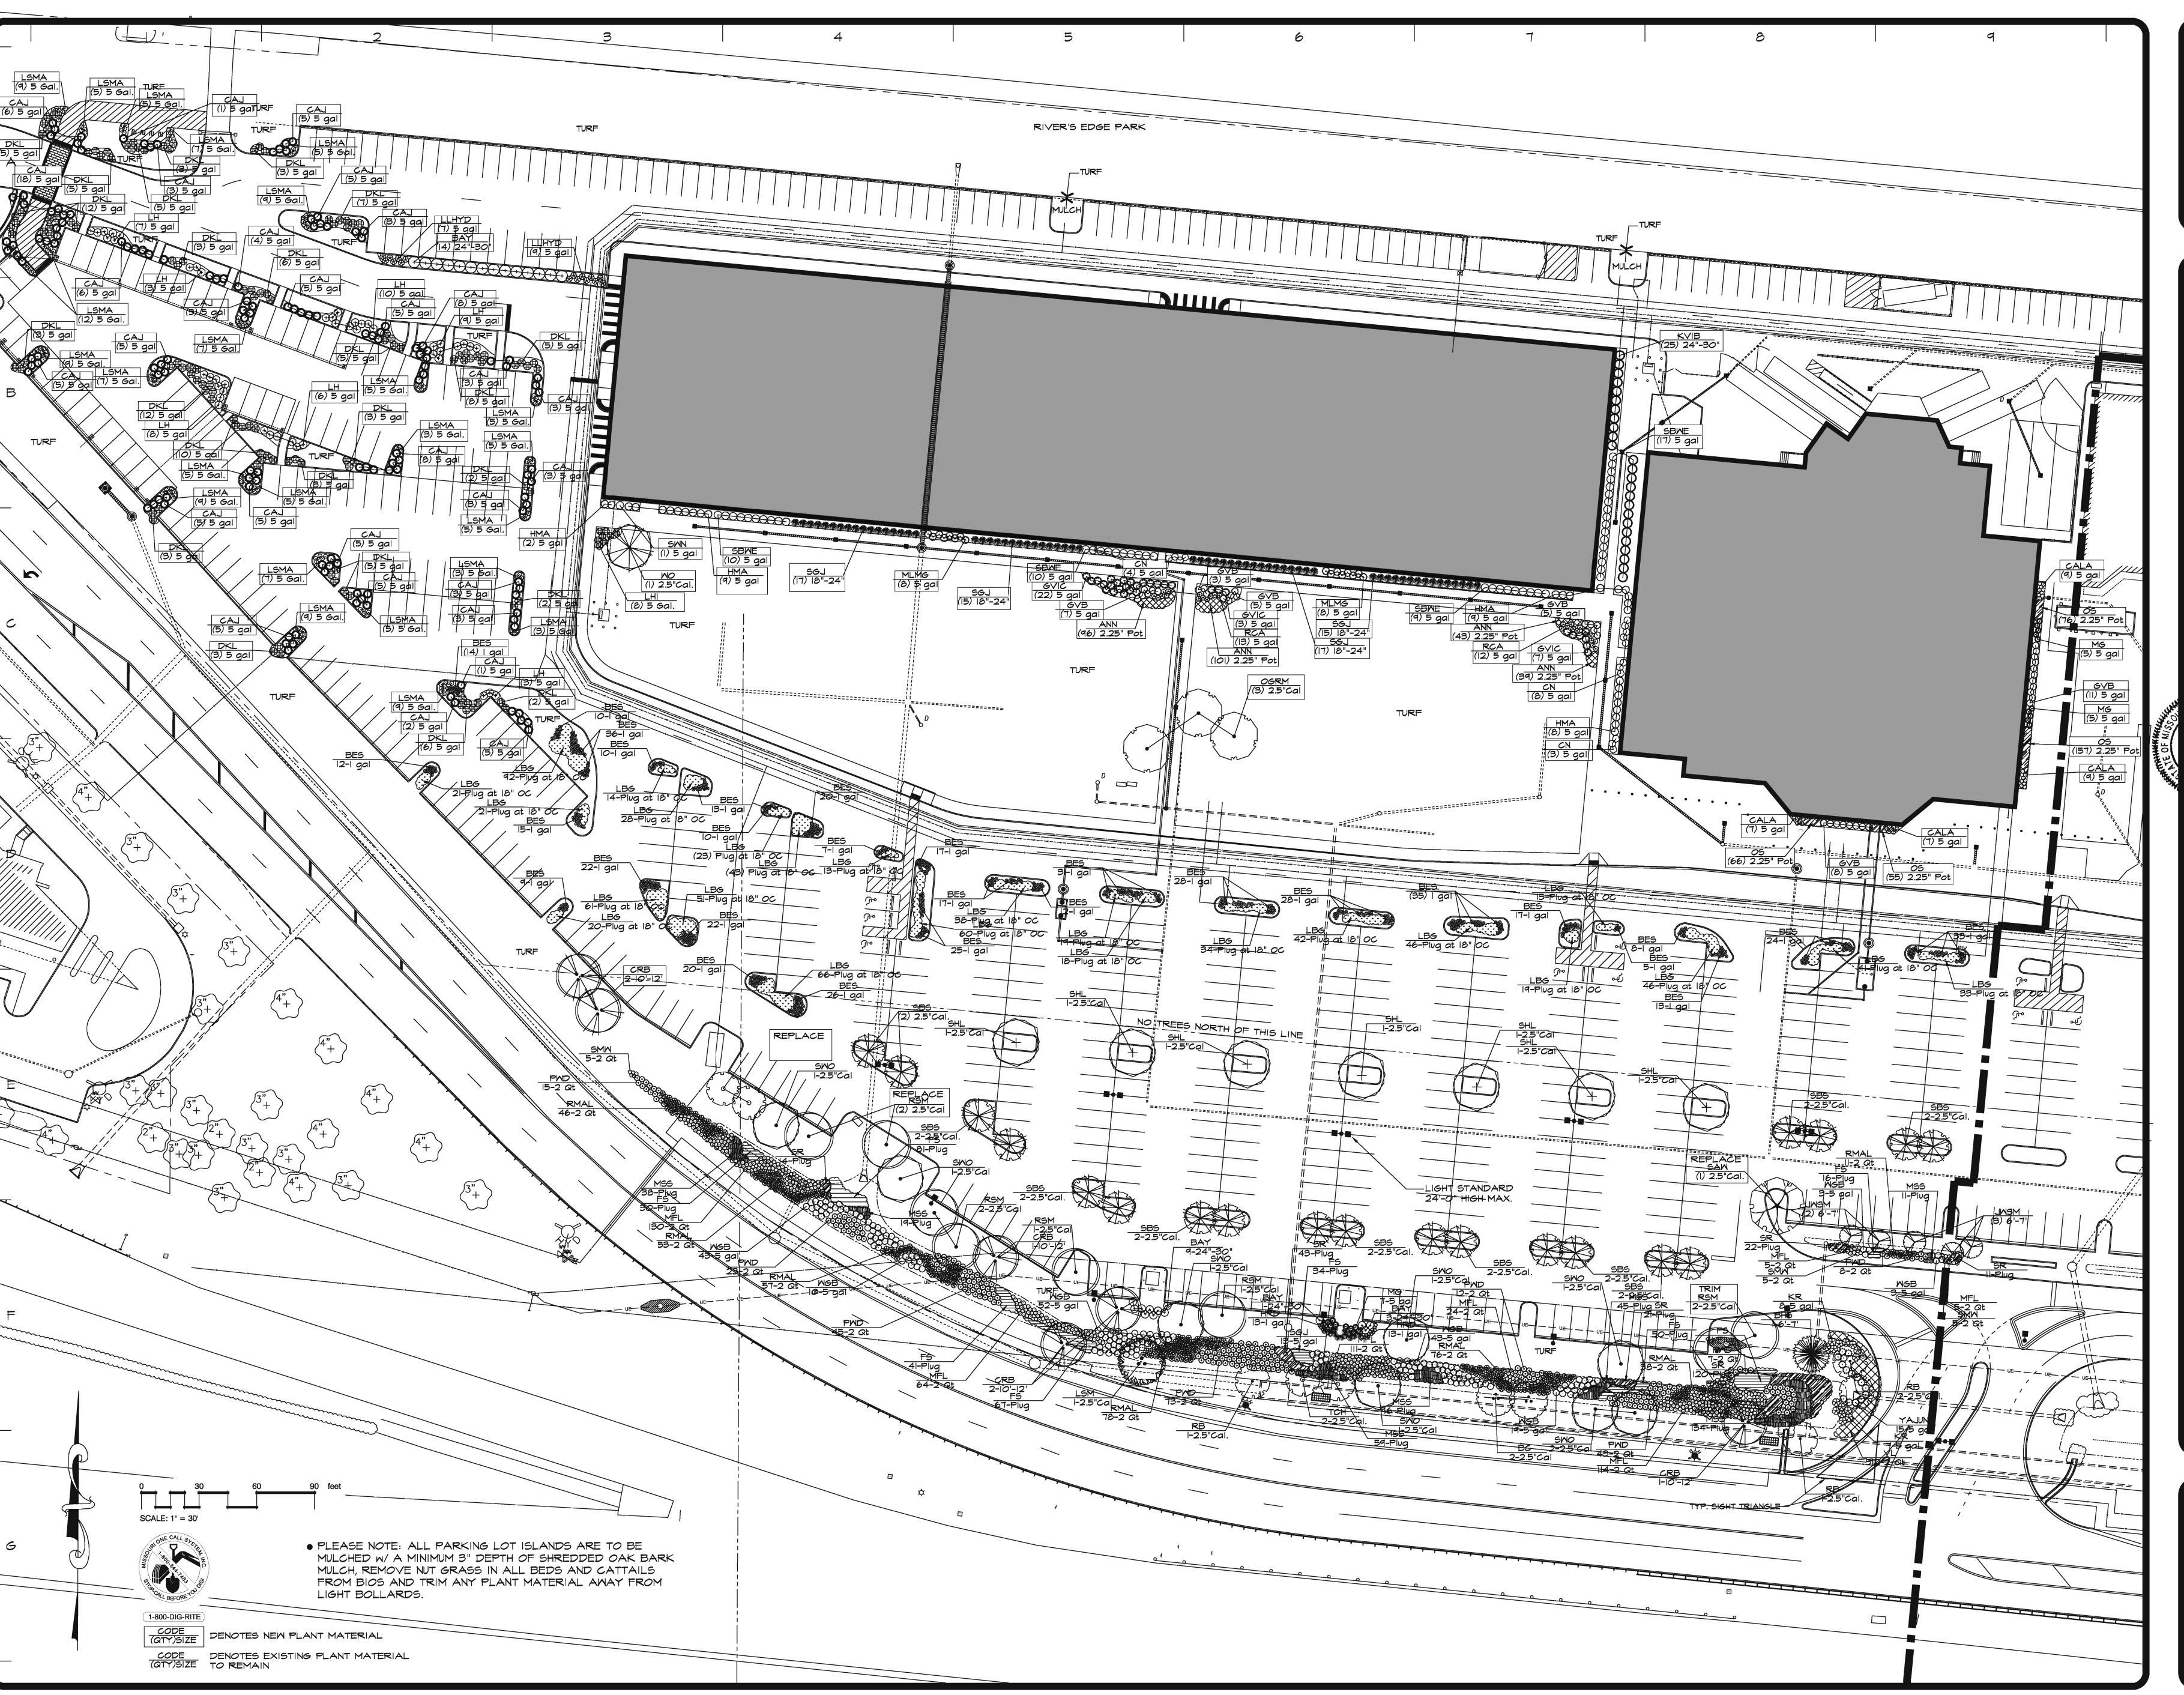

REVISIONS BY
6/24/19 RWM
7/22/19 RWM
8/8/19 RWM
8/13/19 RWM

T B C H N O L O G I E S

67 Jacobs Creek Drive
St. Charles, Missouri 63304
Mo Landscape Architectural Corporation #2008008782

RANDALL W. THE WANDALL W. THE MARDIS NUMBER OF THE WANDSCAPE ARCHITECT #00001

PLANTING PLAN FOR THE PROF

The District

DRAWN
RWM

CHECKED
RWM/GJB


DATE
6/14/19


SCALE
1"=30'-0"

JOB No.
2019-143

SHEET


OF SIX SHEETS

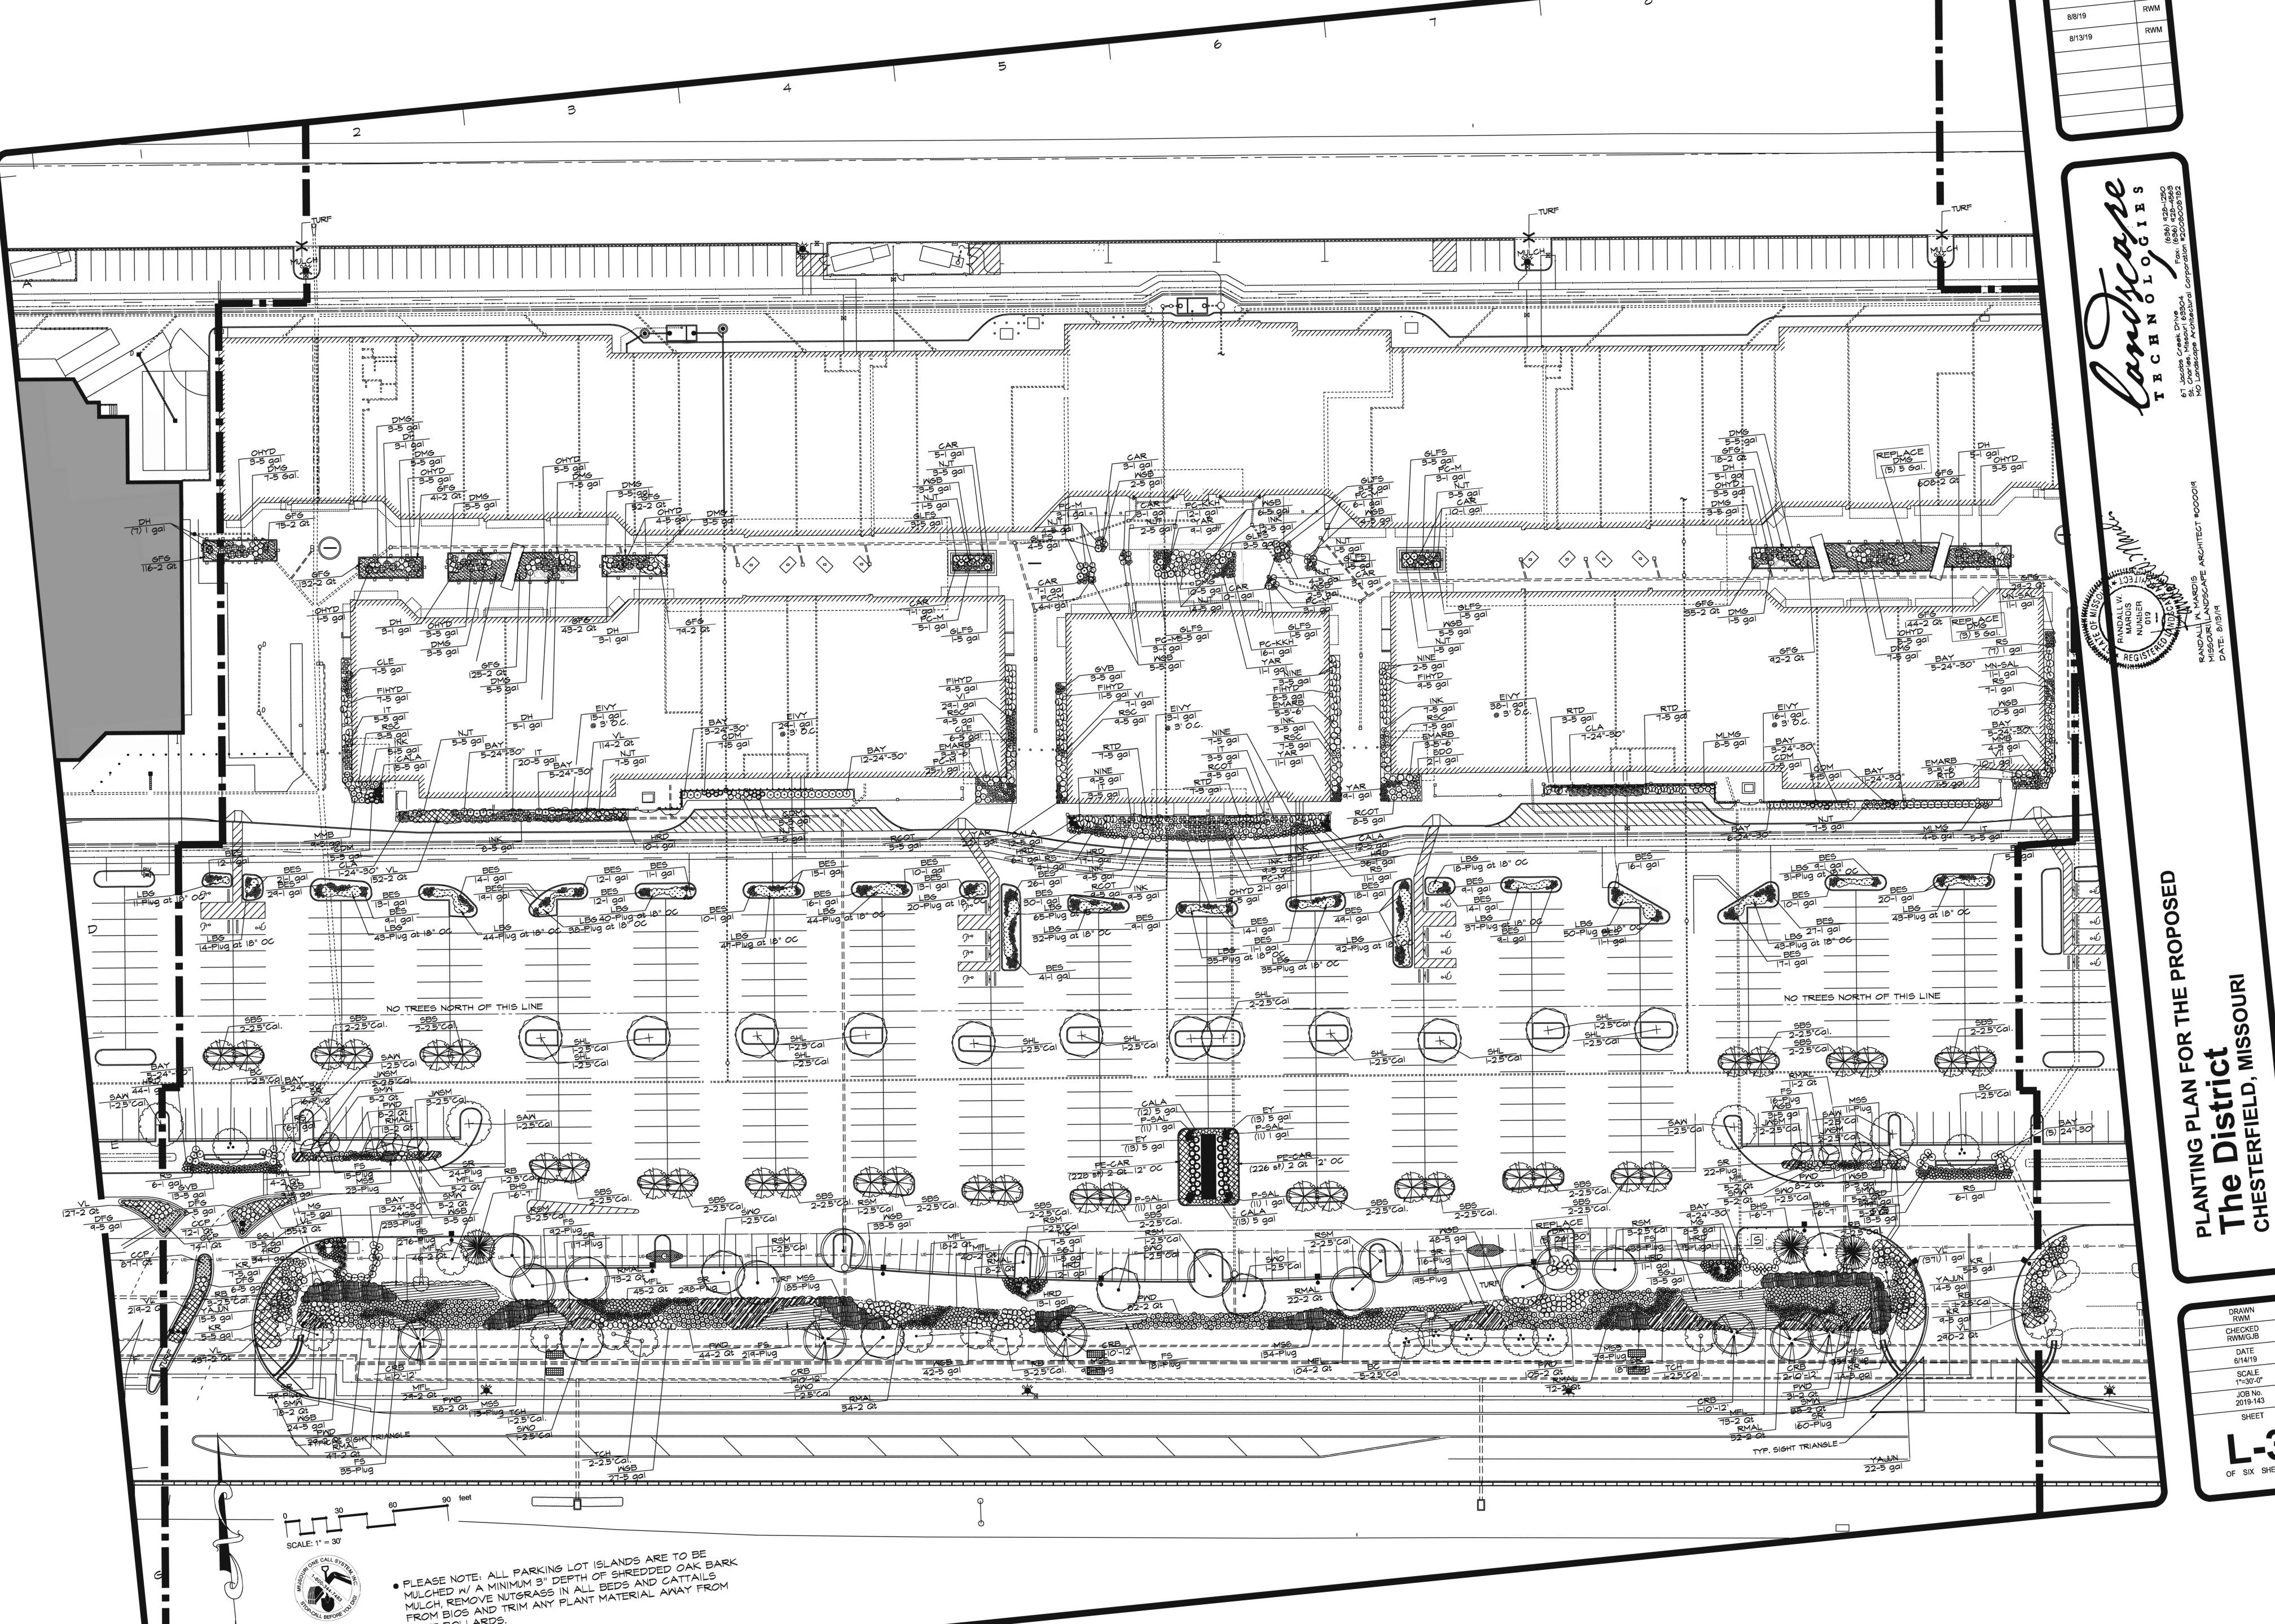

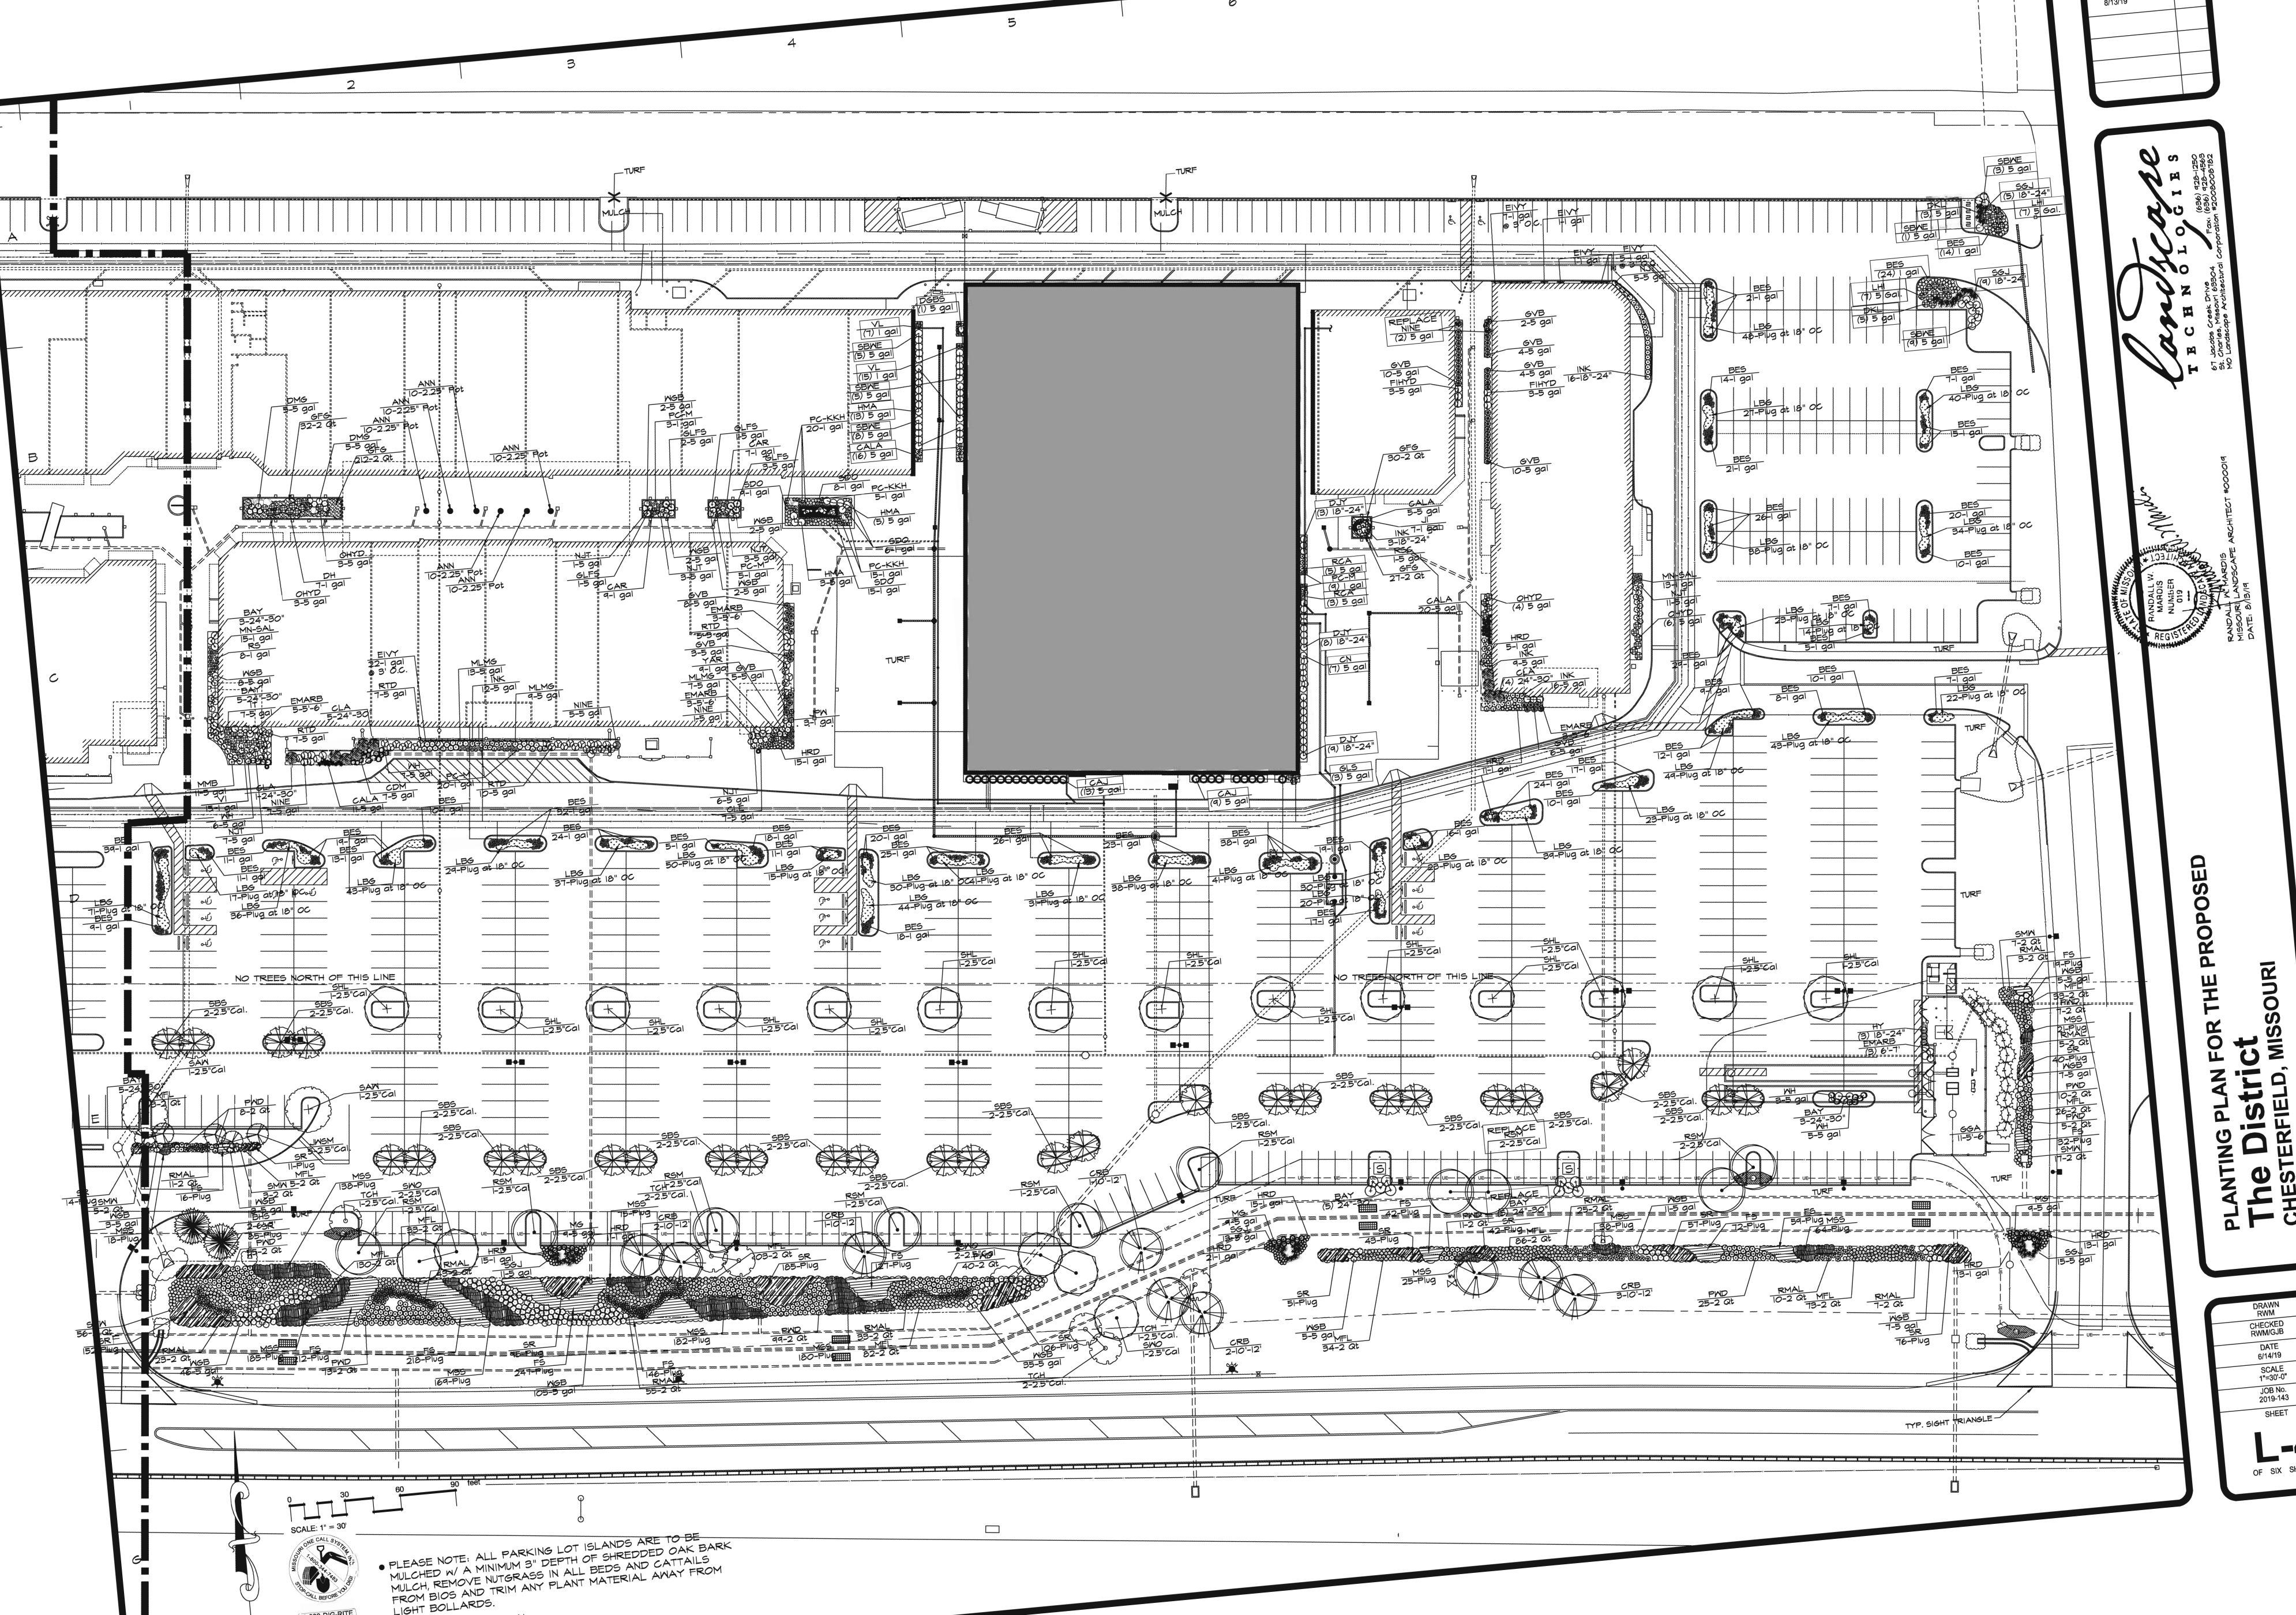

REVISIONS	BY
6/24/19	RWM
7/22/19	RWM
8/8/19	RWM
8/13/19	RWM



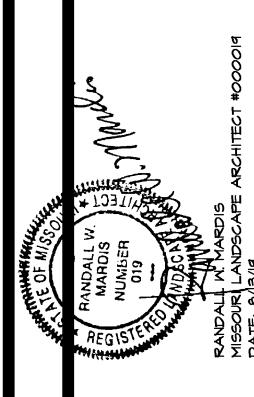

XISTING PLANT MATERIAL ON-SITE The District HESTERFIELD, MISSOURI

DRAWN
RWM
CHECKED
RWM/GJB

DATE
6/14/19
SCALE
N. A.
JOB No.
2019-143
SHEET

TREES:	QTY.: COMMON/BOTANICAL NAME:	SIZE:	TREE C	ROWTH RAT MODERATE		MATURE SI SIZE RANG
CRB	2 Clump River Birch/Betula nigra 'Cully'	10'-12'		X		45'+
OGRM	3 October Glory Red Maple/Acer rubrum 'October Glory'	2.5" Cal.			X	45'+
RSM	4 Red Sunset Maple/Acer rubrum 'Red Sunset'	2.5" Cal.			X	45'+
SAW	1 Sawtooth Oak/Quercus acutissima	2.5" Cal.		X		45'+
WO	1 Willow Oak/Quercus phellos	2.5" Cal.		X		45'+
FLOWERING TREES:	QTY.: COMMON/BOTANICAL NAME:	SIZE:				
TCH	2 Thornless Cockspur Hawthorn/Crataegus crusgalli var. inermis	2.5" Cal.		X		15'-20'
SHRUBS:	QTY.: COMMON/BOTANICAL NAME:	SIZE:				
BAY	24 Northern Bayberry/Myrica pennsylvanica	24"-30"				
CAJ	148 Compact Andorra Juniper/Juniperus horizontalis 'Plumosa Compacta'	5 Gal.				
CN	22 Coppertina Ninebark/Physocarpus opulifolius 'Coppertina'	5 Gal.				
DGBS	1 Dwf. Globe Blue Spruce/Picea pungens 'Globosa'	5 Gal.				
DJY	20 Densiforma Yew/Taxus cuspidata 'Densiformis'	18"-24"				
DKL	129 Dwarf Korean Lilac/Syringa meyeri 'Palibin'	5 Gal.				
EY	26 Everlow Yew/Taxus X media 'Everlow'	5 Gal.				
GLFS	3 Gro-Low Fragrant Sumac/Rhus aromatica 'Gro-Low'	5 Gal.				
GVB	39 Green Velvet Boxwood/Buxus 'Green Velvet'	5 Gal.				
GVIC	32 Golden Vicary/Ligustrum vicaryi	5 Gal.				
HMA	41 Hetz Midget Arborvitae/Thuja occidentalis 'Hetz Midget'	5 Gal.				
KVIB	25 Koreanspice Viburnum/Viburnum carlesii	24"-30"				
LH	46 Limelight Hydrangea/Hydrangea paniculata 'Limelight'	5 Gal.				
LHI	22 Little Henry Sweetspire/Itea virginica "Little Henry'	18"-24"				
LLHYD	16 Little Lime Hydrangea/Hydrangea paniculata 'Little Lime'	5 Gal.				
LSMA	153 Low Scape Mound Chokeberry/Aronia melanocarpa 'Low Scape Mound'					
NINE	2 Diablo Ninebark/Physocarpus opulifolius 'Diablo'	5 Gal.				
RCA	33 Rose Creek Abelia/Abelia x grandiflora 'Rose Creek'	5 Gal.				
SBWE	77 Sonic Bloom Weigelia/Weigelia florida 'Sonic Bloom'	5 Gal.				
SGJ	78 Sea Green Juniper/Juniperus chinensis 'Sea Green'	18"-24"				
SWN	1 Summer Wine Ninebark/Physocarpus opulifolius 'Summer Wine'	5 Gal.				
PERENNIALS:	QTY.: COMMON/BOTANICAL NAME:	SIZE:				
BES	525 Black-Eyed Susan/Rudbeckia fulgida 'Goldsturm'	1 Gal.				
PC-M	9 Purple Coneflower/Echinacea purpurea 'Magnus'	1 Gal.				
PE-CAR	454 Pennsylvania Sedge/Carex pennsylvanica	2 Qt.				
VL	22 Variegated Liriope/Liriope muscari 'Variegata'	1 Gal.				
GRASSES:	QTY.: COMMON/BOTANICAL NAME:	SIZE:				
CALA	48 Foerster's Reed Grass/Calamagrostis acutifilia 'Karl Foerster'	5 Gal.				
DMG	8 Dwarf Maiden Grass/Miscanthus sinensis 'Yakushima'	5 Gal.				
MG	10 Maiden Grass/Miscanthus sinensis 'Gracillimus'	5 Gal.				
MLMG	16 Morning Light Maiden Grass/Miscanthus sinensis 'Morning Light'	5 Gal.				
GROUNDCOVERS:	QTY. COMMON/BOTANICAL NAME	SIZE:				
ANN	279 Mixed Annuals/Min. of five varieties	2.25" Pot				
OS	354 Orange Stonecrop/Sedum kamtschaticum	2.25" Pot				
	out Crange Clonecrop/Deduin Kantischaucum	2.20 1 UL				


Please note: Red Sunset Maple comprise 36% of trees proposed; however, these are replacement trees from the initial landscape installation


Tree Groupings:

A minimum of of 20% of tree groupings shall come from three categories: Deciduous / Ornamental / Evergreen

Deciduous: 11 or 85%
Ornamental 2 or 15%
Evergreen 0 or 0%

Please note: Per the agreement with Monarch Levee District in 2011, no trees were/are allowed north of denoted line in parking lot and the 2011 plan was approved under a different landscape ordinance at that time and under agreements.

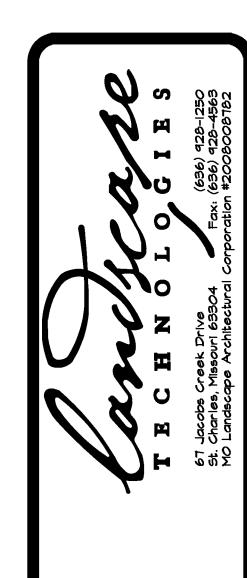

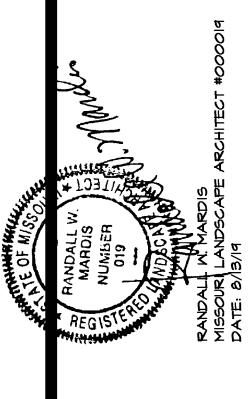

PROPOSED NEW LANDSCAPE MATTICE TO MISSON OF THE DISTRICT MISSON OF THE PRINCE OF THE P

DRAWN
RWM
CHECKED
RWM/GJB

DATE
6/14/19

SCALE
N. A.

JOB No.
2019-143

SHEET



DATE 6/14/19 SCALE 1"=30'-0" JOB No. 2019-143



CHECKED RWM/GJB DATE 6/14/19 SCALE 1"=30'-0" JOB No. 2019-143 SHEET



REVISIONS BY
6/24/19 RWM
7/22/19 RWM
8/8/19 RWM

DRAWN
RWM
CHECKED
RWM/GJB
DATE
6/14/19
SCALE
1*=30'-0*
JOB No.
2019-143
SHEET

OF SIX SHEETS

Avg/Min | Max/Min

| 16.00

8.75

N.A.

15.00

3.72

3.90

N.A.

2.60

1.86 8.0 0.5

3.12 7.0 0.8

0.03 0.5 0.0

2.70 7.5 0.5 5.40

SP-1

SEE ENLARGED "WEST LOT" PLAN SEE ENLARGED "PARKING GARAGE" PLAN SEE ENLARGED "MUSIC VENUE" PLAN SEE ENLARGED "MAIN EVENT" PLAN

Luminaire Sc	iledule					
Symbol	Qty	Label	Arrangement	Total Lamp Lumens	LLF	Description
	4	S1	BACK-BACK	N.A.	0.900	VTS-F08-LED-E1-5XQ
<u>—</u>	10	S2	SINGLE	N.A.	0.900	VTS-F12-LED-E1-T3
<u>—</u>	2	S3	SINGLE	N.A.	0.900	VTS-F12-LED-E1-5XQ
→	8	WP1	SINGLE	N.A.	0.900	GWC-AF-01-LED-E1-SL2
	3	WP2	SINGLE	N.A.	0.900	GWC-AF-02-LED-E1-T4W
+	12	WP3	SINGLE	N.A.	0.900	XTOR1B-W
\odot	2	F1	SINGLE	N.A.	0.900	611-3021
→	6	F2	SINGLE	N.A.	0.900	NFFLD-S-C70-D-UNV-66-7050
\odot	7	A2	SINGLE	N.A.	0.900	HC620D010-HM612840-61MDCWF
→	19	EL3	SINGLE	N.A.	0.900	GPC-AF-01-LED-E1-T2-7030-600
	3	EL4	GROUP	N.A.	0.900	LED Linear - Kalypso Linear Grazer
+	10	Х3	SINGLE	N.A.	0.900	XTOR1B-W

Qty 8 - A1 - Decorative Wall Sconce - FEISS 36.5"L x 6"W x 7"D - Oil Rubbed Bronze

FIXTURE FINISH SCHEDULE:

PARKING LOT POLES - SILVER, WHITE LIGHT

PARKING GARAGE WALL PACKS - SILVER, WHITE LIGHT

MUSIC VENUE - BLACK, WHITE LIGHT MAIN EVENT - GREY, WHITE LIGHT

FIXTURE MOUNTING HEIGHTS (HEIGHT INCLUDES BASE)

CalcType

Illuminance

Illuminance

Illuminance

Illuminance

Illuminance

Illuminance

PARKING LOT LIGHT LEVELS CALCULATED ON GROUND EVERY 10'

SIDEWALK LIGHT LEVELS CALCULATED ON GROUND EVERY 3'

DESIGN IS BASED ON CURRENT INFORMATION PROVIDED AT TIME OF REQUEST. ANY CHANGES IN MOUNTING HEIGHT OR LOCATION, LAMP WATTAGE, LAMP TYPE,

AND EXISTING FIELD CONDITIONS, THAT EFFECT ANY OF THE PREVIOUSLY MENTIONED,

WILL VOID CURRENT LAYOUT AND REQUIRE A CHANGE REQUEST AND RECALCULATION.

PARKING LOT FIXTURES - EXISTING FIXTURES = 24'

PARKING LOT FIXTURES - NEW FIXTURES = 20'

Calculation Summary

Garage - Ring Road

Main Event Sidewalk


Property Line

West Parking Lot

Garage-Music Venue Sidewalk


Music Venue - Loading Area

ALL OTHERS - SEE PLAN FOR MOUNTING HEIGHT (MH)

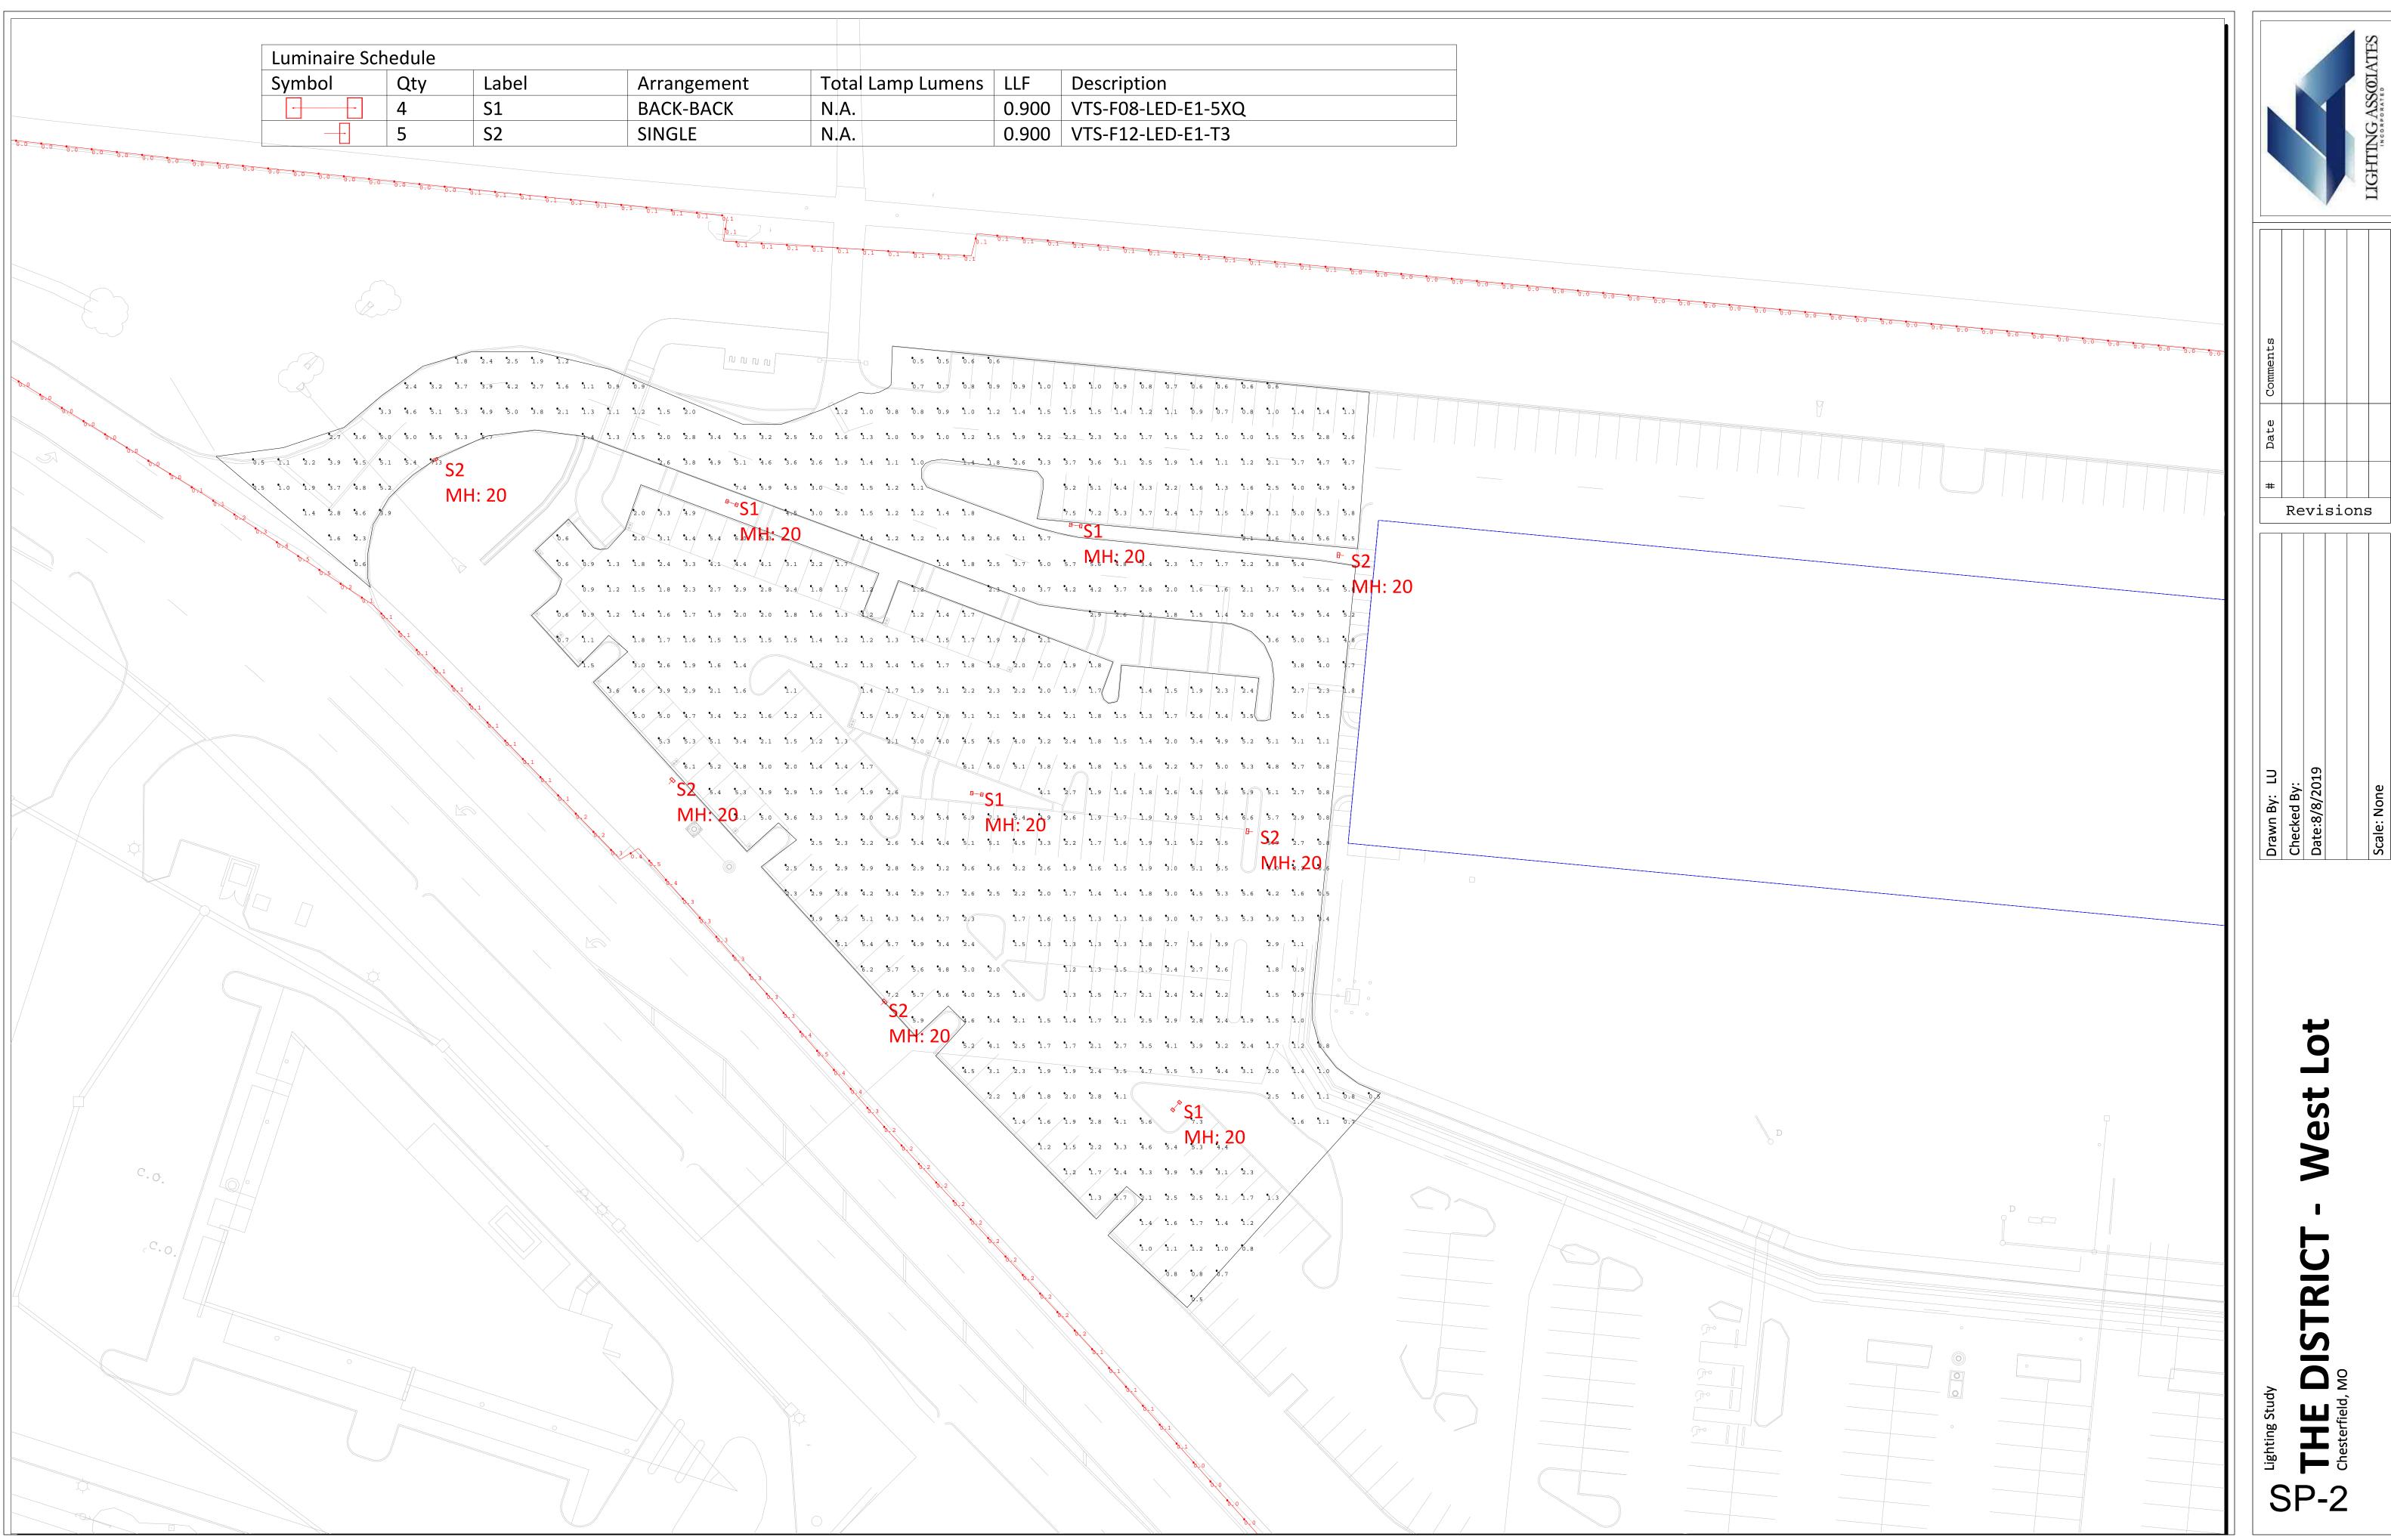




Comments					
Date					
#					
	Re	vi	si	ons	3

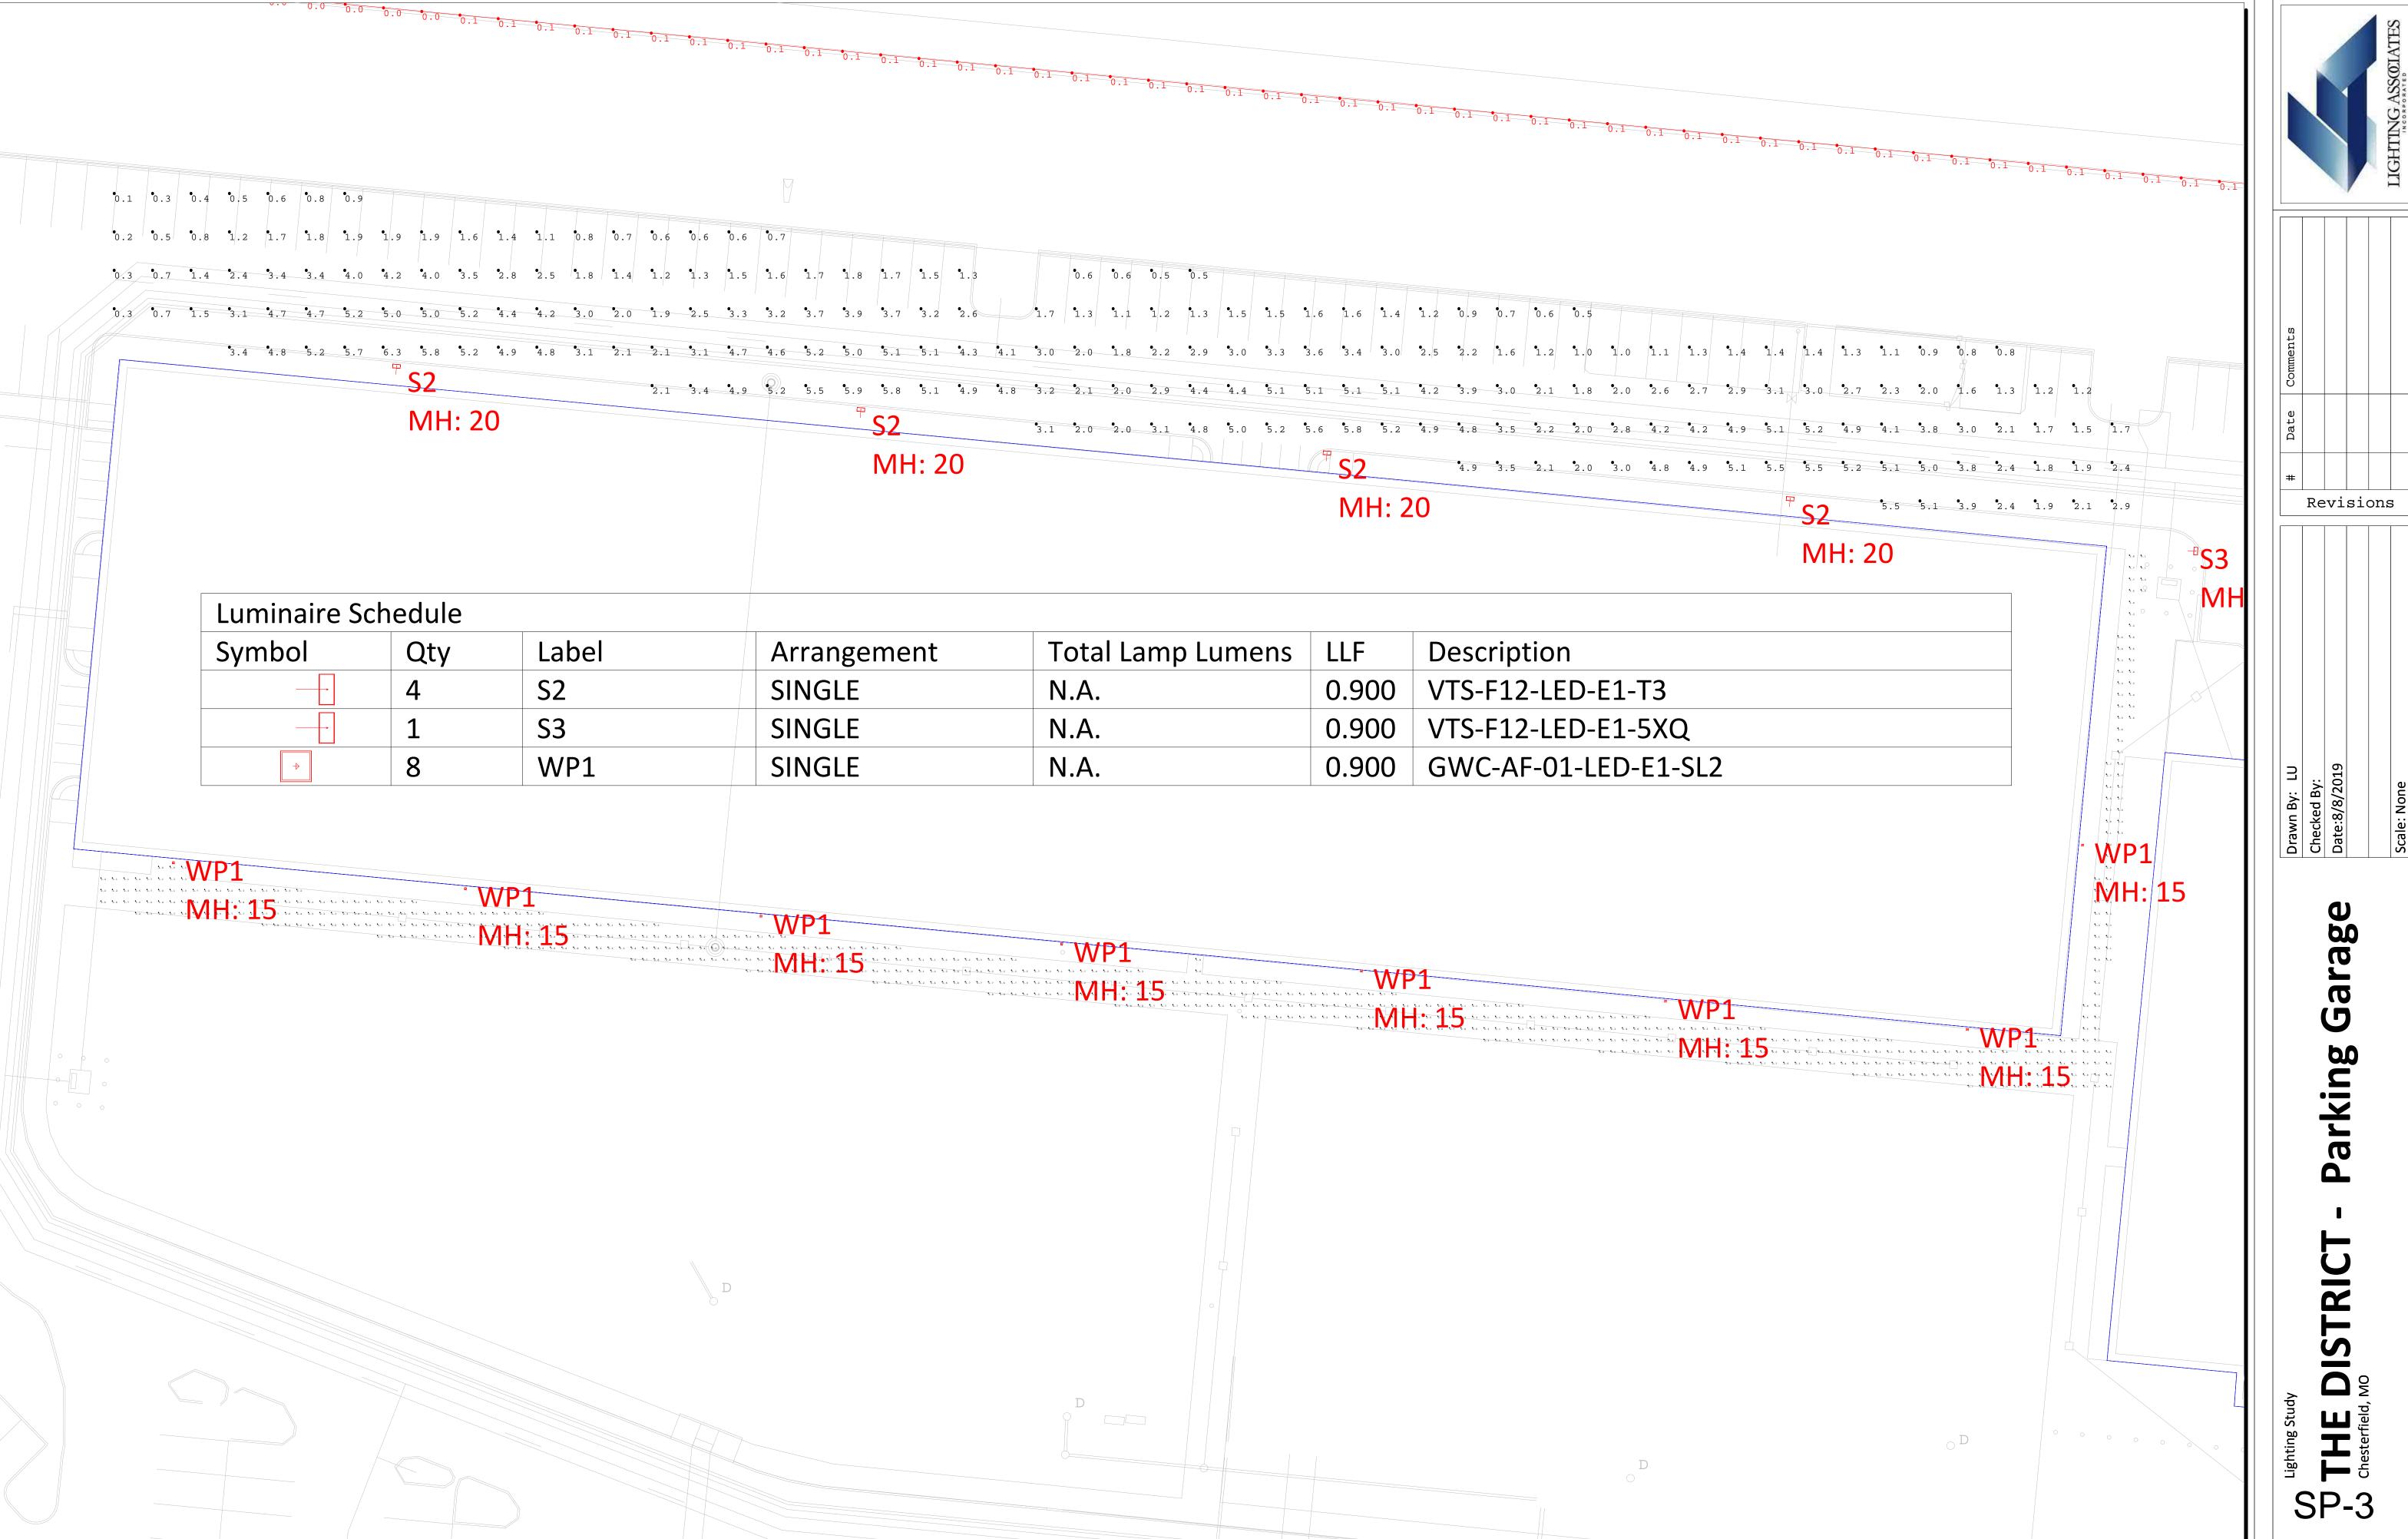



# Date Comments	Re	:vi	sio	ons	5
21	•	119			

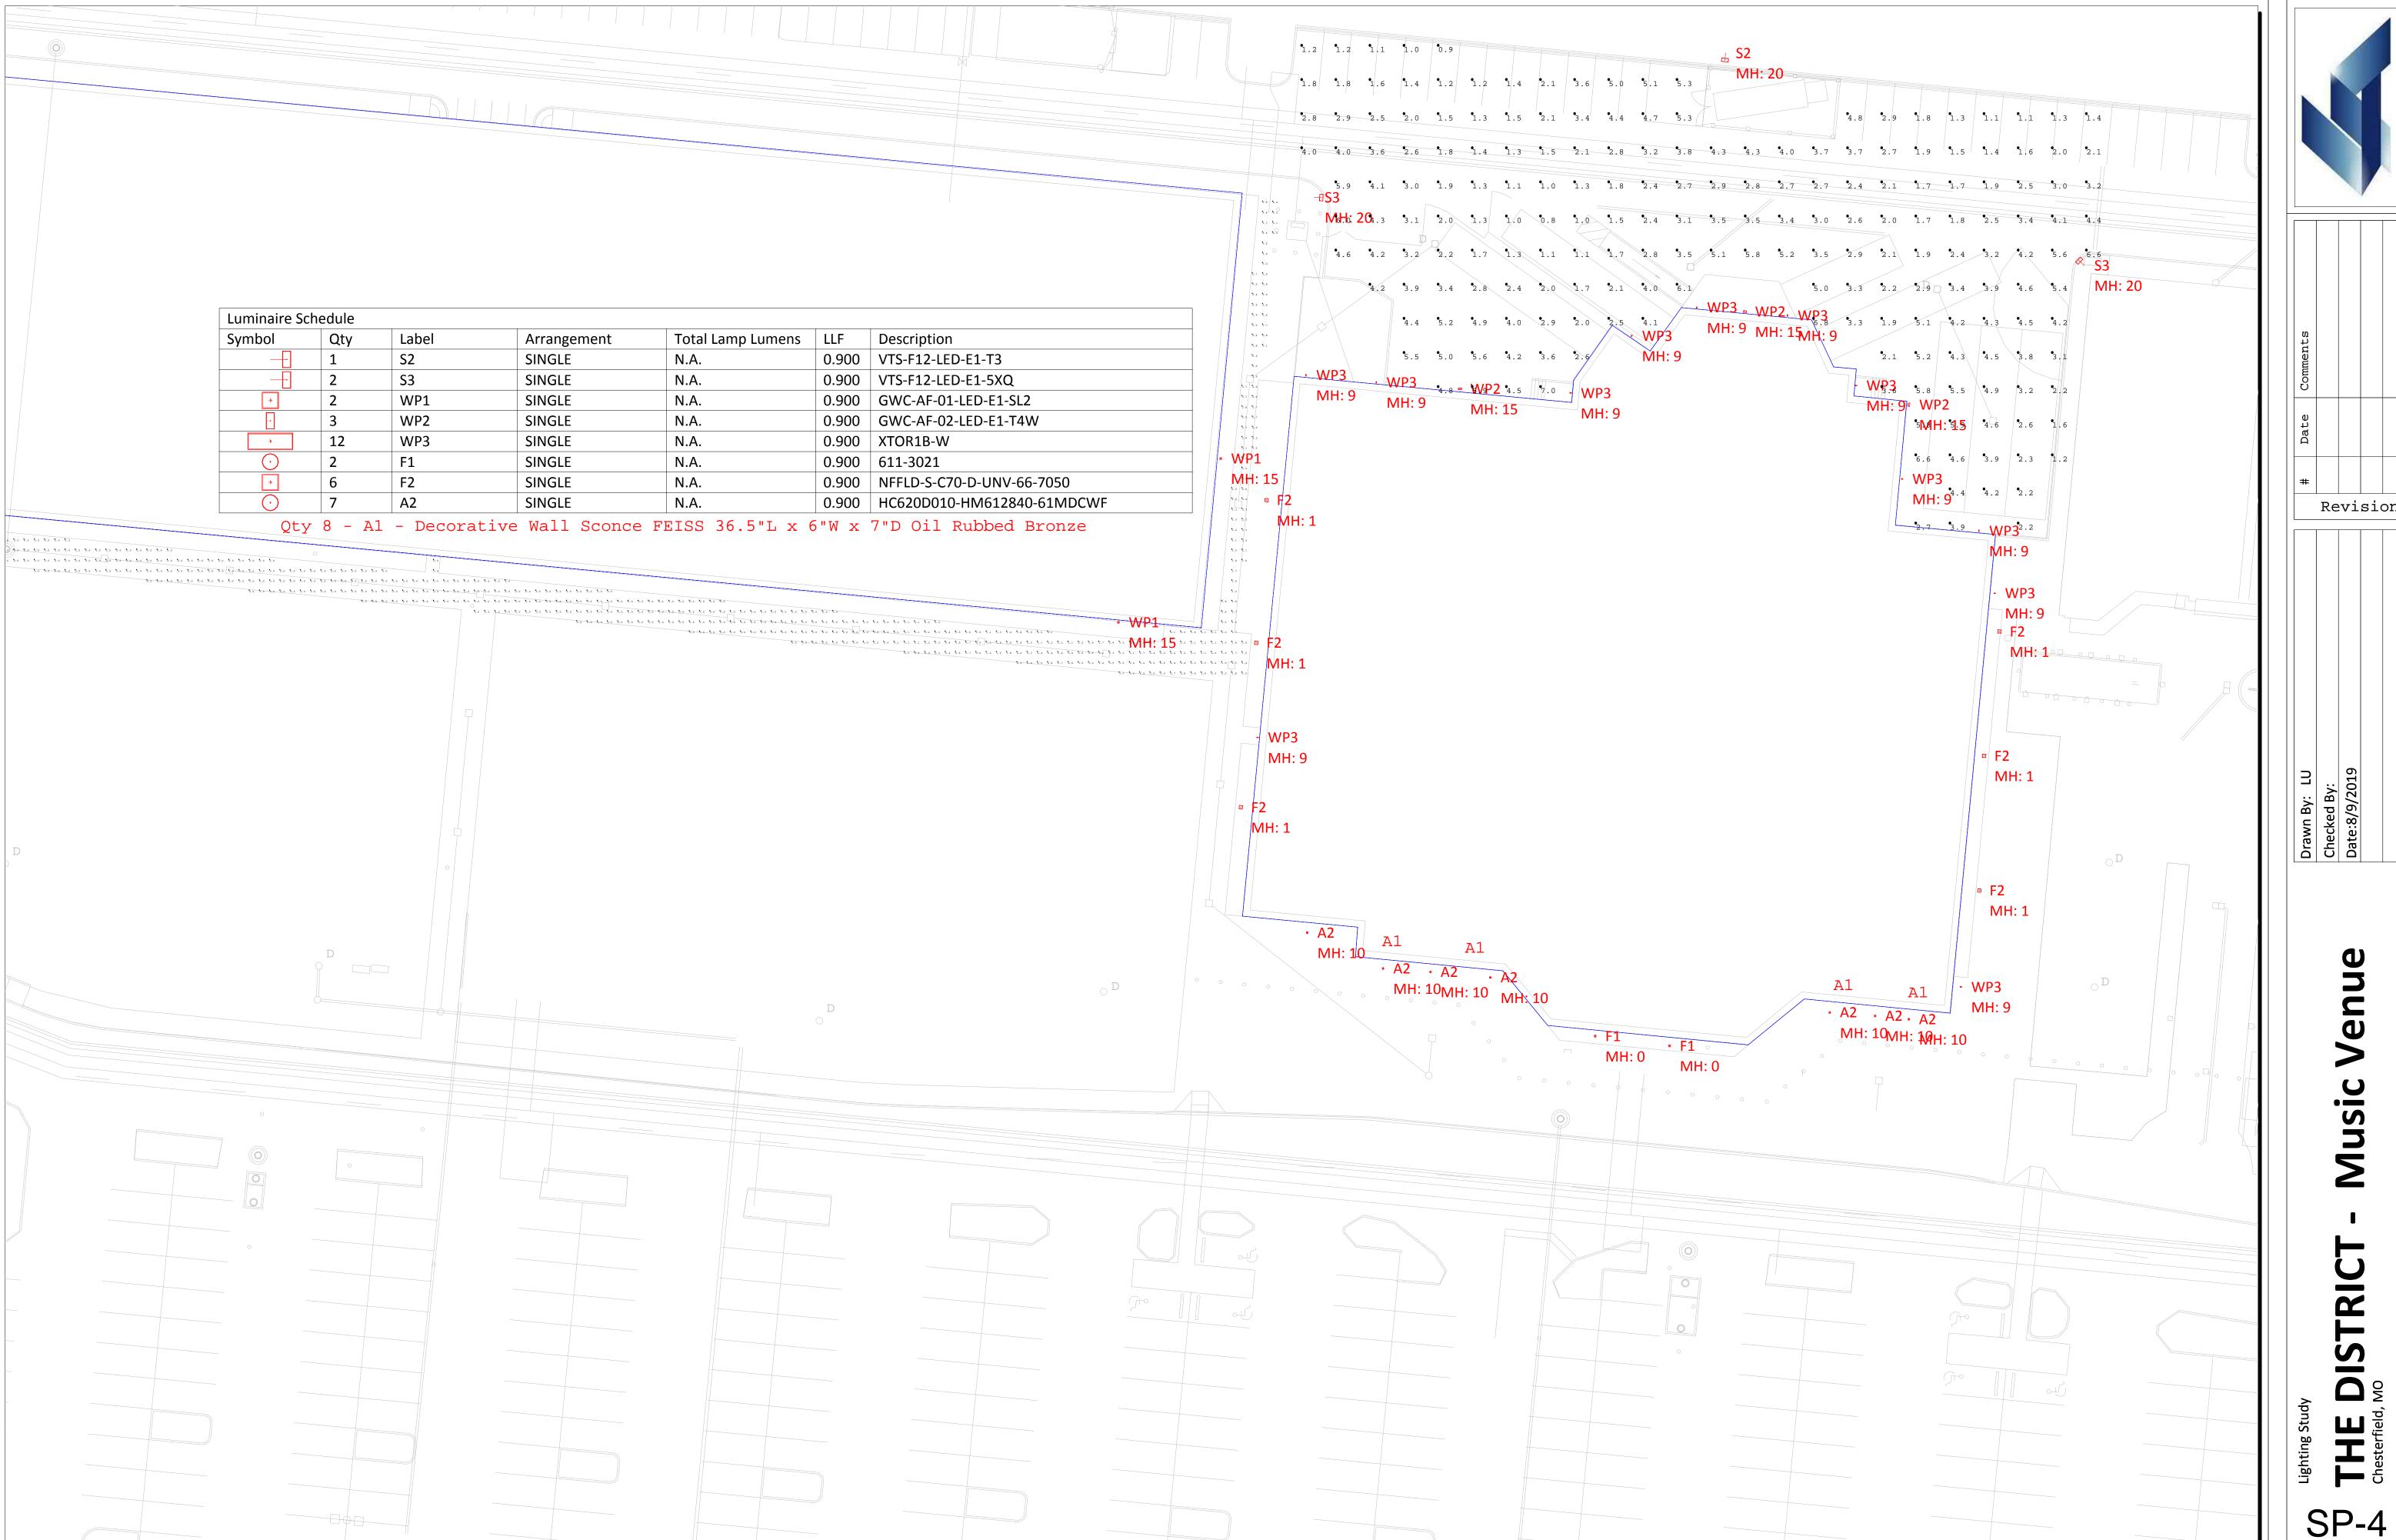









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Date:8/9/2019	vi				
	si				/
	ons				,
Scale: None	3				=

c Venue -Flood Light Study

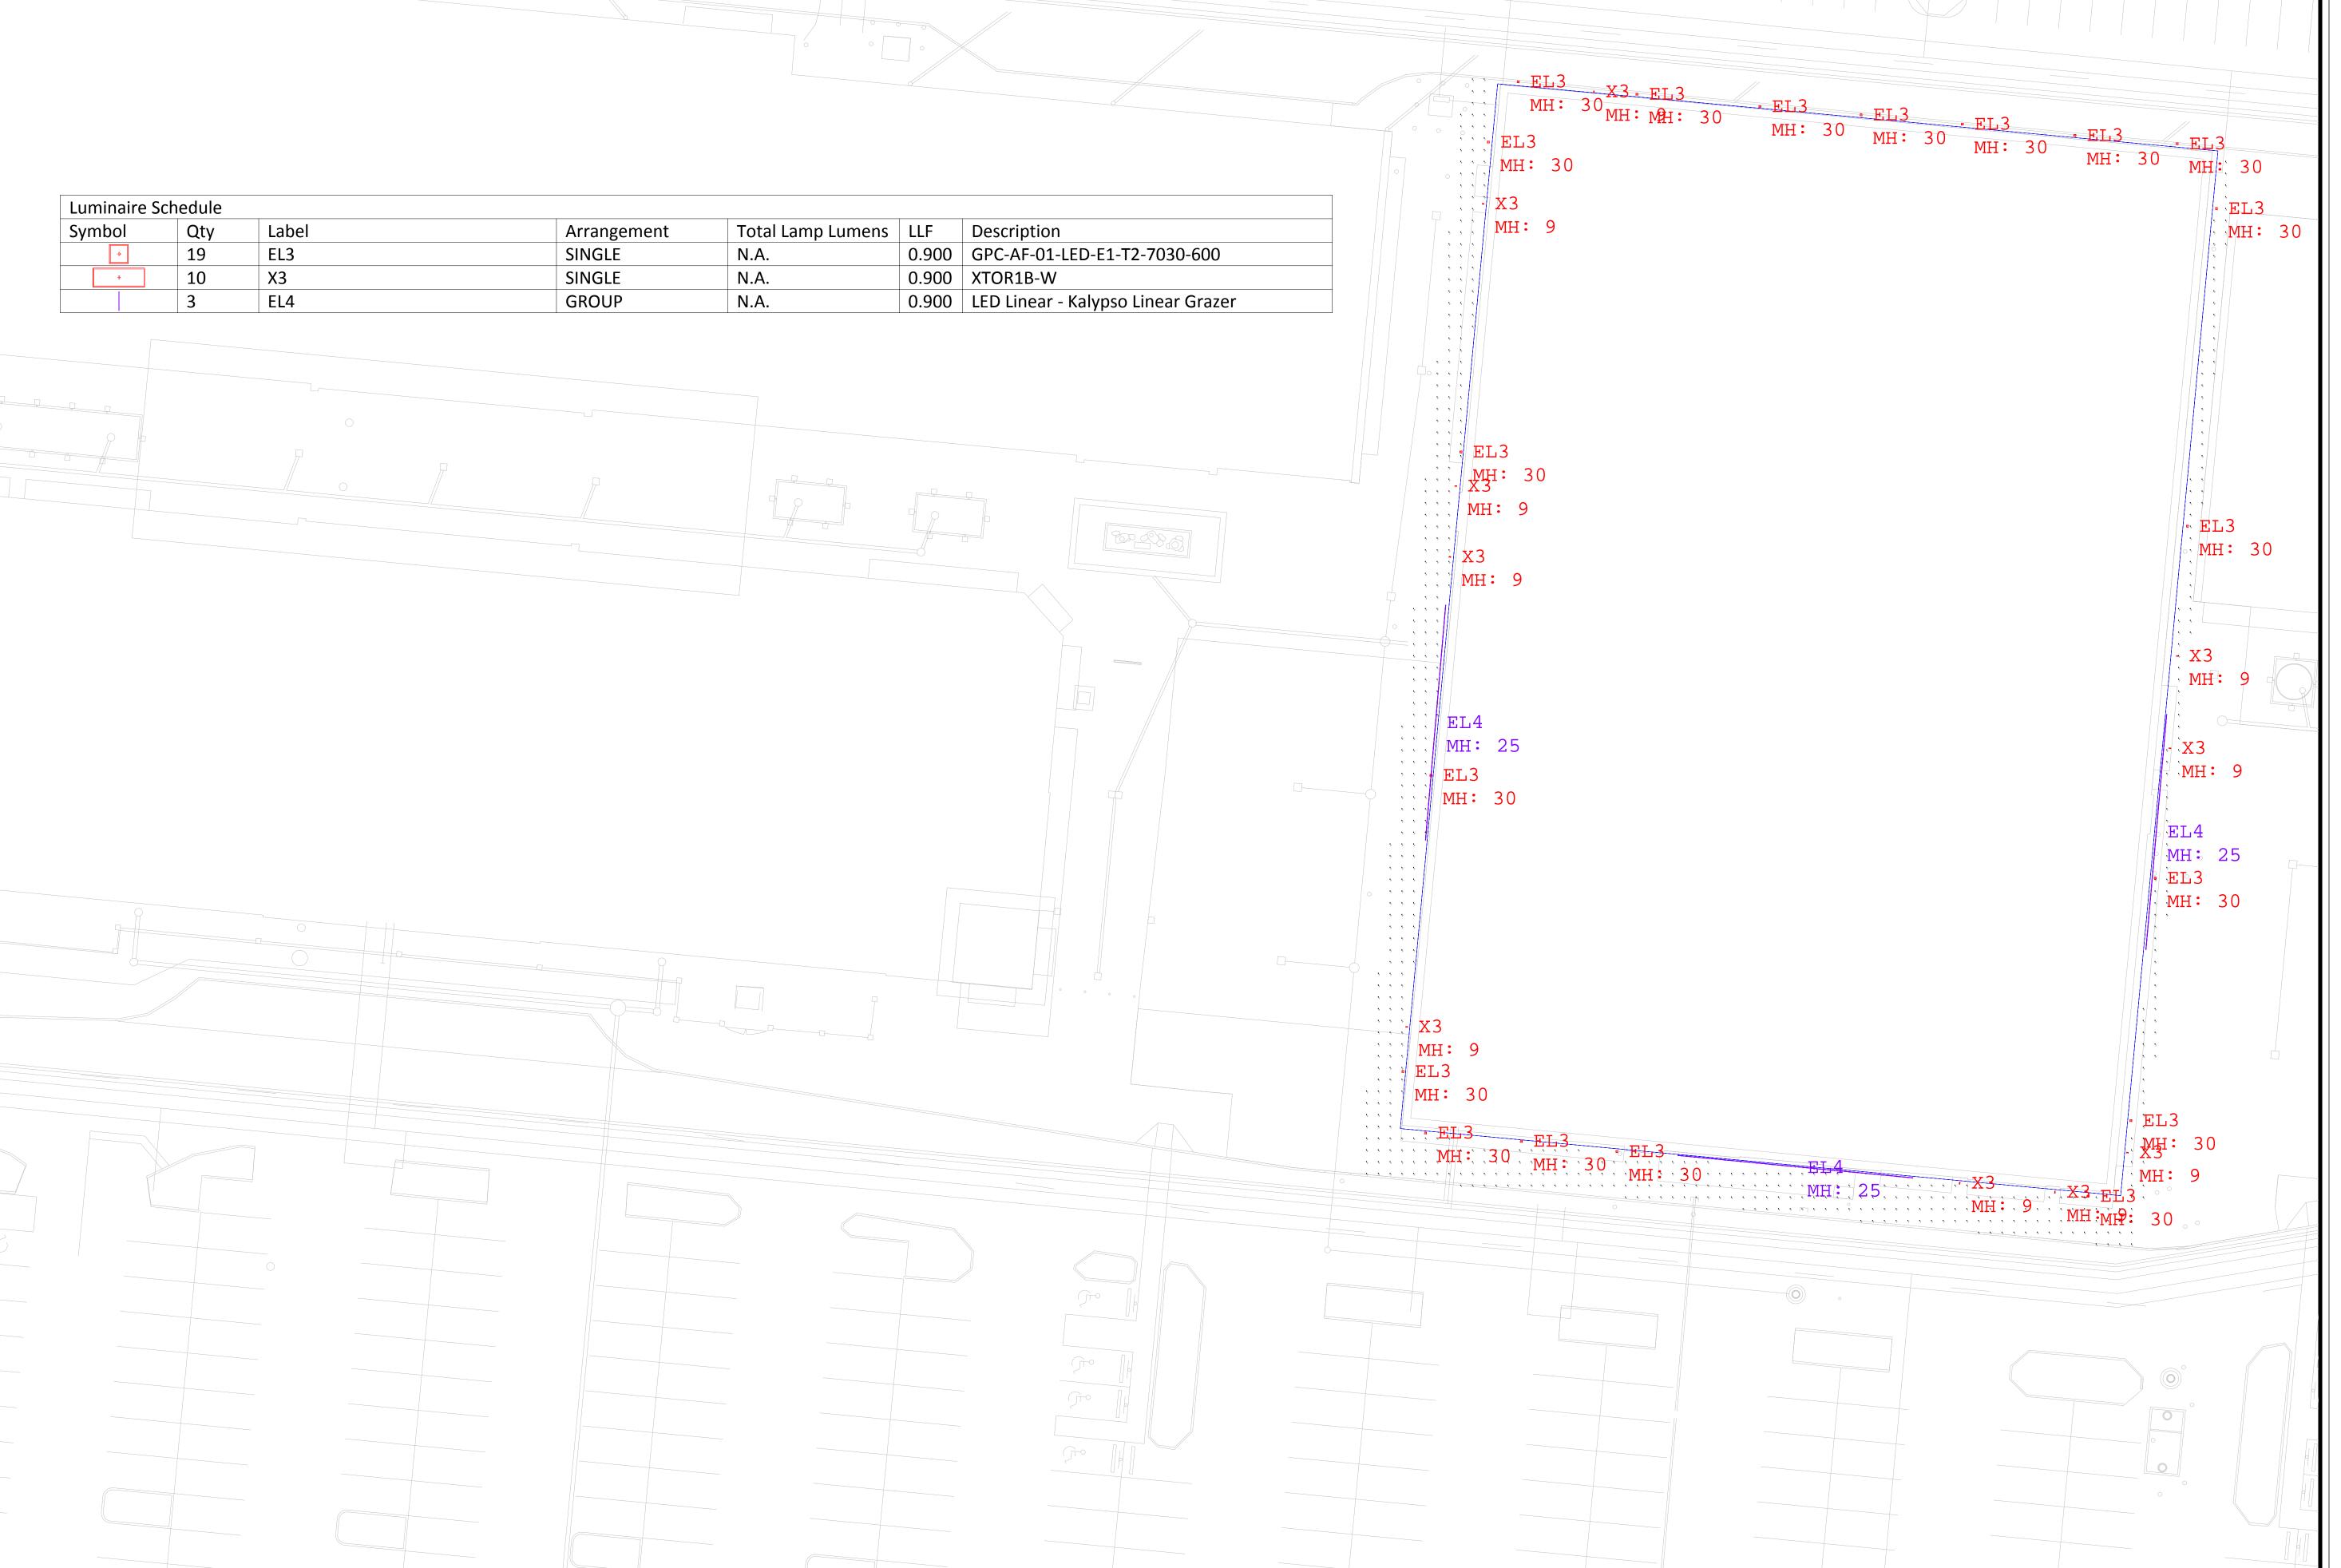

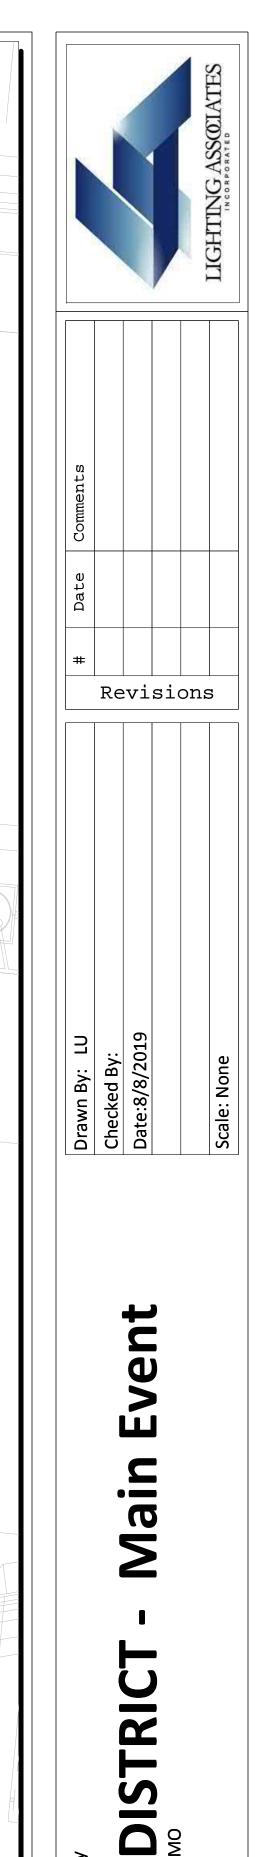

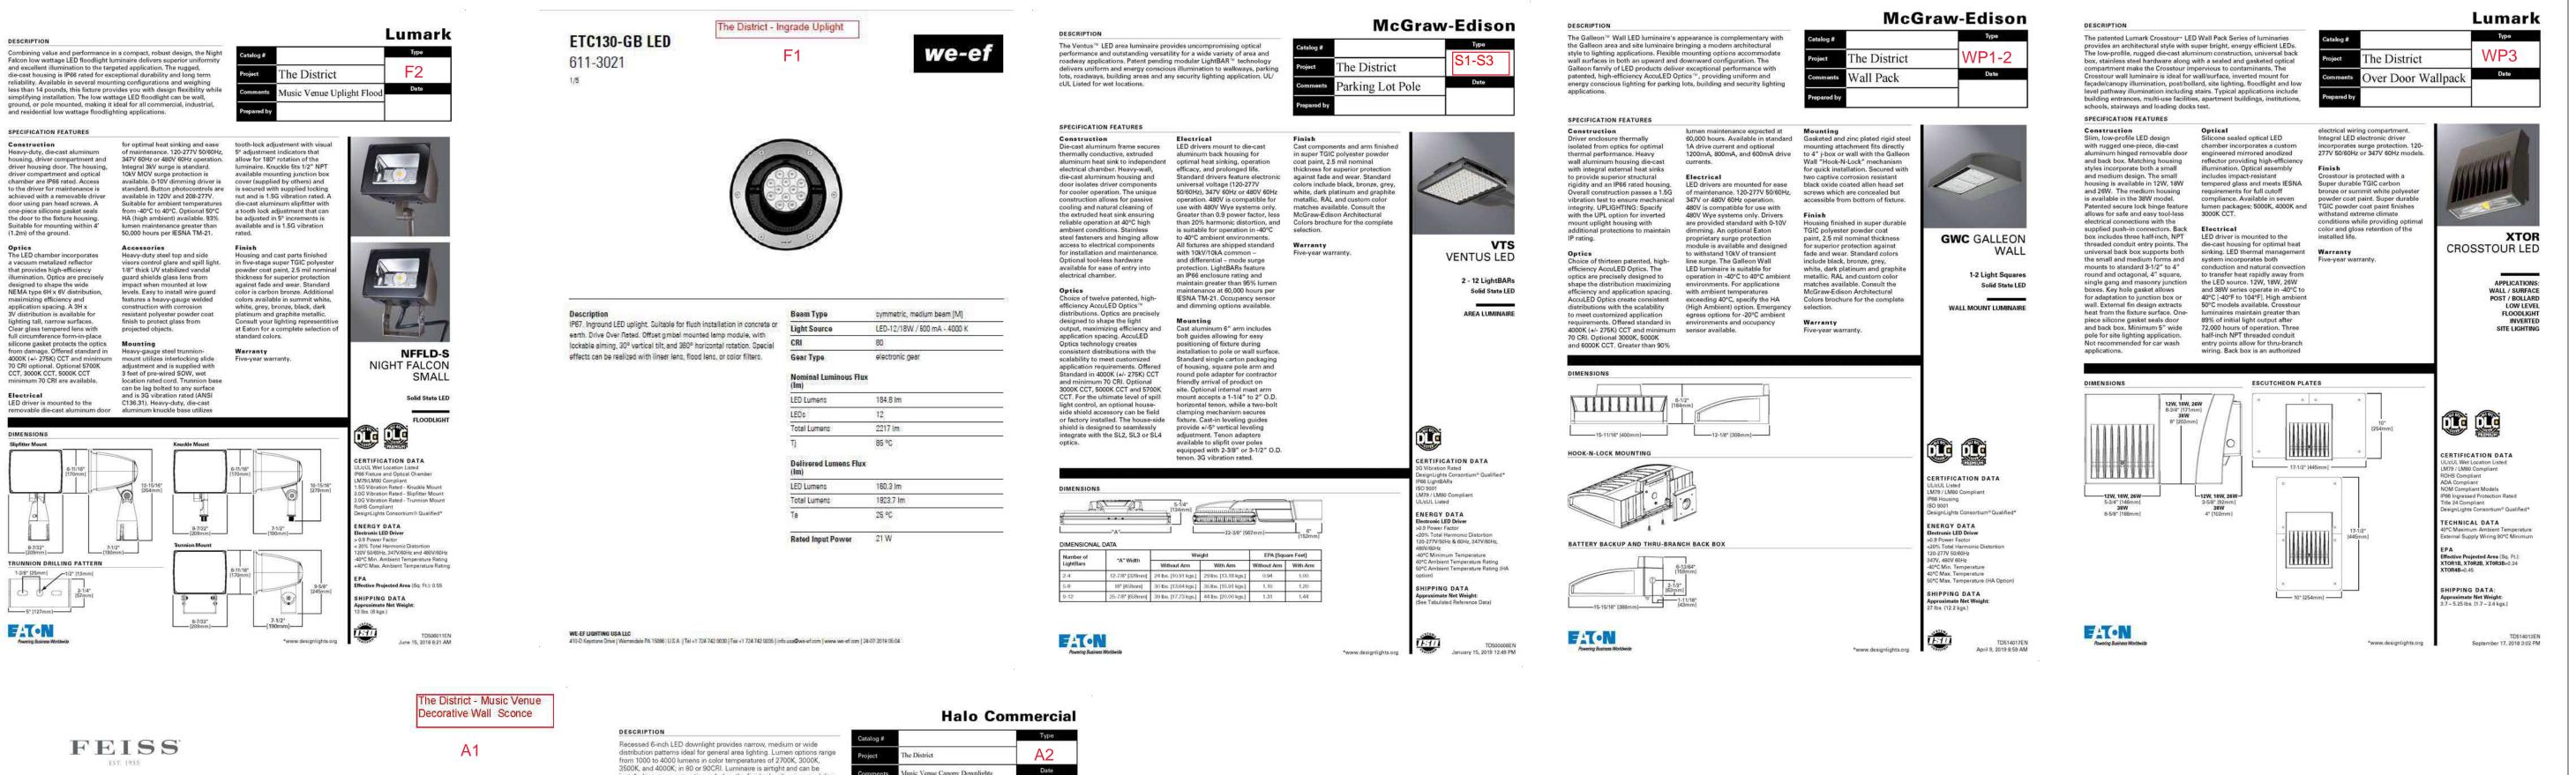

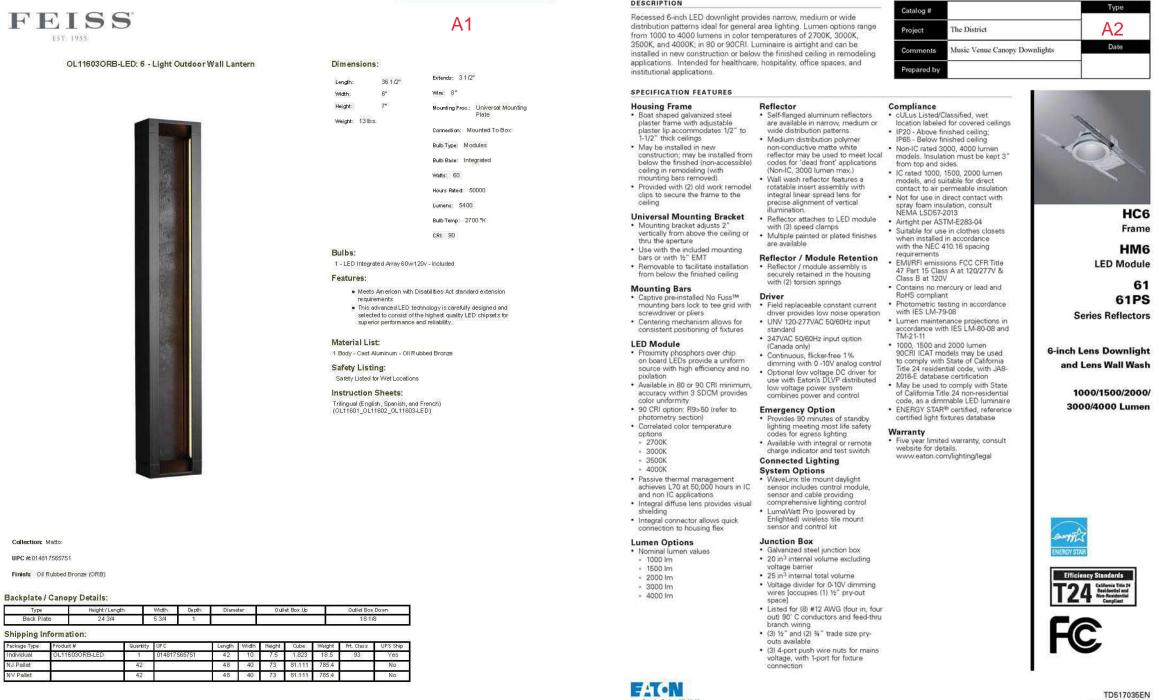

HC6

Frame

HM₆

61PS

Revisions

JGHTING ASSOIATES

SP-6

KALYPSO IP67 Static White/Tunable White/RGB



Ordering Process

Luminaire (Page 1)

24V, IP67 protected and IK10 certified, linear surface-mounted translucent end caps for a perfect light continuity. Allows

The District LED luminaire with small form factor. Polyurethane encapsulation the use of 3 linear lenses (15°, 30° or 60°) integrated in the offering a premium water proof sealing, UV resistance, chemical encapsulation material. Ideal solution for wall grazing (10°) or Project name stability and protection against abrasion. Extruded H-shaped wide flood illumination (30° and 60°) with precise light control Main Event aluminum body powder coated in white with cable runway on for outdoor or humid environments. Light source assembled Linear™ Tj Away® thin flexible circuit board technology.

Outstanding lifetime of >60,000hrs L80/B10 (>30,000 hrs RGB).

Specifier Embeds high quality japanese LEDs with 3 step MacAdams (SDCM3) binning centered on target CCT (One Bin Only) with an extended photometric code of Wxxx/339 ensuring exceptional color consistency over the rated lifetime. Premium color rendition with CRI up to 95 and TM-30-15 up to $R_f = 91 / R_g = 101$. Consistent light intensity all along the luminaire length. Fully













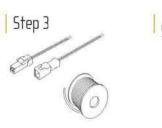

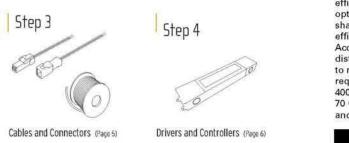

Family	Model	Lumen package ^k	Color rendering	Epilor, fer	nperature	Standard length [©]	Optic	Ingress
KALYPSO TC			W_	_	-			1P67
	HYDRA - Static White	HD06-170 lm/ft	W -80CRI	20-2000K	30-3000K	639-2 ft	-10° Optic	
		HD10-290 lm/ft	W9-90CRI®	22-2200K	35-3500K	952-3 ft	30-30° Optic	
		H015-460 lm/ft		25-2500K	40-4000K	1264-4 Ft	60-60° Optic	
		HD25-750 lm/ft		27-2700K	50-5000K	1514-5 Ft		
		-1090 lm/ft				1827-6 ft		
	IOW ATON - Tunable White	HD12-210 lm/ft	~	9	-			
	(2200K - 4000K)	HD24-440 lm/ft	-	5	2			
	RGB - 622nm (R) 532nm (G) 466nm (B)	HD20-210 lm/ft		3	=			

⁴ Lumen Values represent 5000K (W850) and with 60° optic	⁸ Only available v 3000K, 3500K a	rith HD06 and HD10 lumen pac nd 4000K	kages with 2700K,	C Values represent nominal lengths. For exact lengths, s mechanical details on page 2			
	HD6	HD10	HD15	HD25	HD36		
NAMES AND ADDRESS OF CONTROL OF A STATE OF THE STATE OF T	for surface	to the surfect	A Art and Tr	of the section	The same of the sa		

Mounting Accessories (Page 4)

			nu	noo		noo noto		HUIS		HDZJ		11030	
		Color temperature ^a	Lumen/ft	W/ft ^B	Lumen/ft	W/ft ⁸							
	W820	2,000 K	100	1.5	167	3.0	264	4.6	432	7.6	630	(11)	
	W822	2,200 K	112	1.5	188	3.0	304	4.6	493	7.6	721	11	
White	W825	2,500 K	130	1.5	215	3.0	346	4.6	563	7.6	825	11	
	W827/W927	2,700 K	115	1.5	194	3.0	368	4.6	599	7.6	874	11	
Static	W830/W930	3,000 K	118	1.5	197	3.0	389	4.6	636	7.6	929	11	
5	W835/W935	3,500 K	121	1.5	203	3.0	410	4.6	667	7.6	974	11	
	W840/W940	4,000 K	124	1.5	206	3.0	420	4.6	682	7.6	996	11	
	W850	5,000 K	170	1.5	290	3.0	460	4.6	750	7.6	1,090	11	

* CCT Tolerances occur in IP67 products due to the encapsulation of the fixture. ⁹ The given data are typical values. Due to tolerances of the production process and the electrical components, values for light output and electrical power can vary up to 10%.

LED Linear* USA, Inc. | Edition: 27/02/2019

DESCRIPTION

The Galleon™ Wall LED luminaire's appearance is complementary with the Galleon area and site lumina style to lighting applications. Fle wall surfaces in both an upware Galleon family of LED products patented, high-efficiency Accull energy conscious lighting for pa applications.

naire bringing a modern architectural	Catalog #
lexible mounting options accommodate d and downward configuration. The	Project
s deliver exceptional performance with LED Optics™, providing uniform and parking lots, building and security lighting	Comments
	Prepared by

SPECIFICATION FEATURES Construction

Driver enclosure thermally isolated from optics for optimal thermal performance. Heavy wall aluminum housing die-cast with integral external heat sinks to provide superior structural rigidity and an IP66 rated housing. Overall construction passes a 1.5G vibration test to ensure mechanical 347V or 480V 60Hz operation. integrity. UPLIGHTING: Specify with the UPL option for inverted mount uplight housing with additional protections to maintain

Choice of thirteen patented, high- line surge. The Galleon Wall efficiency AccuLED Optics. The optics are precisely designed to shape the distribution maximizing efficiency and application spacing. with ambient temperatures AccuLED Optics create consistent distributions with the scalability to meet customized application egress options for -20°C ambient requirements. Offered standard in environments and occupancy 4000K (+/- 275K) CCT and minimum sensor available. 70 CRI. Optional 3000K, 5000K and 6000K CCT. Greater than 90%

DIMENSIONS

HOOK-N-LOCK MOUNTING

ACN

BATTERY BACKUP AND THRU-BRANCH BACK BOX

lumen maintenance expected at 60,000 hours. Available in standard Gasketed and zinc plated rigid steel mounting attachment fits directly 1A drive current and optional 1200mA, 800mA, and 600mA drive to 4" j-box or wall with the Galleon Wall "Hook-N-Lock" mechanism for guick installation. Secured with two captive corrosion resistant LED drivers are mounted for ease black oxide coated allen head set of maintenance. 120-277V 50/60Hz, screws which are concealed but

Warranty

Five-year warranty.

Electrical 480V is compatible for use with 480V Wye systems only. Drivers are provided standard with 0-10V dimming. An optional Eaton TGIC polyester powder coat proprietary surge protection paint, 2.5 mil nominal thickness module is available and designed for superior protection against to withstand 10kV of transient fade and wear. Standard colors include black, bronze, grey, LED luminaire is suitable for white, dark platinum and graphite operation in -40°C to 40°C ambient metallic. RAL and custom color environments. For applications matches available. Consult the McGraw-Edison Architectural exceeding 40°C, specify the HA (High Ambient) option. Emergency

accessible from bottom of fixture. Housing finished in super durable

McGraw-Edisor

The District

Main Event Wall Pack

GWC GALLEON

1-2 Light Square

Solid State LE

Colors brochure for the complete WALL MOUNT LUMINAIR









*www.designlights.org



DESCRIPTION

The patented Lumark Crosstour™ LED Wall Pack Series of luminaries provides an architectural style with super bright, energy efficient LEDs. The low-profile, rugged die-cast aluminum construction, universal back box, stainless steel hardware along with a sealed and gasketed optical compartment make the Crosstour impervious to contaminants. The Crosstour wall luminaire is ideal for wall/surface, inverted mount for façade/canopy illumination, post/bollard, site lighting, floodlight and low level pathway illumination including stairs. Typical applications include building entrances, multi-use facilities, apartment buildings, institutions, schools, stairways and loading docks test.

SPECIFICATION FEATURES

Construction Slim, low-profile LED design with rugged one-piece, die-cast aluminum hinged removable door and back box. Matching housing styles incorporate both a small and medium design. The small housing is available in 12W, 18W and 26W. The medium housing is available in the 38W model. Patented secure lock hinge feature allows for safe and easy tool-less 3000K CCT. electrical connections with the

supplied push-in connectors. Back box includes three half-inch, NPT universal back box supports both the small and medium forms and mounts to standard 3-1/2" to 4" round and octagonal, 4" square, for adaptation to junction box or wall. External fin design extracts heat from the fixture surface. Onepiece silicone gasket seals door and back box. Minimum 5" wide pole for site lighting application. Not recommended for car wash

applications.

FATON

Silicone sealed optical LED chamber incorporates a custom engineered mirrored anodized reflector providing high-efficiency illumination. Optical assembly includes impact-resistant tempered glass and meets IESNA requirements for full cutoff compliance. Available in seven lumen packages; 5000K, 4000K and TGIC powder coat paint finishes

Electrical LED driver is mounted to the

threaded conduit entry points. The die-cast housing for optimal heat sinking. LED thermal management Warranty system incorporates both conduction and natural convection to transfer heat rapidly away from single gang and masonry junction the LED source. 12W, 18W, 26W and 38W series operate in -40°C t and 38W series operate in -40°C to 40°C [-40°F to 104°F]. High ambient 50°C models available. Crosstour luminaires maintain greater than 89% of initial light output after 72,000 hours of operation. Three half-inch NPT threaded conduit entry points allow for thru-branch wiring. Back box is an authorized




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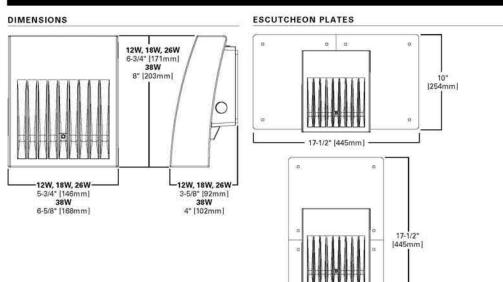
electrical wiring compartment. Integral LED electronic driver incorporates surge protection, 120-277V 50/60Hz or 347V 60Hz models.

Crosstour is protected with a Super durable TGIC carbon bronze or summit white polyester powder coat paint. Super durable withstand extreme climate conditions while providing optimal color and gloss retention of the

Five-year warranty.

CROSSTOUR LED



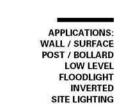



*www.designlights.org





September 17, 2018 3:02 PM



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