



690 Chesterfield Pkwy W • Chesterfield MO 63017-0760 Phone: 636-537-4000 • Fax 636-537-4798 • www.chesterfield.mo.us

Department of Planning & Public Works City of Chesterfield Public Hearing Summary Report

T.S.P. 26-2010 Clearwire US LLC. (1850 Baxter Road): A request to obtain approval for a Telecommunication Facility Siting Permit for location of antennas and equipment on an existing AmerenUE tower on a 4.71 acre "NU" Non-Urban District-zoned tract of land located northeast of Baxter Road (19S220028).

Summary

The above-referenced project is a request for a Telecommunications Siting Permit (T.S.P.). If the request is approved, the Permit will allow placement of antennas from Clearwire US LLC, on an existing AmerenUE transmission line tower located northeast of Baxter Road, south of the Baxter Lakes subdivision. Additional equipment to support the new antennas is proposed to be placed at ground level.

City of Chesterfield Ordinance 2391, which now governs telecommunications and facilities siting, requires a public hearing before the City of Chesterfield Planning Commission for the addition of telecommunications equipment on exiting high structures. Note, the Commission does not provide a recommendation to the City Council, but rather a list of issues generated during the hearing. City Council is the decision-making body for all requests for Telecommunications Siting Permits. public hearing further addressing the request will be held at the September 13, 2010 City of Chesterfield Planning Commission meeting. Attached please find a copy of the Public Hearing Notice and an application packet detailing the Petitioner's request.

Respectfully submitted,

Shawn Seymour, AICP Senior Planner

Cc: Michael G. Herring, City Administrator Rob Heggie, City Attorney

> Michael O. Geisel, Director of Planning and Public Works Aimee Nassif, Planning and Development Services Director

09/06/2010 20:31

Existing tower

NOTICE OF PUBLIC HEARING CITY OF CHESTERFIELD PLANNING COMMISSION

NOTICE IS HEREBY GIVEN that the Planning Commission of the City of Chesterfield will hold a Public Hearing on Monday, September 13, 2010, at 7:00 PM, in the Council Chambers at the City Hall, 690 Chesterfield Parkway West, Chesterfield, Missouri 63017.

Said hearing will be as follows:

T.S.P. 26-2010 Clearwire US LLC. (1850 Baxter Road): A request to obtain approval for a Telecommunication Facility Siting Permit for location of antennas and equipment on an existing AmerenUE tower on a 4.71 acre "NU" Non-Urban District-zoned tract of land located northeast of Baxter Road (19S220028).



Anyone interested in the proceedings will be given an opportunity to be heard. Copies of the request are available for review in the Department of Planning and Public Works at the Chesterfield City Hall, 690 Chesterfield Parkway West during weekdays between the hours of 8:30 a.m. and 4:30 p.m. If you should need additional information about this project, please contact Mr. Shawn P. Seymour, Senior Planner, by telephone at 636-537-4741 or by email at sseymour@chesterfield.mo.us

CITY OF CHESTERFIELD
G. Elliot Grissom, Chair
Chesterfield Planning Commission


Description of Area

A tract of land in Lot 6 of Henry Eberwein's subdivision in U.S. Survey 1978, Township 45 North, Range 4 East, and being more particularly described as follows:

Beginning at the intersection of the South line of U.S. Survey with the line of prolongation southwardly of the west line of said Lot 6; thence extending east along said survey line, 1525 feet to a point; thence north at a right angle to said survey line, 575 feet to a point; thence west parallel with said survey line, 315 feet to a point; thence south at a right angle to said last mentioned line, 555 feet to a point; thence west parallel with said survey line, 1210 feet more or less to a point in the west line of said Lot 6 or its prolongation southwardly; and thence south along the west line of said Lot 6; prolonged southwardly, 20 feet more or less to the point of the beginning.


MO-STL5433 Coverage Analysis



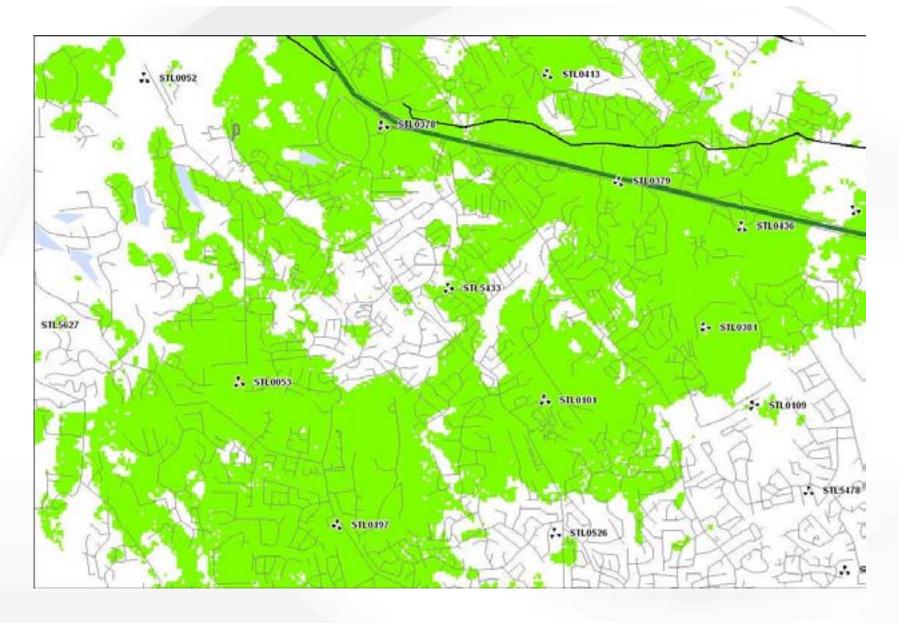

Indoor Coverage without MO-STL5433



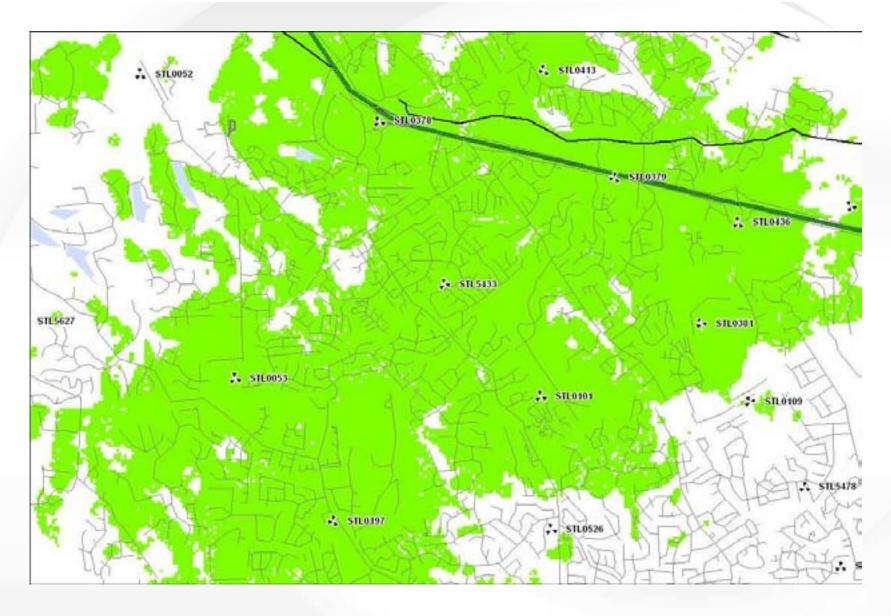

Indoor Coverage with MO-ST5433



CLEARWINE PROJECT MANAGEMENT	DATE
CLEARWIRE CONSTRUCTION MANAGEMENT	DATE
CLEARWINE ENGINEERING	DATE
BACKHAUL ENGINEERING	DATE
LANDLORD	DATE



SITE ID: MO-STL5433

MASON-LABADIE #31



DRAWING INDEX

- TITLE SHEET T-1
- S-t PARCEL PLAN
- S-2 CROSS SECTIONS
- S-3 OUT BOUNDARY SURVEY
- ENLARGED SITE PLAN & TOWER ELEVATION A-1
- A-2 ANTENNA MOUNTING DETAILS & NOTES A-3 STRUCTURAL NOTES, SECTIONS & DETAILS
- A-4 **EQUIPMENT DETAILS**
- RE/MW CONFIG A-5
- E-1 ELECTRICAL PLAN
- E-2 GROUNDING PLAN
- E-3 **ELECTRICAL DETAILS**
- E-4 GROUNDING DETAILS & NOTES
- GROUNDING ANTENNA DETAILS

CODE COMPLIANCE

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LOCKE BUILDING CODE 2.0M/robashy enormates 4.600 septimbries,

A PATERNATIONAL EXERNAL BURDING CODE PAR

· OPC SWD

SITE QUALIFICATION PARTICIPANTS

NAME

COMPANY MATTHEW MOKANYK, P.E.

LANDTECH **PUSSELL BEEN** CELLECTIVE SOLUTIONS, LLC CLEARWIPE

JASON GIBBS AMY ISENBURG LANDLORO

THE WEBERS AMEREN

CLEARWISE arry/isonourg@clearwire.com 314-554-2993

CIVILENGMEER

LANDTECH PROFESSIONAL SURVEYING AND ENGINEERING 1275 MoGREGOR WAY **CRAWN, MI 49637** P.O. BOX 193 PHONE: (231) 943-0050

SURVEYOR

LANDTECH PROFESSIONAL SURVEYING AND ENGINEERING 1275 McGREGOR WAY GRAWN, MI 49637 P.O. BOX 193 PHONE: (231) 943-0050

DIRECTIONS TO SITE
THOM THE INTERNECTION OF HAR AND 1270, USAGE! WIGST TO SIT MID, SIT AND SOUTH TO BAXTICK RD, GAZTICK RD SOUTH BAST TO SUMMER RIDGE OR, CONTINUE PAST SUMMER RIDGE OR APPROXIMATELY 0.16 WILES TO ACCESS ROAD ON THE BAST SIDE OF BAXTER RD, CONTINUE BAST ON ACCESS ROAD APPROXIMATELY 0.26 MILES TO TRANSMISSION TOWER.



PROJECT INFORMATION

THIS FACILITY IS AN UNDOCUPIED TELECOMMUNICATIONS FACILITY CONSISTING OF CO-LOCATING ON AN EXISTING STRUCTURE WITH MICROWAVE ANTENNAS. AND THE INSTALLATION OF NEW OUTDOOR COUPMENT ON GRADE.

> CONTACT. AMY ISENBURG

> > MISSOURI

1850 BAXTER ROAD CHESTERFIELD, MO 63017

EOWER OWNER.

ST LOUIS COUNTY WATER COMPANY AMEREN

P.O. BOX 66529 727 CRAXG ROAD ST LOUIS, MD 63166 ST LOUIS, MO 63141

TOWER OWNER SITEM. MASON-LABADIE #31

APPLICANT.

CLEARWIRE

4400 CARILLION POINT KIRKLAND, WA 98033

(425) 216-7600 PH (425) 216-7900 FAX

CONSTRUCTION PSWOT LANTOPE & LOVOTTUBE SASED CHANCHON

LATITUDE: 38" 38" 96.5" N LONGITUDE: 90* 33' 10.0" W

PROPOSED RAD CENTER HEIGHT. 114" AGL.

PARCEL NUMBER (TAXID) 198220029

CURRENT 20NING

TYPE OF CONSTRUCTION

PROJECT TYPE: EXISTING AMEREN POWER TOWER WITH NEW POWER MOUNT





NUMBER

231-943-0050

314-989-9810


4400 CARILLION POINT KIRKLAND, WA 98003 (425) 216-7600 PH 1425) 216-7900 FAX

SITE ID: MO-STL5433 MASON-LABADIE #31 1866 BAXTER ROAD

CHESTERRELD, MO 63017

1, 1		· ·				
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+	07/14/10	CHANGE TO POWDE WOUNT & ADD PHROLE PLAN	MRM	164	WW	1/2000000000000000000000000000000000000
0	103/12/10	PACTHONIAL OFFINES	VRM	100	NN.	CRWWYS XLMBE
100	DASE	POWERNA.	24	298/	43075	1039509

SAC

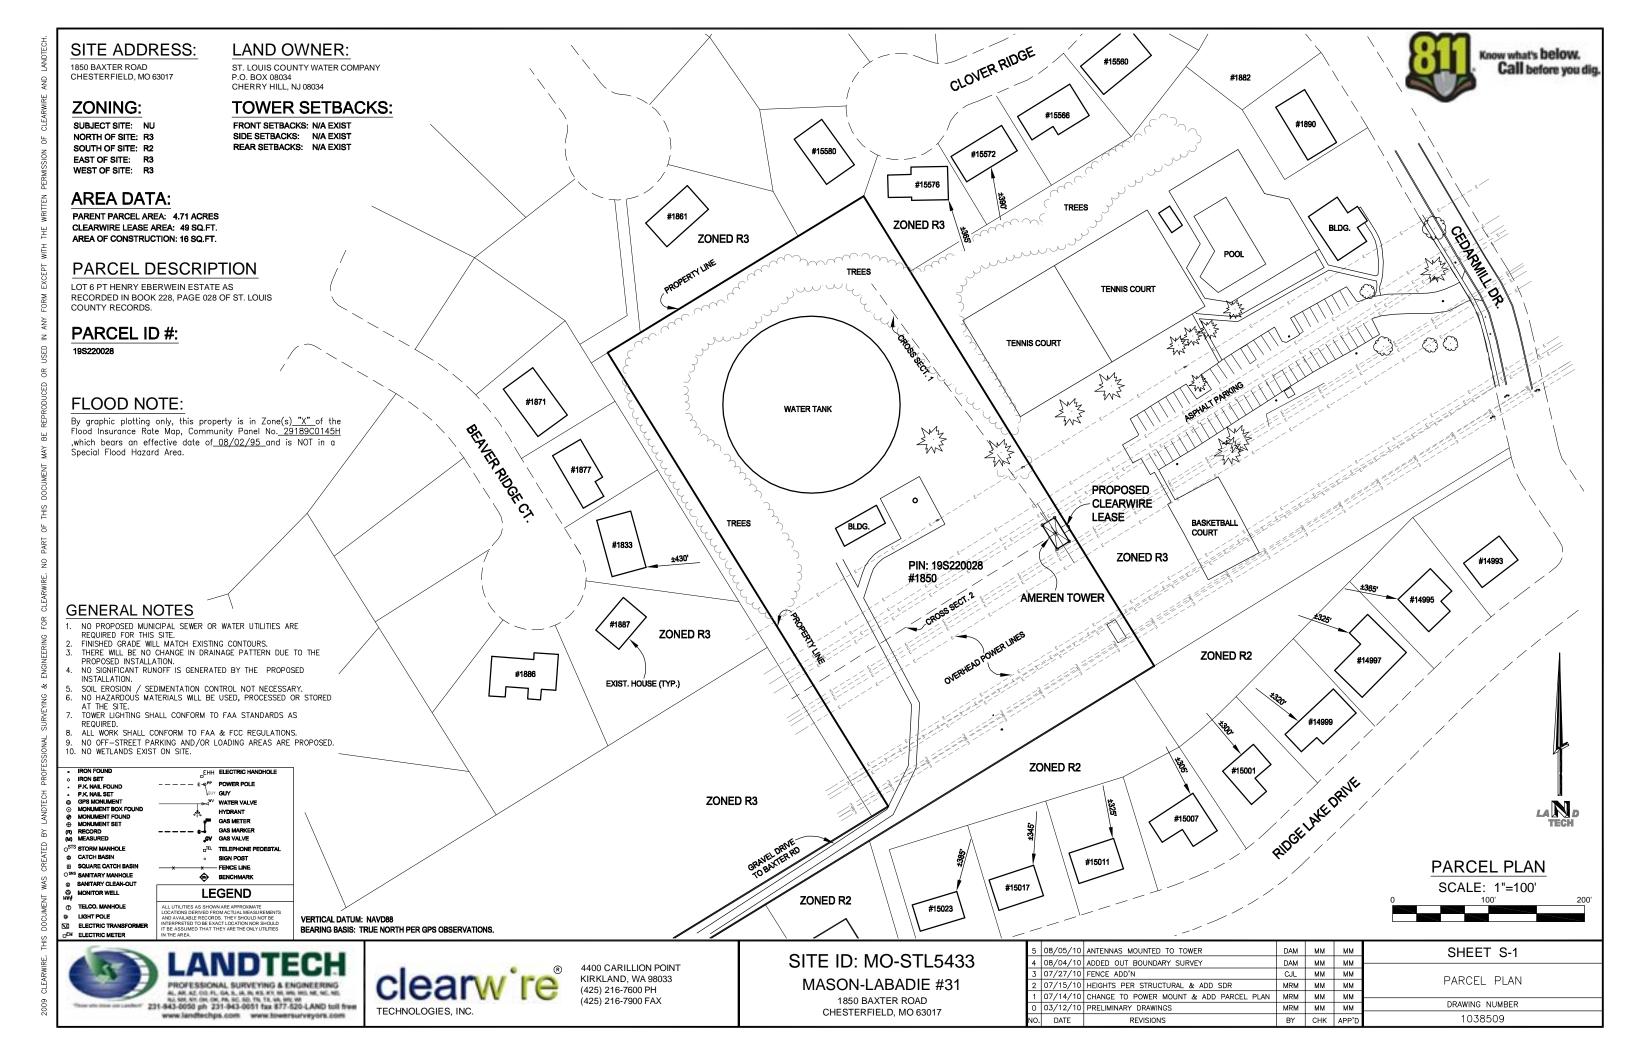

SITE ADDRESS:

1850 BAXTER ROAD CHESTERFIELD, MO 63017

ZONING:

SUBJECT SITE: NU NORTH OF SITE: R3 SOUTH OF SITE: R2 EAST OF SITE: R3 WEST OF SITE: R3

LAND OWNER:

ST. LOUIS COUNTY WATER COMPANY P.O. BOX 08034 CHERRY HILL, NJ 08034


TOWER SETBACKS:

FRONT SETBACKS: N/A EXIST SIDE SETBACKS: N/A EXIST REAR SETBACKS: N/A EXIST

AREA DATA:


PARENT PARCEL AREA: 4.71 ACRES CLEARWIRE LEASE AREA: 49 SQ.FT. AREA OF CONSTRUCTION: 16 SQ.FT.

PARCEL ID #:

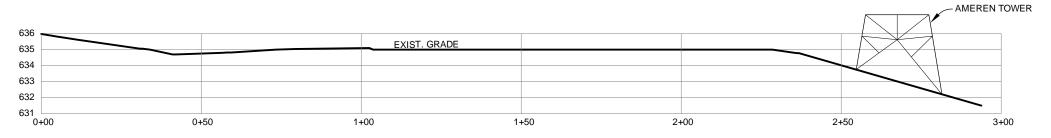

CROSS SECTION 1

HORIZONTAL SCALE: 1"=30' VERTICAL SCALE: 1"=6'

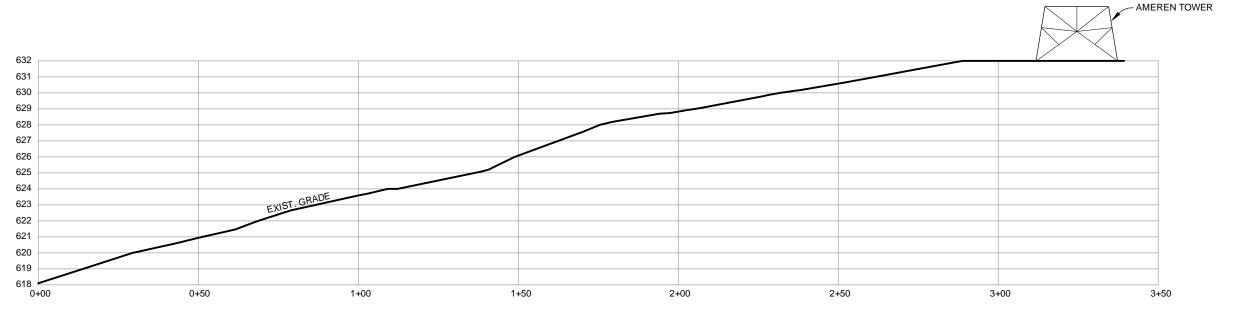

CROSS SECTION 2

HORIZONTAL SCALE: 1"=30" VERTICAL SCALE: 1"=6"

BEARING BASIS: TRUE NORTH PER GPS OBSERVATIONS.





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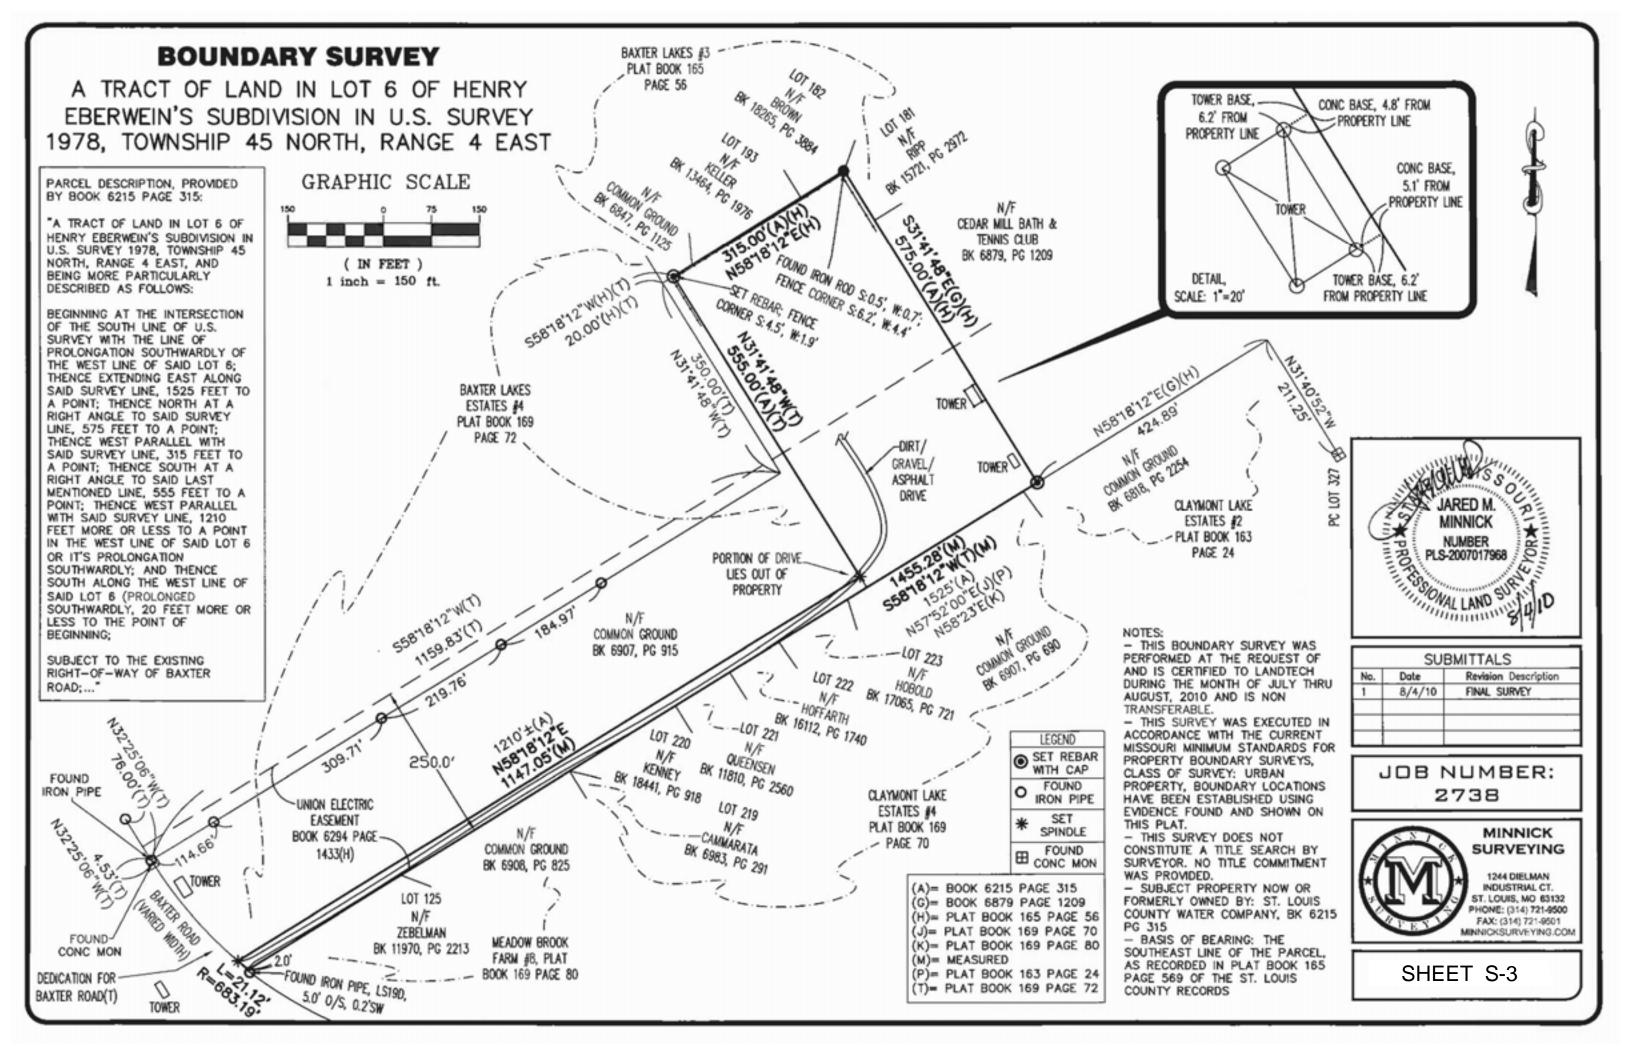
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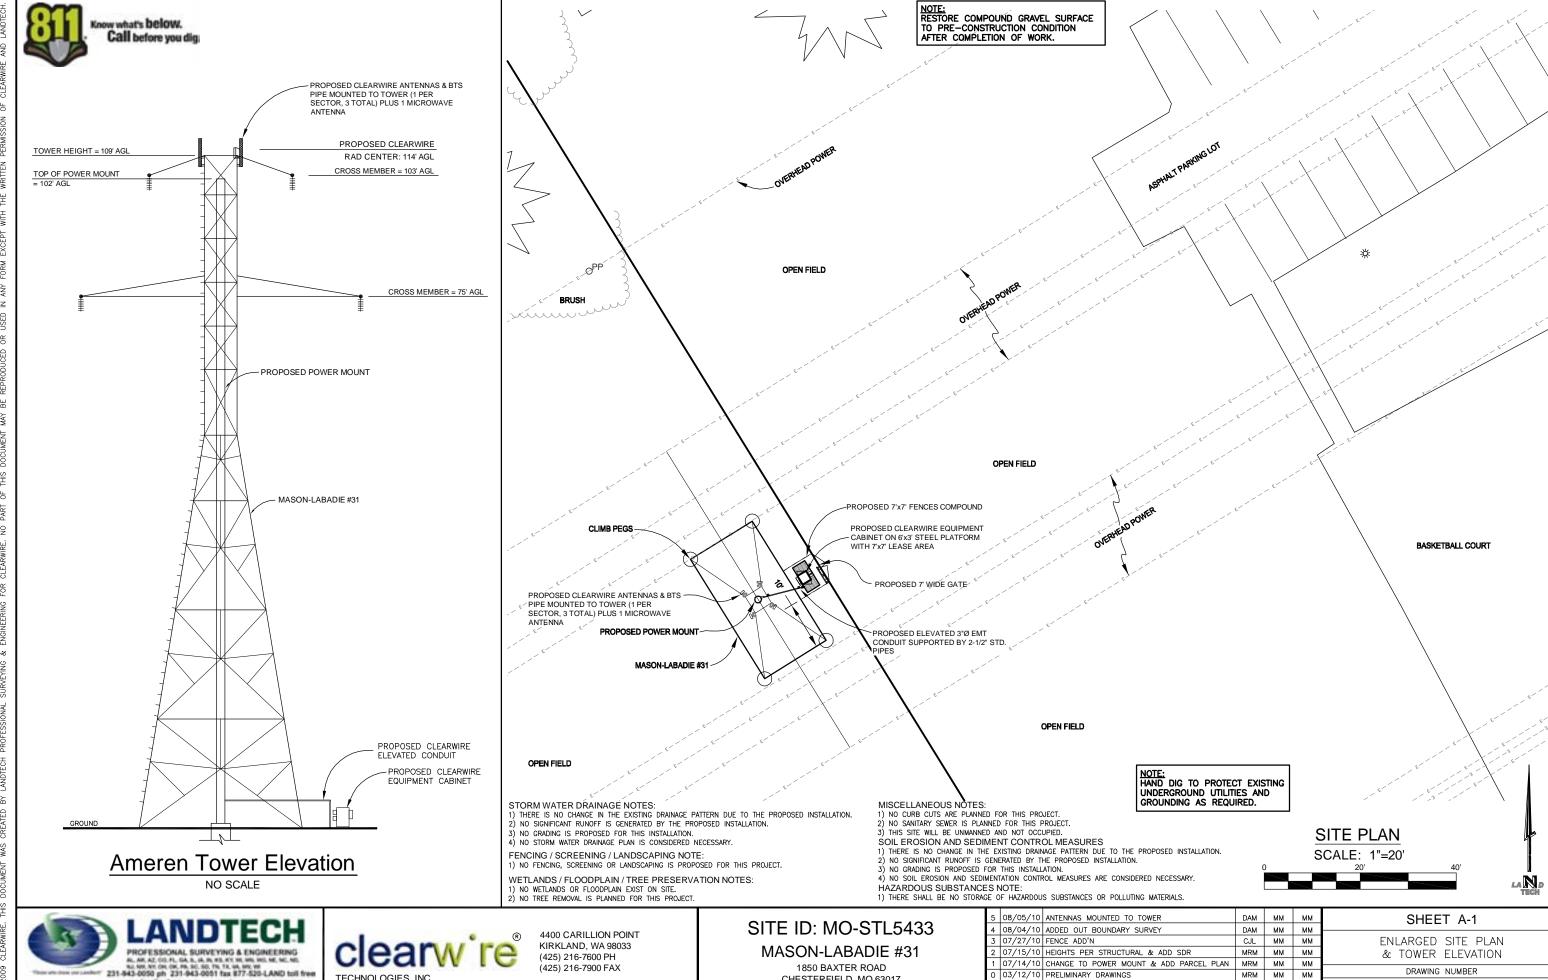
CHESTERFIELD, MO 63017

5	08/05/10	ANTENNAS MOUNTED TO TOWER	DAM	ММ	ММ	SHEET S-2
4	08/04/10	ADDED OUT BOUNDARY SURVEY	DAM	ММ	ММ	0
3	07/27/10	FENCE ADD'N	CJL	MM	MM	ADAGE CEATIONS
2	07/15/10	HEIGHTS PER STRUCTURAL & ADD SDR	MRM	MM	MM	CROSS SECTIONS
1	07/14/10	CHANGE TO POWER MOUNT & ADD PARCEL PLAN	MRM	MM	MM	
0	03/12/10	PRELIMINARY DRAWINGS	MRM	ММ	MM	DRAWING NUMBER
Ю.	DATE	REVISIONS	BY	CHK	APP'D	1038509

Know what's below.

Call before you dig.





1850 BAXTER ROAD

CHESTERFIELD, MO 63017

DRAWING NUMBER

1038509

MRM MM MM

BY CHK APP'D

0 03/12/10 PRELIMINARY DRAWINGS

DATE

(425) 216-7900 FAX

www.landtechps.com www.towersurveyors.com

SEE BLACK & VEATCH STRUCTURAL DRAWINGS FOR ANTENNA MOUNTING DETAILS.







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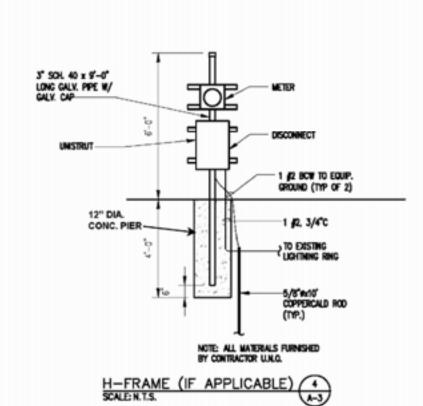
5	08/05/10	ANTENNAS MOUNTED TO TOWER	DAM	ММ	ММ	SHEET A-2
4	08/04/10	ADDED OUT BOUNDARY SURVEY	DAM	ММ	ММ	<u> </u>
3	07/27/10	FENCE ADD'N	CJL	ММ	MM	ANTENNA MOUNTING DETAILS & NOTES
2	07/15/10	HEIGHTS PER STRUCTURAL & ADD SDR	MRM	ММ	MM	ANTENNA MOUNTING DETAILS & NOTES
_	07/14/10	CHANGE TO POWER MOUNT & ADD PARCEL PLAN	MRM	ММ	MM	
0	03/12/10	PRELIMINARY DRAWINGS	MRM	ММ	ММ	DRAWING NUMBER
10.	DATE	REVISIONS	BY	СНК	APP'D	1038509




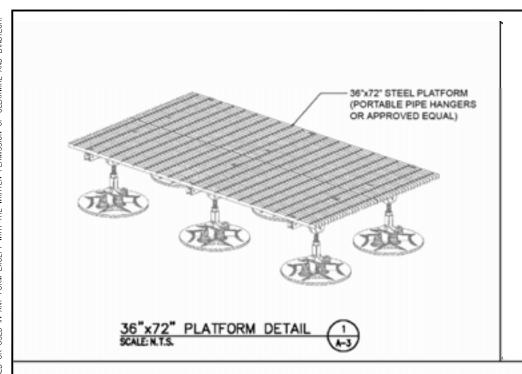

TYPICAL FENCE ELEVATION

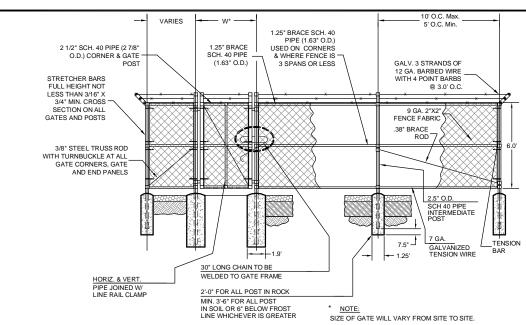NOT TO SCALE



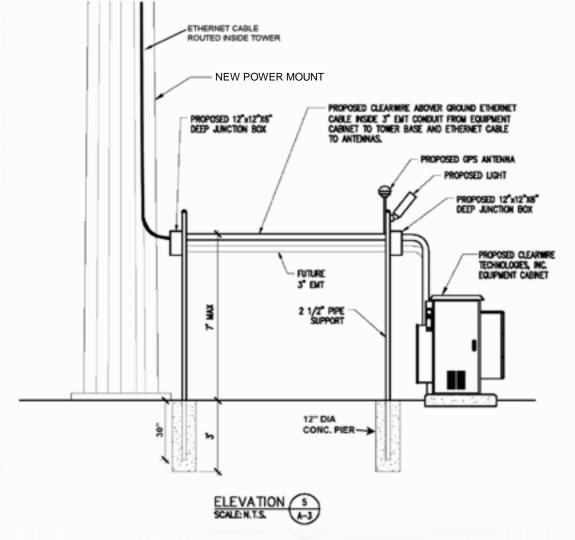


GENERAL NOTES:

- THE BASIC WHID SPEED UTILIZED FOR OUTDOOR EQUIPMENT CABINETS IS 90 MPH PER IBC (LATEST EDITION)
- Information shown on these drawnos was obtained by field measurements. The general contracotic shall verify all edisting conditions and notify the engineer of any discrepancies from to ordering materials or proceeding with construction.
- The general contractor and his subconsultants shall be responsible for obtaining all permits and inspections which may be required for the work.
- 4. STRUCTURAL STEEL SHALL CONFORM TO THE LATEST EXTRON OF THE ASC SPECIFICATIONS FOR STRUCTURAL STEEL BUILDINGS, ALLOHABLE STRESS DESIGN AND PLASTIC DESIGN INCLIDING THE COMMENTARY AND THE ASC CODE OF STANDARD PRACTICE.
- 5. STRUCTURAL STEEL PLATES AND SHAPES SHALL CONFORM TO ASTIN AXS. ALL STRUCTURAL STEEL PIPES SHALL CONFORM TO ASTIN ASS GRADE B. ALL STRUCTURAL STEEL TUBING SHALL CONFORM TO ASTIN ASCO GRADE B. ALL STRUCTURAL STEEL COMPONENTS AND FABRICATED ASSEMBLIES SHALL BE HOT DIP GALWAIZED AFTER FABRICATION.
- 6. WELDING SHALL BE IN ACCORDANCE WITH THE AMERICAN WELDING SOCIETY (AMS) 0.1.1.98. STRUCTURAL WELDING CODE-STEEL WELD ELECTRODES SHALL BE E700X FIELD TOUCH-UP WITH ZINC RICH PAINT (ALL EXISTING AND NEW AREAS) AFTER WELDING IS COMPLETE.
- 7. ALL THREADED STRUCTURAL FASTENERS FOR ANTENNA SUPPORT ASSEMBLIES SHALL CONFORM TO ASTM A307 OR ASTM A38. ALL STRUCTURAL FASTENERS FOR STRUCTURAL STEEL FRAMING SHALL CONFORM TO ASTM A325. FASTENERS SHALL BE 5/8" MIN. DAMETER BEASING TYPE CONNECTIONS WITH THREADS EXCLIDED IN THE SHEAR PLANE. ALL EXPOSED FASTENERS, NUTS, AND WASHERS SHALL BE GALVANIZED UNLESS MOTED OTHERWISE, CONCRETE EXPANSION ANCHORS SHALL BE HLTI KWIK BOLTS UNLESS NOTED OTHERWISE. ALL ANCHORS INTO CONCRETE SHALL BE STANLESS STEEL.
- 8. ALL COAXIAL CABLE CONNECTORS AND TRANSMITTER EQUIPMENT SHALL BE AS SPECIFED BY THE OWNER AND IS NOT INCLUDED IN THESE CONSTRUCTION DOCUMENTS. THE CONTRACTOR SHALL FURNISH ALL CONNECTION HARDWARE REQUIRED TO SECURE THE CABLES, ETHERNET CABLES SHALL BE ATTACHED TO THE TOWER WAVEGUIDE LADDER USING UV-RESISTANT TIE WAPS OR STAINLESS STEEL HARDWARE.
- North arrow shown on plans refers to true horth. Contractor shall verify north and inform engineer any disorepancy before starting construction.
- 10. ALL REINFORCING STEEL SHALL CONFORM TO ASTM 615 GRADE 60, DEFORMED BILLET STEEL BARS.
- CONCRETE FOR THE EQUIPMENT PAD SHALL BE 4000 PSI NORMAL WEIGHT CONCRETE WITH FREEMESH ADMIXTURE. CONTRACTOR MAY USE APPROVED PRECAST EQUIVALENT.
- 12. LUMBER SHALL COMPLY WITH THE REQUIREMENTS OF AMERICAN INSTITUTE OF TIMBER CONSTRUCTION AND THE NATIONAL FOREST PRODUCTS ASSOCIATION'S NATIONAL DESIGN SPECIFICATION FOR WOOD CONSTRUCTION. ALL LUMBER SHALL BE PRESSURE TREATED AND SHALL BE STRUCTURAL GRADE NO. 2 OR BETTER.
- 13. It is the owners responsibility to verfy the structural capacity of the easing tower and its foundation to resist the wind/gravity loads from the proposed antennas.
- 14. ALL FIELD CUT METAL WILL BE SCRAPED OF ANY RUST AND COLD GALVANIZED.
- 15. RUBBER CAPS WILL BE PLACED ON ALL EXPOSED UNISTRUT ENDS.



4400 CARILLION POINT KIRKLAND, WA 98033 (425) 216-7600 PH (425) 216-7900 FAX SITE ID: MO-STL5433 MASON-LABADIE #31


5	08/05/10	ANTENNAS MOUNTED TO TOWER	DAM	ММ	ММ	SHEET A-3
4	08/04/10	ADDED OUT BOUNDARY SURVEY	DAM	ММ	ММ	0 7.0
3	07/27/10	FENCE ADD'N	CJL	ММ	MM	STRUCTURAL NOTES,
2	07/15/10	HEIGHTS PER STRUCTURAL & ADD SDR	MRM	ММ	MM	SECTIONS & DETAILS
1	07/14/10	CHANGE TO POWER MOUNT & ADD PARCEL PLAN	MRM	ММ	MM	
0	03/12/10	PRELIMINARY DRAWINGS	MRM	MM	MM	DRAWING NUMBER
NO.	DATE	REVISIONS	BY	CHK	APP'D	1038509

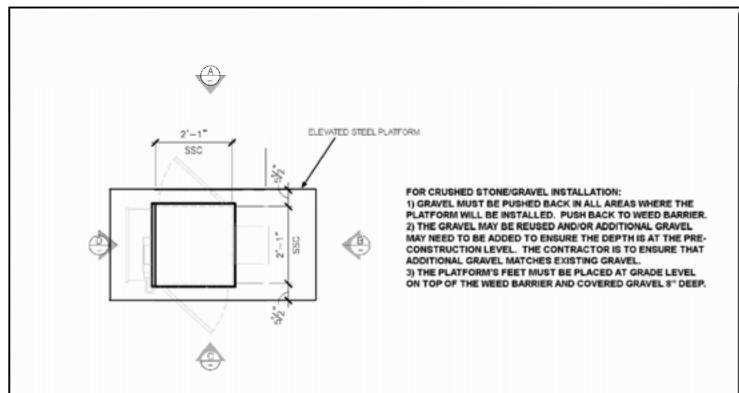



EQUIPMENT PLAN (1) SCALE: 3/8"=1"-0" (A-4) NOTE: SPECIFIC EQUIPMENT CABINET MODEL TO BE DETERMINED.




CABINET PHOTOS

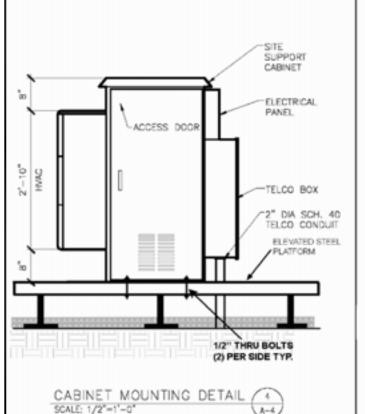

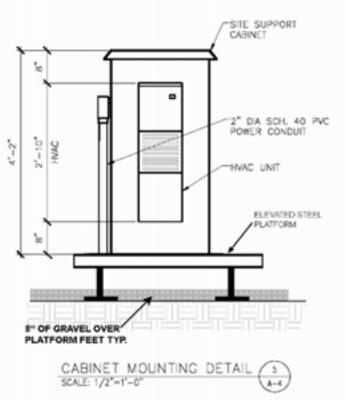

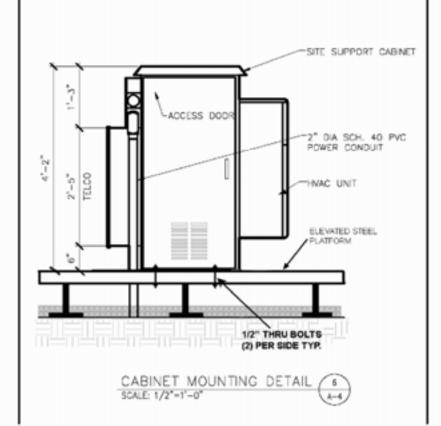

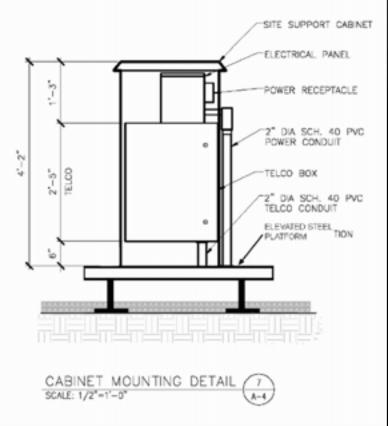





4400 CARILLION POINT KIRKLAND, WA 98033 (425) 216-7600 PH (425) 216-7900 FAX SITE ID: MO-STL5433 MASON-LABADIE #31

1850 BAXTER ROAD

CHESTERFIELD, MO 63017

5	0	8/05/10	ANTENNAS MOUNTED TO TOWER	DAM	ММ	ММ	SHEET A-4
4	- 0	8/04/10	ADDED OUT BOUNDARY SURVEY	DAM	ММ	MM	• · · · · · · · · · · · · · · · · · · ·
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2	2 0	7/15/10	HEIGHTS PER STRUCTURAL & ADD SDR	MRM	ММ	MM	EQUIPMENT DETAILS
1	0	7/14/10	CHANGE TO POWER MOUNT & ADD PARCEL PLAN	MRM	ММ	MM	
C	0	3/12/10	PRELIMINARY DRAWINGS	MRM	ММ	MM	DRAWING NUMBER
N	D.	DATE	REVISIONS	BY	СНК	APP'D	1038509


The east side of Baster Fid, continue east on access road approximately 0.25 miles to transmission tower.	Forecast, Actual) Ire Lease Complete (050 Submitted (060) Finish Approval Confirmed (Me ilding Permit (090) Finish uction Start (100) Finish uction Complete (130) F Indian (150) Finish (For initial site b Engineer Engineer Phone Engineer Phone Project Manager PM Phone sility Engineer
C: Gate Combination	Engineer J Engineer Phone Engineer Engineer Phone Project Manager M
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Contact Information NOC Phone #: 866-316-7575 Noc@clearwire.com	Engineer Phone Engineer Engineer Phone Project Manager PM Phone
C: Access Contact Name C: Property Contact Name C: Property Contact Name C: Property Contact Name C: Property Contact Phone C: Telco carrier AT&T S: Ops Manager S: BF E S: Ops Manager S: Ops Manager S: BF E S: Ops Manager S: Ops Manager S: BF E S: Ops Manager S: DF Manager S: DF Manager S: Ops Manager S: DF Manager S: Ops Manager S: DF Manager S: Ops Manager S: Ops Manager S: Ops Manager S: DF Manager S: Ops Manager S: DF Manager S: Ops Ma	Engineer Phone Engineer Engineer Phone Project Manager PM Phone
C: Access Contact Number LA: Landlord Contact Number C: Property Contact Phone C: Telco Company Contact # 800.499-7928 C: MLA Owner (1st lease) C: MLA Owner (1st lease) C: MLA Owner (1st lease) C: MLA Contact Name C: MLA Contact Name C: MLA Contact Name C: Fiber company Contact # 800.499-7928 C: Fiber company Conta	Engineer Phone Engineer Engineer Phone Project Manager PM Phone
LA: Landlord Contact Name G: Property Contact Phone G: Telco carrier AT&T S: Ops Manager S: BF E S: BF E LA: Landlord Contact Number G: Outage Contact 1 G: Telco Company Contact # 800-499-7928 S: Ops Manager Phone S: BF E C: MLA Owner (1st lease) Other ML → NA IC: Outage Contact 2 G: Fiber carrier S: Project Manager Phone S: Project Manager Phone S: BH I C: MLA Contact Name N/A → NA IC: Outage Contact 3 G: Fiber Company Contact # S: Easing Specialist S: Eve Ward S: Project Manager Phone S: BH I C: MLA Contact Phone 314-554-2993 C: Power Company Contact # B00-552-7583 S: Leasing Specialist Phone S: Construction Specialist Phone C: Face RF Information RF: Sector RF: RF: Sector Status RF: RF: RF: Sector (ft) Azmuth RF: Amenna Make/Model Chan: Chan: Channel Number Frequency Chan: Channel Status RF: Ret Quantity Action Channels Width RF: Technology MO-STL64 33c-2427 A1 Build 125 0 -4 0 LLPX310R 65deg XX-pol Argus	Engineer Engineer Phone Project Manager PM Phone
C: MLA Owner (1st lease)	Project Manager N
C: MLA Site ID N/A IC: Outage Contact 3 C: Fiber Company Contact # S: Project Manager Phone S: BH IC	PM Phone
C: MLA Contact Name C: MLA Contact Phone 314-564-2993 C: Power Company Contact # 800-562-7683 S: Leasing Specialist Phone S: Construction Specialist C: Huffman C: Fact C: Fa	
C: MLA Contact Phone Side C Face Sector Sector Sector Status Sector Sector Status Sector Secto	ility Engineer
C: MLA Contact Phone 314-654-2993	
RF Information RF Sector RF: ID RF: Sector ID Status ID RF: Sector ID RF: Azmuth ID RF: Azmuth III RF: Antenna Make/Model III Chan: Channel III Chan: Channel III RF: Ret Installed RF: Ret Installed RF: Ret Installed RF: Ret Installed Auguantity RF: Technology MO-STL64 33c-2427 A1 Build 125 0 -4 0 LLPX310R 65deg XX-pol Argus ID Chan: Channel Number Frequency Installed Quantity H-3 66 WMMAX_Motor	Eng: Phone
RF: Sector RF: ID ID Status (ft) Azmuth Tilt Tilt RF: Antenna Make/Model ID Chan: Channel Number Frequency Installed Quantity Azmuth Tilt RF: Area Model RF: Technology RF:	
RF: ID ID Status (ft) Azmuth Tilt Tilt RF: Antenna Make/Model ID Chan: Channel Number Frequency Installed Quantity Channels Width RF: Technology MO-STL54 33c-2427 A1 Build 125 0 -4 0 LLPX310R 65deg XX-pol Argus 5 1-3 65 WiMAX_Motor	
MO-STL5433c-2427 A1 Build 125 0 -4 0 LLPX310R 65deg XX-pol Argus 1-3 65 WiMAX_Motor	1200
MO-STL5433c-2443 B1 Build 125 105 -4 0 LLPX310R 65deg XX-pol Argus 1-3 65 WMAX Moto	
MO-STL54 33c-2459 C1 Build 125 240 -2 0 LLPX310R 65deg XX-pol Argus 1-3 65 WiMAX_Moto	
MW Interconnect Information	
Cand Backhaul Site Link to Configured Radio Modern Freq Equip TX Power	Target
	arization RSL ElF
MO- ODU ODU	6 8 6 9 9000 100
STL053 b Access Ring 0000053019 Build MW-Licensed 1.647 430 430 Dragonwave HD Duo 18 125 245.5761 Andrew VHLP2-18 24" (0.6096m) RF/IDU B TX-High 8.5 Vi	/ertical -41.86 45
Clearvision Site Data Report Report Date: 2010-2-25 MO-STL5433 Mason-Labadie #31	
(S: Site ID) (S: Site Name)	





4400 CARILLION POINT KIRKLAND, WA 98033 (425) 216-7600 PH (425) 216-7900 FAX SITE ID: MO-STL5433 MASON-LABADIE #31

5	08/05/10	ANTENNAS MOUNTED TO TOWER	DAM	ММ	ММ	SHEET A-5
4	08/04/10	ADDED OUT BOUNDARY SURVEY	DAM	ММ	ММ	0 7.0
3	07/27/10	FENCE ADD'N	CJL	MM	MM	DE /MW CONFIC
2	07/15/10	HEIGHTS PER STRUCTURAL & ADD SDR	MRM	MM	MM	RF/MW CONFIG
1	07/14/10	CHANGE TO POWER MOUNT & ADD PARCEL PLAN	MRM	MM	MM	
0	03/12/10	PRELIMINARY DRAWINGS	MRM	ММ	MM	DRAWING NUMBER
NO.	DATE	REVISIONS	BY	CHK	APP'D	1038509

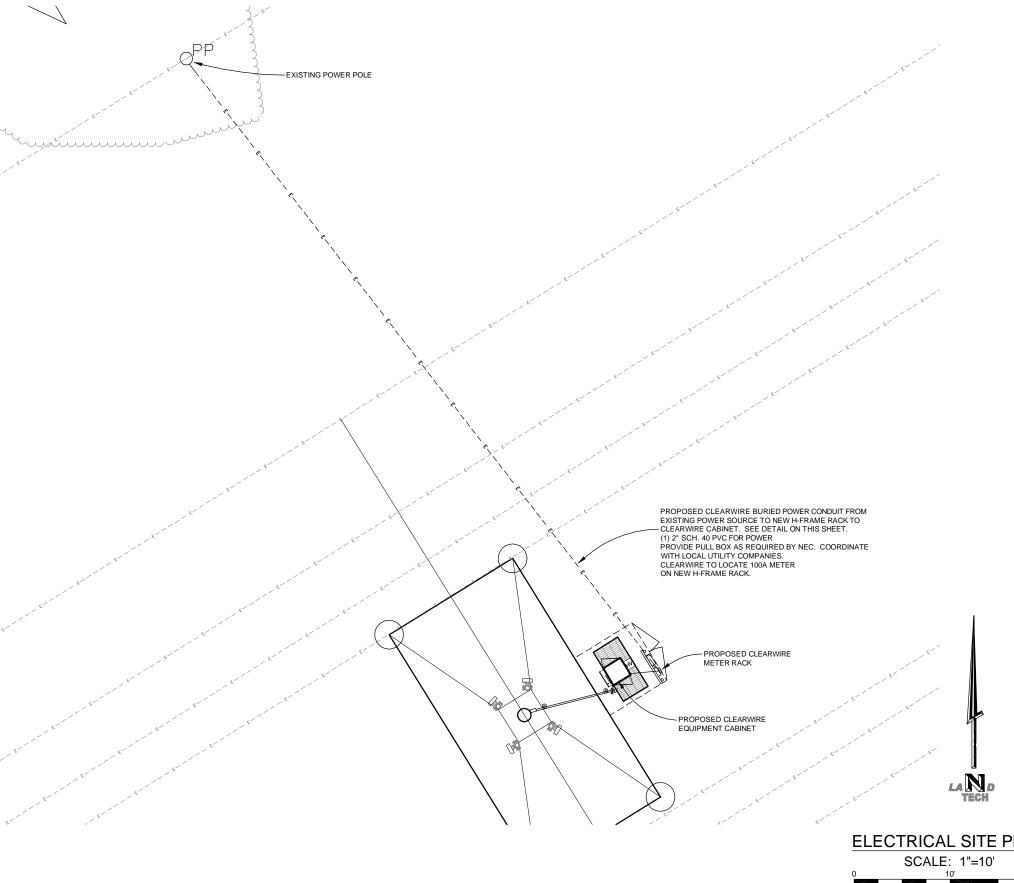

GENERAL SPECIFICATIONS:

- 1. WIRING SHALL BE AWG STRANDED COPPER WITH THHN OR EQUIVALENT INSULATION. #12 MINIMUM INSTALLED IN 1/2" MINIMUM CONDUIT, SIGNAL WIRING SHALL BE INSULATED #22 AWG. NO BX OR ROMEX CABLE IS PERMITTED. CONDUITS SHALL BE SURFACE MOUNTED.
- 2. WIRING DEVICES AND EQUIPMENT SHALL BE ULLISTED SPECIFICATIONS GRADE.
- 3. MATERIALS SHALL BE NEW AND CONFORM TO THE APPLICABLE STANDARDS ESTABLISHED FOR EACH ITEM BY THE ORGANIZATIONS LISTED BELOW.
- AMERICAN SOCIETY FOR TESTING MATERIALS (ASTM)
- UNDERWRITER'S LABORATORY (UL)
- NATIONAL ELECTRICAL MANUFACTURING ASSOCIATION (NEMA)
- AMERICAN STANDARDS ASSOCIATION (ASA)
- NATIONAL FIRE PROTECTION ASSOCIATION (NFPA)
- 4. INSTALLATION OF MATERIALS SHALL COMPLY WITH REGULATIONS OF:
- THE NATIONAL ELECTRICAL CODE (NFPA 70)
- THE NATIONAL ELECTRICAL SAFETY CODE (ANSI C-2)
- THE LIFE SAFETY CODE (NFPA 101)
- LOCAL BUILDING CODES
- 5. THE ENTIRE SYSTEM SHALL BE SOLIDLY GROUNDED USING LOCKNUTS AND BONDING NUTS ON CONDUITS AND PROPERLY BONDED GROUND CONDUCTOR. RECEPTACLES AND EQUIPMENT BRANCH CIRCUITS SHALL BE GROUNDED WITH A FULL-SIZED EQUIPMENT GROUNDING CONDUCTOR RUN IN THE CIRCUIT'S CONDUIT
- 6. OUTLET AND JUNCTION BOXES SHALL BE ZINC-COATED OR CADIUM PLATED STEEL, NOT LESS THAN 4" SQUARE AND SUITABLE FOR THE TYPE SERVICE AND OUTLET. OUTLET AND JUNCTION BOXES SHALL BE SURFACE MOUNTED AND LABELED WITH BRANCH CIRCUIT BREAKER NUMBER.
- 7. LABEL ALL EQUIPMENT SERVED FROM CLEAR WIRE TECHNOLOGIES, INC. PANEL BOARD WITH PHONEMIC LABELS SIZED IN RELATION TO USAGE.
- 8. INDOOR CONDUCTORS SHALL BE INSTALLED IN EMT UNLESS NOTED OTHERWISE. OUTDOOR CONDUCTORS SHALL BE INSTALLED IN RIGID GALVANIZED STEEL UNLESS NOTED OTHERWISE. WHERE EMT IS USED, IT SHALL BE WITH ONLY LISTED COMPRESSION FITTINGS. NO SET SCREW FITTINGS SHALL BE ALLOWED.
- 9. CONTRACTOR TO PROVIDE AND INSTALL ENGRAVED LABEL ON THE CLEARWIRE TECHNOLOGIES, INC. METER SOCKET ENCLOSURE.

ELECTRICAL SITE PLAN






4400 CARILLION POINT KIRKLAND, WA 98033 (425) 216-7600 PH (425) 216-7900 FAX

SITE ID: MO-STL5433 MASON-LABADIE #31

,	08/05/10	ANTENNAS MOUNTED TO TOWER	DAM	ММ	ММ	SHEET E-1
.	08/04/10	ADDED OUT BOUNDARY SURVEY	DAM	ММ	ММ	011221 2 1
;	07/27/10	FENCE ADD'N	CJL	ММ	ММ	ELECTRICAL CITE DI ANI
:	07/15/10	HEIGHTS PER STRUCTURAL & ADD SDR	MRM	ММ	ММ	ELECTRICAL SITE PLAN
T	07/14/10	CHANGE TO POWER MOUNT & ADD PARCEL PLAN	MRM	ММ	ММ	
)	03/12/10	PRELIMINARY DRAWINGS	MRM	ММ	ММ	DRAWING NUMBER
Э.	DATE	REVISIONS	BY	СНК	APP'D	1038509

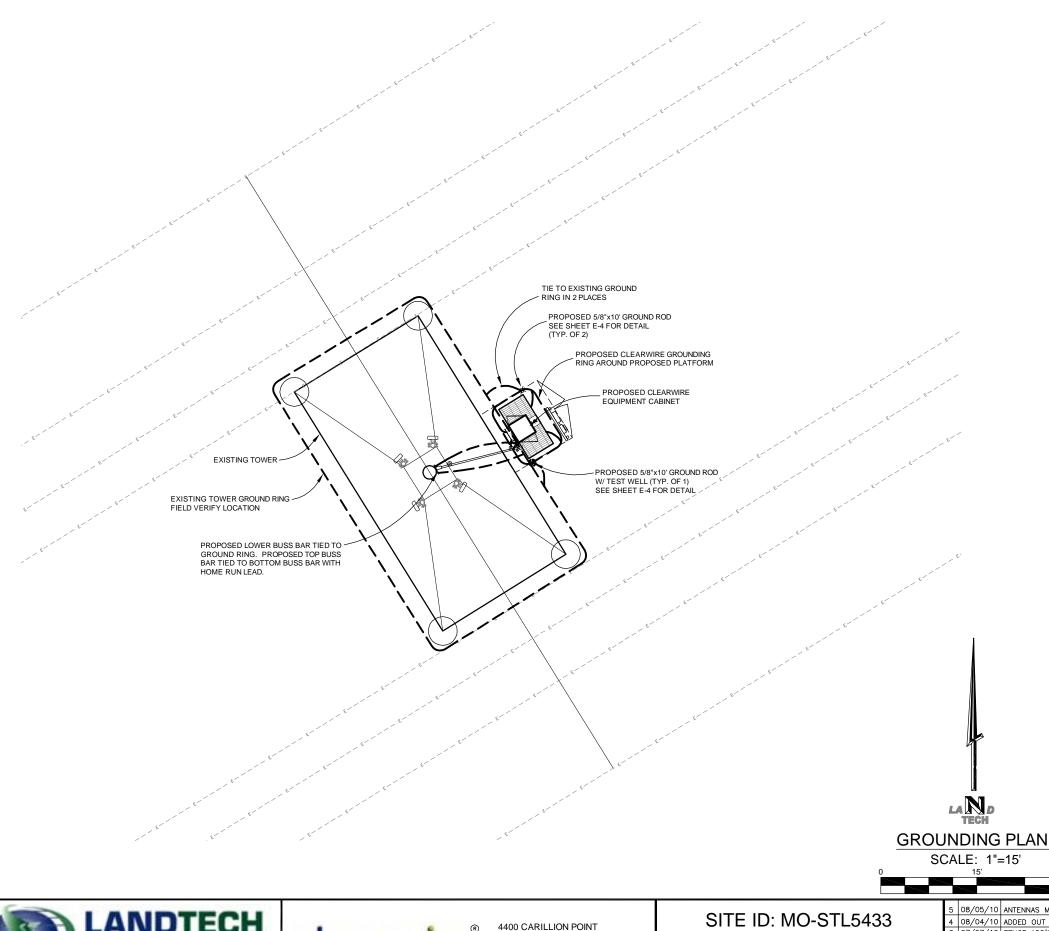

KIRKLAND, WA 98033

(425) 216-7600 PH

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GROUNDING SPECIFICATIONS:

- 1. GROUNDING SHALL COMPLY WITH ARTICLE 250 OF THE NATIONAL ELECTRICAL CODE.
- 2. ALL GROUNDING DEVICES SHALL BE U.L. APPROVED OR LISTED FOR THEIR INTENDED USE.
- A GROUND WIRES SHALL BE TIMMED #2 AWG BARE SOLID OF UNLESS MOTED OTHERWISE.
- 4. GROUNDING CONNECTIONS SHALL BE EXCHARGE (CADNELD) UNLESS NOTED OTHERWISE, CLEAN SURFACES TO SHIVEY METAL, WHERE GROUND WIRES ARE CADWELDED TO GALVANIZED SURFACES, SPRAY CADWELD WITH GALVANIZING PAINT.
- 5. ROUTE GROUNDING CONDUCTORS ALONG THE SHORTEST AND STRAIGHTEST PATH POSSIBLE, BEND GROUNDING LEADS WITH A MINIMUM 8" RADIUS.
- 6. PRIOR TO INSTALLING LIKES ON CROUND MIRES, APPLY THOMAS & BETSS KOPR-SHELD (TM OF JET LUB INC.). PRIOR TO BOLTING GROUND WIFE LINGS TO GROUND BARS, APPLY KOPR-SHELD OR EQUAL.
- 7. WHERE BARE COPPER GROUND WIRES ARE ROUTED FROM ANY CONNECTION ABOVE GRADE TO GROUND ring, install were in 3/4° puc sleeve, from 1'-0" above grade and seal top with suicone
- 8. PREPARE ALL BONDING SURFACES FOR GROUNDING CONNECTIONS BY REMOVING ALL PAINT AND CORROSION DOWN TO SHINY METAL FOLLOWING CONNECTION, APPLY APPROPRIATE ANTI-CRIDIZATION PAINT.
- 9. GROUNDING WIRE CONNECTIONS SHALL BE 3-CHAIP C-TAP COMPRESSION TYPE, SPLIT BOLTS ARE NOT
- 10. GROUND RODS SHALL BE COPPER CLAD STEEL 5/8"x10" SPACED NOT LESS THAN 10" O.C.
- 11. CONNECTORS SHALL BE CRIMPED USING HYDRAUUC CRIMPING TOOLS.
- Suppage connections shall be hade to bare metal, painted suppages shall be filed to ensure proper contact. Apply Non-Oxidizing Agent to connections.
- COPPER BUSES SHALL BE CLEANED, POLISHED AND A HON-CREATING AGENT APPLIED. NO FINGEFRENTS OR DISCOLORED COPPER WILL BE PERMITTED.
- 14. GROUNDING CONDUCTORS SHALL BE RUN THROUGH PVC SLEEVE WHERE ROUTED THROUGH WALLS, FLOORS, AND COLUNG, ENDS OF CONDUIT SHALL BE GROUNDED. SEAL BOTH DNDS OF CONDUIT WITH SUCCINE
- 15. HARDWARE (I.E. MUTS, BOLTS, WASHERS, ETC.) IS TO BE STAINLESS STEEL.
- 16. EXITHERMIC WELDS SHALL BE INSTALLED IN ACCORDANCE WITH MONUFACTURERS RECOMMENDATIONS
- 17. THE ENTIRE SYSTEM SHALL BE SOUBLY GROUNDED USING LOCKNUTS, AND BONDING MUTS ON CONDUITS AND PROPERLY BONDED GROUND CONDUCTORS, RECEPTACLES AND EQUIPMENT BRANCH CRICUITS SHALL BE GROUNDED WITH A FULL SIZED EQUIPMENT GROUNDING CONDUCTOR RUN IN THE CIRCUIT'S CONDUIT.
- 18. INSTALL GROUND BUSHINGS ON ALL WETALLIC CONDUITS AND BOND TO THE EQUIPMENT GROUND BUS IN
- 19. GROUND BARS (SECTOR, COLLECTOR, MASTER) SHALL BE BARE 1/4"X4" COPPER: LARGE ENOUGH TO accomposite the required manger of ground connections, the hardware securing the mich shall electrically insulate the mich from any structure to minch it is fastened.
- 29 APPLY TAB YOPR-SHELD OR APPROVED EQUAL PRIOR TO MAKING MECHANICAL CONNECTIONS. Conjections shall be made with stanless steel bolts, nuts and look washers 3/8" daweter MN. Where calvanizing is removed from metel. It shall be painted or toughed up with
- ALL TERMINATIONS AT EQUIPMENT ENCLOSURES, PANELS, FRANCS OF EQUIPMENT AND WHERE EXPOSED FOR GROUNDING CONDUCTOR TERMINATION SHALL BE PERFORMED UTILIZING TWO HOLE BOLTED TOMOJE COMPRESSION TYPE WITH STAMLESS STEEL SELF—TAPPING SCREWS.
- 22. ALL CLAMPS AND SUPPORTS USED TO SUPPORT THE CROWNING SYSTEM CONDUCTORS AND PVC CONDUCTS SHALL BE PVC TYPE (NON-CONDUCTIVE). DO NOT USE METAL BRACKETS OR SUPPORTS WHICH WOULD FORM A COMPLETE RING AROUND ANY GROWNING CONDUCTOR.
- 23 ALL BOLTS, WASHERS AND NUTS USED ON GROUNDING CONNECTIONS SHALL BE STAINLESS STEEL
- 24. THE CONTRACTOR SHALL ENGAGE AN INDEPENDENT ELECTRICAL TESTING FIRM TO TEST AND VERBY THAT RESISTANCE TO EARTH DOES NOT EXCEED 5.0 GIAIS. PROVIDE A COPY OF TESTING REPORT, INCLIDING THE METHOD AND INSTRUMENTS USED TO VERBY RESISTANCE TO CLEARNINE REPRESENTATIVE.
- 25,80ND CABINET THROUGH THE WAIN GROUND BAR.


GROUNDING LEGEND

INSPECTION WELL VERIFY LOCATION W/CONSTR. MGR.


> %"x10' COPPER CLAD, STEEL GROUND ROD. USE EXOTHERMIC CONNECTION TO GROUND CABLE.


#2 SOLID COPPER TINNED BURIED

BURIED GROUNDING CABLE TO CABLE CONNECTION USING EXOTHERMIC PROCESS.

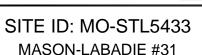

5	08/05/10	ANTENNAS MOUNTED TO TOWER	DAM	ММ	ММ	SHEET E-2
.	08/04/10	ADDED OUT BOUNDARY SURVEY	DAM	ММ	ММ	0
;	07/27/10	FENCE ADD'N	CJL	ММ	ММ	ODOLINDINO DI ANI
2	07/15/10	HEIGHTS PER STRUCTURAL & ADD SDR	MRM	ММ	MM	GROUNDING PLAN
1	07/14/10	CHANGE TO POWER MOUNT & ADD PARCEL PLAN	MRM	ММ	MM	
)	03/12/10	PRELIMINARY DRAWINGS	MRM	ММ	ММ	DRAWING NUMBER
Э.	DATE	REVISIONS	BY	СНК	APP'D	1038509

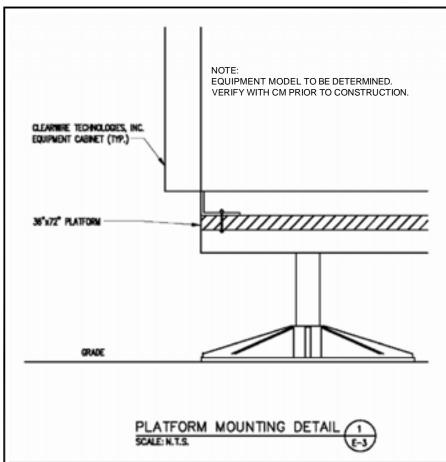


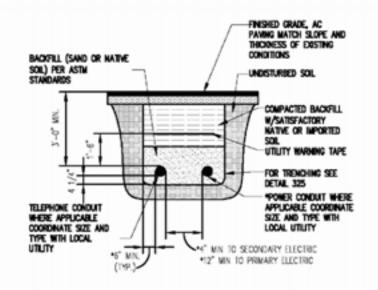


JOINT SERVICE TRENCH BURIED CONDUIT ELECT/TELEPHONE

TYPICAL TRENCH SECTION

NOTE: FIELD VERIFY EXACT LOCATION OF UTILITY SERVICE, WAX, 3/O CONDUCTOR LENGTH OF 350' FROM EXISTING UTILITY SERVICE TO LOAD CENTER.

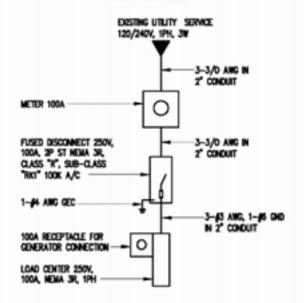



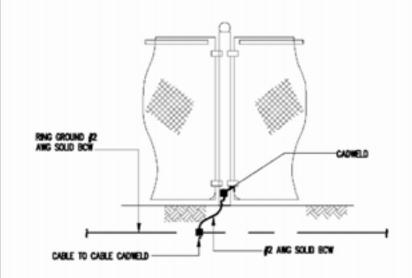

TYPICAL FENCE BONDING DETAIL SCALE: N.T.S.

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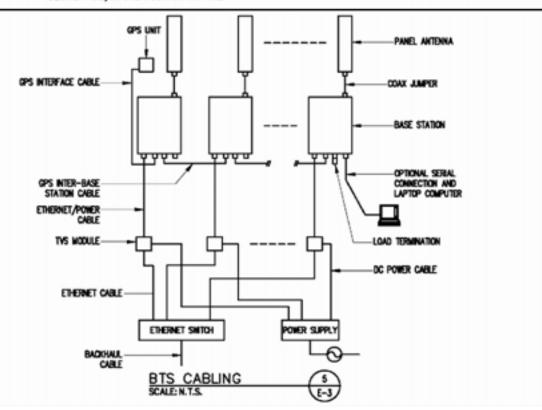
4400 CARILLION POINT KIRKLAND, WA 98033 (425) 216-7600 PH (425) 216-7900 FAX

SITE ID: MO-STL5433 MASON-LABADIE #31


1850 BAXTER ROAD CHESTERFIELD, MO 63017


GENERAL NOTES:


- 1. OBTAIN PERMITS AND PAY FEES RELATED TO ELECTRICAL WORK PERFORMED ON THIS PROJECT, DELIVER COPIES OF ALL PERMITS TO CLEARWISE TECHNOLOGIES, INC.
- 2. SCHEDULE AND ATTEND INSPECTIONS RELATED TO ELECTRICAL WORK REQUIRED BY JURISDICTION HAVING AUTHORITY, CORRECT AND PAY FOR ANY WORK REQUIRED TO PASS ANY FALLED INSPECTION.
- 3. REDUNED AS-BUILTS ARE TO BE DELIVERED TO CLEARWIFE TECHNOLOGIES, INC. REPRESENTATIVE.
- 4. PROVIDE TWO COPIES OF OPERATION AND MAINTENANCE MANUALS IN THREE-RING BINDER.
- 5. FURNISH AND INSTALL THE COMPLETE ELECTRICAL SYSTEM, TELCO SYSTEM, AND THE GROUNDING SYSTEM AS SHOWN ON THESE DRAWINGS.
- 8. ALL WORK SHALL BE PERFORMED IN STRICT ACCORDANCE WITH ALL APPLICABLE BUILDING CODES AND LOCAL ORDINANCES, INSTALLED IN A NEAT MANNER AND SHALL BE SUBJECT TO APPROVAL BY CLEARWISE
- 7. CONDUCT A PRE-CONSTRUCTION SITE VISIT AND VERIFY EXISTING SITE CONDITIONS AFFECTING THIS WORK. REPORT ANY OMISSIONS OR DISCREPANCIES FOR CLARIFICATION FROM TO THE START OF CONSTRUCTION.
- B. PROTECT ADJACENT STRUCTURES AND FINISHES FROM DAMAGE. REPAIR TO ORIGINAL CONDITION ANY DAMAGED AREA.
- 9. REMOVE DEBRIS ON A DAILY BASIS. DEBRIS NOT REMOVED IN A TIMELY FASHION WILL BE REMOVED BY OTHERS AND THE RESPONSIBLE SUBCONTRACTOR SHALL BE CHARGED ACCORDINGLY. REMOVAL OF DEBRIS SHALL BE COORDINATED WITH THE SITE OWNERS REPRESENTATIVE, DEBRIS SHALL BE REMOVED FROM THE property and disposed of Legally. Use of the property's dumpster is prohibited.
- 10. CONTRACTOR TO CONFIRM AVAILABLE CAPACITY AT EXISTING UTILITY PEDESTAL AND ADVISE ENGINEER OF SERVICE SIZE AND FAULT CURRENT LEVEL.
- 11. IF PEDESTAL DOES NOT HAVE ADEQUATE CAPACITY, CONTRACTOR TO SUBMIT COST QUOTATION TO UPGRADE, UPON APPROVAL OF SUBMITTED COST QUOTATION, THE CONTRACTOR SHALL PROVIDE NEW service and/or upgrade service. Feeders and equipment/electrode grounding conductors size.
- 12. CONTRACTOR SHALL VERFY SEPERATION DIMENSION BETWEEN POWER COMPANY ELECTRICAL CONDUITS AND LP GAS PIPES AS PER UTILITY COMPANY, LOCAL CODES, NEC. NEPA, AND GAS TANK MANUFACTURER'S
- 13. CONTRACTOR SHALL VERBY THAT THE TOTAL NUMBER OF SERVICE ENTRANCE DISCONNECTS IN THE EASTING UTILITY COMPANY PEDESTAL MUST NOT EXCEED SIX. IF THE NEW SERVICE ADDED EXCEEDS THIS VALUE, CONTRACTOR MUST COORDINATE WITH THE UTILITY COMPANY AND AUTHORITY HAVING JURISDICTION. THE RUNNING OF AM ADDITIONAL EXCLUSIVE AND DEDICATED SERVICE LATERAL SET FOR THE NEW LOAD ADDED TO THE COMPOUND AS PER NEC ARTICLE 230-2(B).
- 14. THE EQUIPMENT/PROTECTIONS MUST BE RATED FOR STANDARD AIC RATE HIGHER THAN INCOMING EQUIPMENT AND/OR UTILITY COMPANY AIC RATE.





5	08/05/10	ANTENNAS MOUNTED TO TOWER	DAM	ММ	ММ	SHEET E-3
4	08/04/10	ADDED OUT BOUNDARY SURVEY	DAM	ММ	ММ	0
3	07/27/10	FENCE ADD'N	CJL	ММ	MM	ELECTRICAL DETAILS
2	07/15/10	HEIGHTS PER STRUCTURAL & ADD SDR	MRM	ММ	MM	ELECTRICAL DETAILS
1	07/14/10	CHANGE TO POWER MOUNT & ADD PARCEL PLAN	MRM	ММ	MM	
0	03/12/10	PRELIMINARY DRAWINGS	MRM	ММ	MM	DRAWING NUMBER
NO.	DATE	REVISIONS	BY	СНК	APP'D	1038509

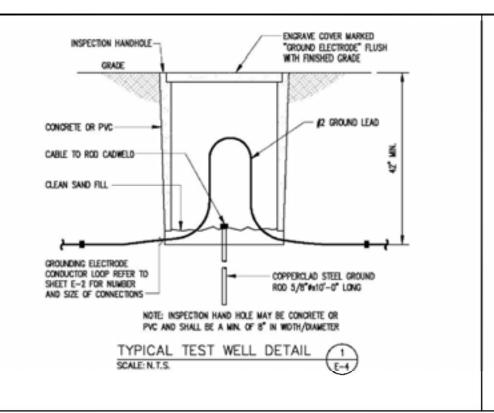

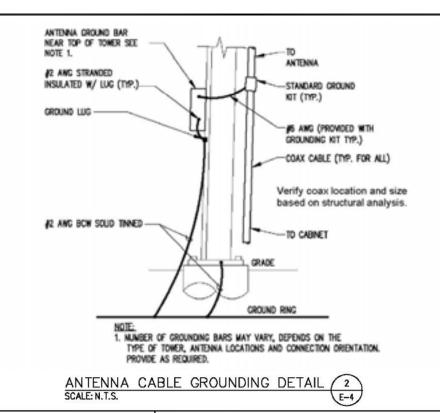

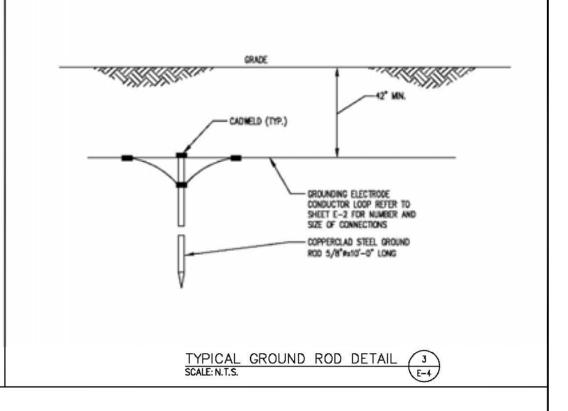

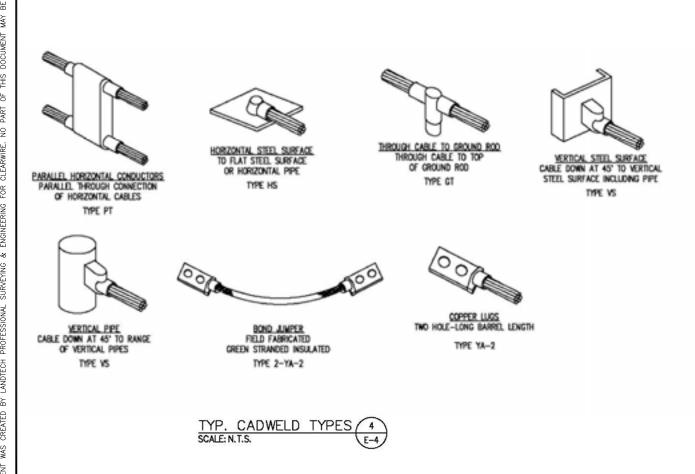

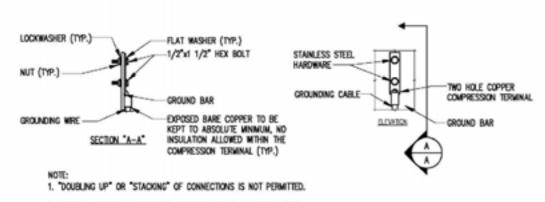

OXDE INHBITING COMPOUND TO BE USED AT ALL LOCATIONS AND TO BE APPLIED PROR TO ADDING HARDWARE.

TYPICAL GROUND BAR
CONNECTION DETAILS

SCALE: N.T.S.


5
E-4







4400 CARILLION POINT KIRKLAND, WA 98033 (425) 216-7600 PH (425) 216-7900 FAX SITE ID: MO-STL5433 MASON-LABADIE #31


5	08/05/10	ANTENNAS MOUNTED TO TOWER	DAM	ММ	ММ	SHEET E-4
4	08/04/10	ADDED OUT BOUNDARY SURVEY	DAM	ММ	ММ	<u> </u>
3	07/27/10	FENCE ADD'N	CJL	ММ	MM	ODOLINDINO DETAILO & MOTEO
2	07/15/10	HEIGHTS PER STRUCTURAL & ADD SDR	MRM	ММ	MM	GROUNDING DETAILS & NOTES
1	07/14/10	CHANGE TO POWER MOUNT & ADD PARCEL PLAN	MRM	ММ	MM	
0	03/12/10	PRELIMINARY DRAWINGS	MRM	ММ	MM	DRAWING NUMBER
10.	DATE	REVISIONS	BY	СНК	APP'D	1038509

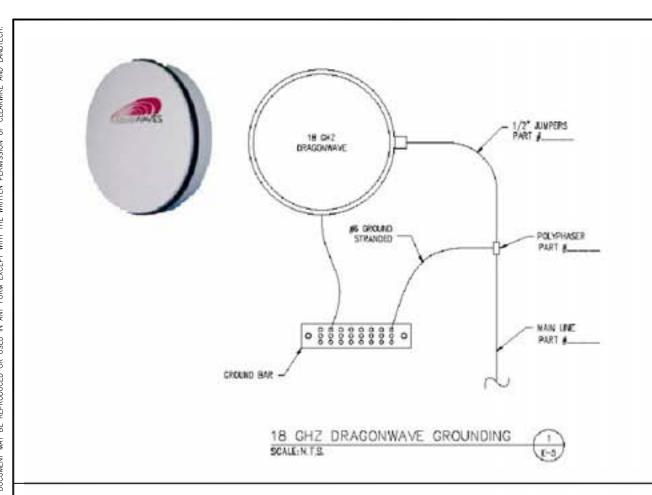

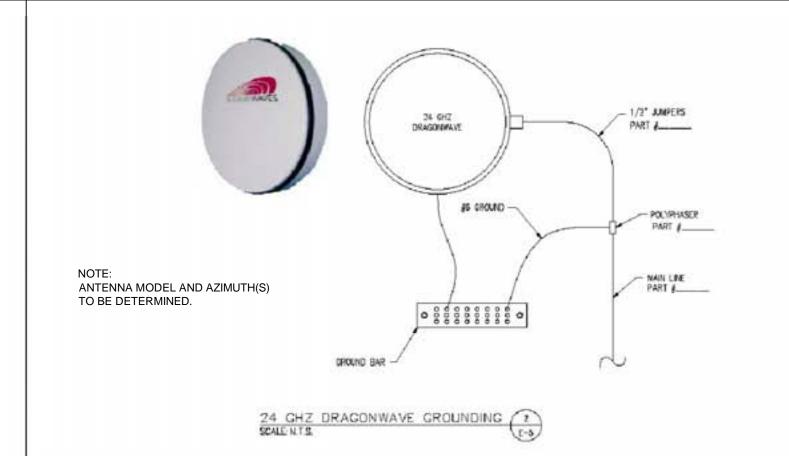

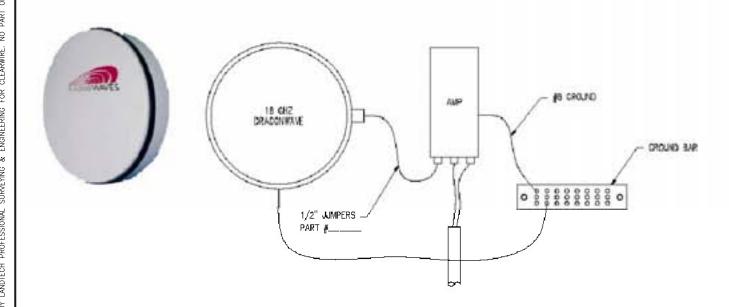

18 GHZ DRAGONWAVE/AMP GROUNDING SGALE: N.T.S. (E-5)

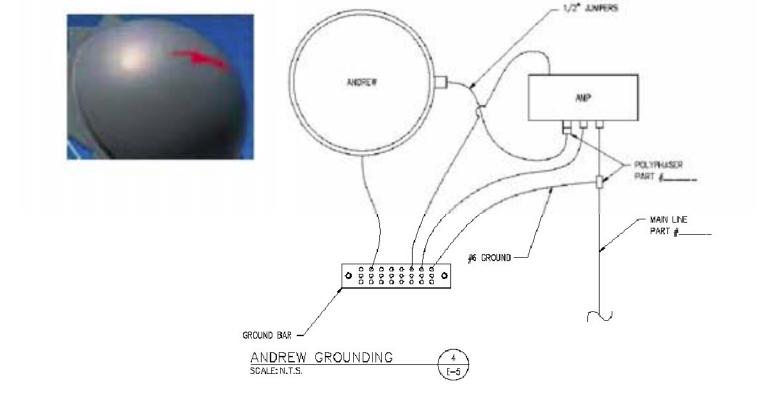





4400 CARILLION POINT KIRKLAND, WA 98033 (425) 216-7600 PH (425) 216-7900 FAX SITE ID: MO-STL5433 MASON-LABADIE #31 1850 BAXTER ROAD

CHESTERFIELD, MO 63017

	08/05/10	ANTENNAS MOUNTED TO TOWER	DAM	ММ	ММ	SHEET E-5
	08/04/10	ADDED OUT BOUNDARY SURVEY	DAM	ММ	ММ	0
	07/27/10	FENCE ADD'N	CJL	ММ	MM	ODOLINDINO ANTENNA DETAILO
	07/15/10	HEIGHTS PER STRUCTURAL & ADD SDR	MRM	ММ	MM	GROUNDING ANTENNA DETAILS
	07/14/10	CHANGE TO POWER MOUNT & ADD PARCEL PLAN	MRM	ММ	MM	
	03/12/10	PRELIMINARY DRAWINGS	MRM	ММ	MM	DRAWING NUMBER
١.	DATE	REVISIONS	BY	CHK	APP'D	1038509