



690 Chesterfield Pkwy W • Chesterfield MO 63017-0760 Phone: 636-537-4000 • Fax 636-537-4798 • www.chesterfield.mo.us

### **Planning Commission Staff Report**

**Project type:** Site Development Section Plan

Meeting Date: May 09, 2022

From: Shilpi Bharti, Planner

**Location:** 701 Trade Center Blvd.

Description: Terra Corporate Park, Lot 7 (Scooter's Coffee) SDSP: Site Development Section Plan,

Landscape Plan, Lighting Plan and Amended Architectural Elevations for a drive-up coffee shop located on a 0.84-acre tract of land located west of Trade Center Blvd. and north of

Chesterfield Airport Road, zoned "PI" Planned Industrial.

#### **PROPOSAL SUMMARY**

Sherrill Associates, Inc. and Good Grounds Properties, LLC has submitted a Site Development Section Plan, Landscape Plan, Lighting Plan, and Amended Architectural Elevations for a proposed coffee shop Scooter's Coffee located at 701 Trade Center Blvd.

Proposed Development includes:

- 664 square feet of coffee shop
- 7 parking spaces for employees
- Stacking space for two drive-thru service lanes
- Landscaping
- Lighting Plan
- Photometric Plan



Figure 1: Subject Location

#### **HISTORY OF SUBJECT SITE**

The subject site was zoned "M3" under St. Louis County Ordinance 8898. The site was rezoned from "M3-Planned Industrial District" to "PI-Planned Industrial District" in 2001 following the City of Chesterfield Ordinance 1708. Since then, the ordinance was amended to modify usage permitted under this "PI" district. The current ordinance governing the site is City Ordinance 2395 approved in 2007, which repealed City Ordinance 2245 to amend allowable building square footage requirements. The Terra Corporate Park Concept Plan was approved in 2007.

#### SURROUNDING LAND USE AND ZONING

The subject site is zoned PI- Planned Industrial. North, east and west of the subject site is zoned PI-Planned Industrial. South of the subject site is zoned M3- Planned Industrial.

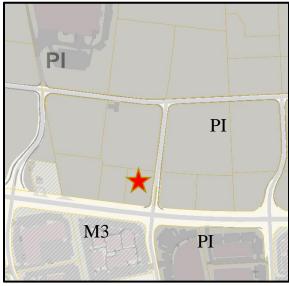


Figure 2: Zoning Map

#### **COMPREHENSIVE PLAN**

The subject site is located within Ward 4 of the City of

Chesterfield. The City of Chesterfield Comprehensive Plan contains the City of Chesterfield Land Use Plan, which is helpful in determining the future use of the site. As per the City of Chesterfield Land Use Plan, the subject site is within the Industrial land use. The subject site is surrounded by Industrial on the east, north and south. The Industrial land use typically supports manufacturing and production uses, including warehousing, distribution, light manufacturing, airport support businesses and assembly operations. They are found in close proximity to major transportation corridors and are generally buffered from surrounding development by traditional uses or landscaped areas that shield the view of structures, loading docks, or outdoor storage from adjacent properties. Below are the development policies for Industrial land use as described in the City of Chesterfield Comprehensive Plan.

- Limit curb cuts on arterial streets, and where possible concentrate access at shared entrance points.
- Primary entrance points should be aligned with access points immediately across the street.
- Connectivity may vary as industrial parks may have low connectivity due to dead ends and lack of connection to adjacent areas.
- Landscape buffering should be utilized between roadways to screen areas of surface parking.

Residential projects should be limited to areas outside of the Chesterfield Valley.

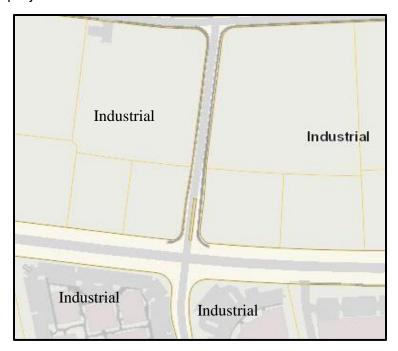


Figure 3: Land Use map

### **STAFF ANALYSIS**

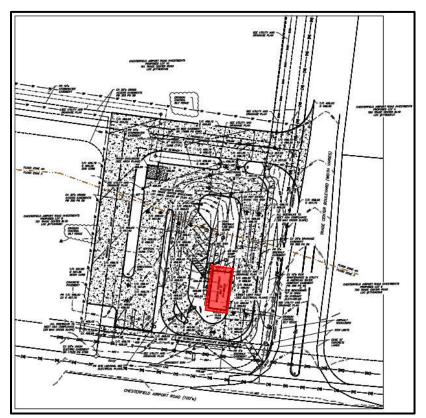


Figure 4: Site Plan

#### **Site Relationships**

The proposed building is 664 square feet on 0.84 acres of land. The subject site is one small lot of Terra Corporate Subdivision. The Subdivision Concept Plan was approved in 2007, but currently the entire subdivision is vacant land. Proposed development "Scooter Coffee" is the first site to be developed in this subdivision. The building design is of a similar height to the adjacent building across Chesterfield Airport Road. As per the applicant, the site is primarily designed to provide fast and efficient movement of vehicles around the building.

#### **Circulation System and Access**

The site access matches the Terra Corporate subdivision concept plan. The site is accessed through a new primary roadway from Trade Center Blvd. Ingress and Egress drives will then connect to this roadway at two locations. The proposed roadway has cross-access easement between the adjacent properties on north and west of the subject site. Two 12' wide drive thru lanes is proposed with stacking capacity of seven cars per lane. Internal driveways are 24' wide with two-way access. Sidewalk is proposed along Chesterfield Airport Road. As per City of Chesterfield Unified Development Code, four (4) minimum parking are required for the proposed development. There is total seven (7) parking spaces provided on site.

#### Scale, Topography, Retaining Wall and Screening

The site sits vacant and is surrounded by vacant land on the north, east and west. Buildings to the south are primarily one-story. The proposed building on the site is a single-story building of similar height and scale. The site is relatively flat with minor grade change at the center. There is no retaining wall or screening proposed.

#### **Elevations**

The four sides of the building façade consist of Manganese Brown Endicott Thin Brick Veneer, Skyline Steel Painted Hardie Reveal Panel, and Deep Forest Brown painted flat roof. The store front and metal trims are dark bronze Aluminum. Additionally, terracotta-colored awnings are proposed for windows.

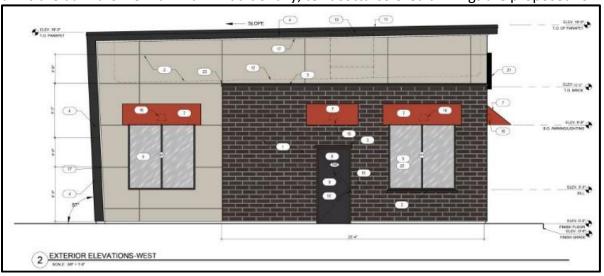


Figure 5: East side Elevations

#### Lighting

There are four (4) different types of light fixtures proposed for this development. There are eight (8) wall lights and two (2) pole lights. Additionally, the building is illuminated by white led lighting running along the sides and roof.

#### Landscaping

As per City of Chesterfield Unified Development Code Section 405.04.020, Table 2, "minimum of 30' wide landscape buffer strip is required for development along an arterial roadway". The proposed development faces a minor arterial roadway (Chesterfield Airport Road) and has depicted a 30' landscape buffer. Applicant was referred to follow City Code Section 405.04.020 (J) for plant selection percentage. The proposed landscape plan of the site consists of four (4) different types of tree canopies, four (4) different types of shrubs, one (1) accent plant, and two (2) different types of groundcovers.

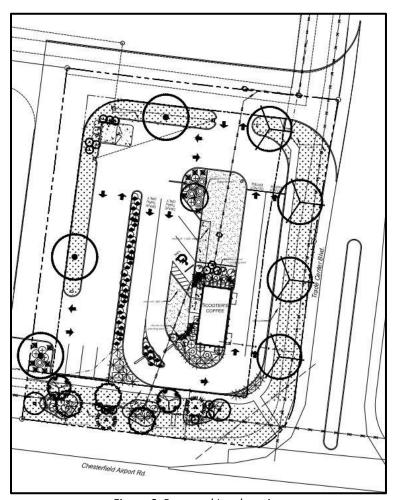


Figure 6: Proposed Landscaping

#### **ARB Meeting Report**

The project was reviewed by the Architectural Review Board on February 10, 2022. At that time, the Board made a motion to forward the Site Development Section Plan, Landscape Plan, Lighting Plan,

Amended Architectural Elevations and Architect's Statement of Design to the Planning Commission with a recommendation to approve with the following conditions:

- 1. The material that was not called out in the ARB package serving as a cap to the brick of the trash enclosure shall be of a similar material and color as the building.
- 2. A material sample of the spandrel glass shall be provided to the Board as it was absent from the ARB package and it shall be of a logical color to coordinate with the building.
- 3. Additional landscaping shall be provided to screen the view of the transformer on the southern boundary.
- 4. Additional landscaping shall be incorporated around the trash enclosure to properly screen and soften the edge of the site.
- 5. The light levels along the southern boundary shall preclude any spillover light on adjacent properties throughout the review of the site plan.
- 6. Further consideration shall be made to remove or relocate the tree (River Birch) at the northwest corner of the building so that it is not too close to the building structure and has room to mature.

The applicant has since addressed all the comments.

#### **DEPARTMENTAL INPUT**

Staff has reviewed this proposed development and found it to be in compliance with the City's Unified Development Code and site-specific ordinances. All outstanding comments have been addressed at this time. As per site-specific ordinance, the proposed project has automatic power of review. Staff recommends approval of the Site Development Section Plan, Landscape Plan, Lighting Plan and Amended Architectural Elevations for Terra Corporate Park Lot 7, 701 Trade Center Blvd. (Scooter's Coffee):

#### **MOTION**

The following options are provided to the Planning Commission for consideration relative to this application:

- 1) "I move to approve (or deny) the Site Development Section Plan, Landscape Plan, Lighting Plan and Amended Architectural Elevations for Terra Corporate Park Lot 7, 701 Trade Center Blvd. (Scooter's Coffee) as presented."
- 2) "I move to approve the Site Development Section Plan, Landscape Plan, Lighting Plan and Amended Architectural Elevations for Terra Corporate Park Lot 7, 701 Trade Center Blvd. (Scooter's Coffee) with the following conditions..." (Conditions may be added, eliminated, altered or modified)

Attachments: Site Development Section Plan Packet



### SHERRILL ASSOCIATES, INC.

#### Surveyors – Engineers – Planners IDOT Certified DBE

316 North Main Street Edwardsville, IL 62025 Phone: 618-656-9251 Fax: 618-656-9496

March 14, 2022

RE: City of Chesterfield, MO - Code Comment Response for 16006 Manchester Road (Scooter's Coffee)

Shilpi Bharti Planner (636)537-4743 Sbharti@chesterfield.mo.us

Ms. Shilpi,

The following responses are in regard to the City of Chesterfield, MO Code Comments received on 2/16/22.

#### **General Comments:**

1. **Comment:** Provide agency approvals/ comments from Monarch Fire, St. Louis County Department of Transportation, Levee District, and Spirit of St. Louis Airport.

**Response:** Submittals to these agencies will follow this submittal and we will provide approvals and comments as they are received.

2. **Comment:** Please show the street light location on the site plan.

**Response:** A street light has been added along the Trade Center Blvd frontage. See Sheet C1.0 Proposed Site Plan and the electrical plans.

3. **Comment:** Sheet C2.0 and C3.0 will not be reviewed under Site Plan Review process, please remove these sheets from future submittal.

**Response:** The sheets will not be included in the following submittal.

#### Site Development Section Plan, Landscape Plan and Lighting Plan:

4. **Comment:** The location of the access points to the internal drives have been revised to match the approved Amended Site Development Concept Plan (ASDCP), as requested in the previous comment letter. However, the plans were not updated to show construction of the associated portions of the north and west internal drives between the access points. Please update the plans to show construction of the internal drives and related improvements north and west of the property to provide internal circulation to the two access points.

**Response:** Internal drives between the access points has been show. See Sheet C1.0.

5. **Comment:** Provide a street light along the Chesterfield Airport Road frontage.

**Response:** See Sheet C1.0 Proposed Site Plan and the electrical plans.

6. **Comment:** The summary table on the site plan show proposed open space as 39%, please confirm if the open space calculation accounted for future road expansion on the north and west.

**Response:** The proposed open space has been updated. See Sheet CO.O.

7. **Comment:** The sidewalk provided at an intersection of Chesterfield Airport Road and N Trade Center Blvd. does not match with the approved Concept Plan of Terra Corporate Park subdivision. The sidewalk layout requires modification to the existing island on North Trade Boulevard for the pedestrians to cross the roadway. Provide a note to indicate that a cross walk will be built through the existing island to provide ADA compliant cross walk for pedestrians as part of this project. Design of the crosswalk will need to be addressed with Improvement Plans.

**Response:** The sidewalk has been updated to match the approved Concept Plan of Terra Corporate Park subdivision.

8. **Comment:** Per City code section 405.04.020 Table 2, "30' landscape buffer strip shall be provided on the site facing arterial road", please provide a 30' landscape buffer along Chesterfield Airport Road. Please refer to City Code Section 405.04.020, J for Plant selections. Provide mixture of deciduous trees, evergreen trees, and shrubs.

Response: See Landscape Plan.

9. **Comment:** The Photometric Plan shows the light level for "SB" as 7.8 fc on the south end of the property, either provide a Photometric Plan showing the light level will be 0.0 fc on the boundary or have a note on the plan that there will be no spill over.

Response: See Electrical Plans.

#### **ARB Comments:**

10. **Comment:** The material that was not called out in the ARB package serving as a cap to the brick of the trash enclosure shall be of a similar material and color as the building.

Response: See Trash Enclosure detail.

11. **Comment:** A material sample of the spandrel glass shall be provided to the Board as it was absent from the ARB package and it shall be of a logical color to coordinate with the building.

**Response:** A material sample has been mailed to the City.

12. **Comment:** Additional landscaping shall be provided to screen the view of the transformer on the southern boundary.

**Response:** Additional shrubs were added around the sides of the transformer.

13. **Comment:** Additional landscaping shall be incorporated around the trash enclosure to properly screen and soften the edge of the site.

**Response:** Additional 6' tall shrubs were added around the 3 sides of the trash enclosure.

14. **Comment:** The light levels along the southern boundary shall preclude any spillover light on adjacent properties throughout the review of the site plan.

**Response:** See Electrical Plans.

15. **Comment:** Further consideration shall be made to remove or relocate the tree (River Birch) at the northwest corner of the building so that it is not too close to the building structure and has room to mature.

**Response:** The tree adjacent to the building was removed.

Respectfully,

Wilson D. Waggoner, P.E. Director of Civil Engineering

Wilson D. Waggoner

Sherrill Associates, Inc.



May 3, 2022

Scooter's - Chesterfield MO

City of Chesterfield Planning Department 690 Chesterfield Parkway West Chesterfield, Missouri 63005

To Whom It May Concern,

FM GROUP is pleased to submit Scooter's Coffee to The City of Chesterfield Planning Commission for their consideration. This submittal package, includes the Statement of Design showing how the design standards are being addressed based on the city zoning code.

#### STATEMENT OF DESIGN INTENT

#### **General Requirements for Site Design**

#### **Site Relationship**

Scooter's is a drive thru only coffee kiosk. The brand model is built on speed and the ability to move vehicles quickly. The stated mission is "Amazing people, Amazing drinks... Amazingly fast!" The site is designed with this motto in mind.

The site is primarily designed to provide fast and efficient movement of vehicles around the building. Although there is no pedestrian traffic to and from the proposed building, sidewalks have been added along both Chesterfield Airport Rd. and Trade Center Blvd.

The landscape design surrounds the building on all four sides and large canopy trees have been added in these areas.

#### **Circulation System and Access**

The site has been designed with a new primary roadway from Trade Center Blvd. Ingress and Egress drives will then connect to this roadway at two locations.

Once on-site vehicle traffic moves in a circular path around the building. Primarily using oneway traffic makes it easy for the customers to navigate the site and virtually eliminates any cross traffic.

To ensure that there are no cars in the queue backing up on the public streets, two drive-thru order lanes with a double menu board system is being utilized. The use of two drive thru lanes for ordering provides additional on-site stacking during peak services time.



Employee parking is located near the building with three stalls within the interior island and four stalls at the south end of the site. Employees will enter and leave the site with ease even during peak hours. Accessible parking is conveniently located near the entrance door.

#### **Topography**

The existing site is relatively flat and currently exists as a vacant parcel. Minor grading will be required to provide accessible access into the building.

#### **Retaining Walls and Screen Walls**

No retaining or screen walls are proposed.

#### **General Requirements for Building Design**

#### Scale

Currently there are no existing structures to the north, west, or east of the proposed building. Buildings to the south are primarily one-story. A single-story building of similar height and scale is being proposed.

#### Design

The design of the building is well coordinated with the design of the buildings in the general vicinity. Many of the buildings along Chesterfield Airport Blvd use brick accent areas in their design. Brick veneer will be used in specific areas along the front and side elevations of the building as a contrasting accent. The Hardie Panel Reveal System is being used in the balance of the Elevations. Hardie Panel is a durable siding that maintains its appearance for a long time. The Hardie Panel system with reveal has a contemporary clean look and is similar in design and appearance to many of the nearby buildings. A flat roof with high parapet screens the mechanical equipment and matches back to many buildings along Chesterfield Airport Blvd. Fabric awnings highlight the building.

#### **Materials and Colors**

This area in Chesterfield has beautiful trees and green open space. To compliment this and coordinate with nearby buildings, a neutral color palette with hues selected from nature are being used. The dark brown brick veneer is in high contrast to the tan colored Hardie panels. The storefront and metal trim details are a dark bronze. Finally, terracotta-colored awnings provide a small burst of color to set these areas apart. Please refer to the exterior renderings for more visual presentation.

#### **Landscape Design and Screening**

A thoughtful approach to landscape design and screening has been taken. Shade trees have been added throughout the site, but particularly in the parking areas and along the street frontage. Turf is proposed along the street front for both Trade Center Blvd and Chesterfield Airport Blvd. This approach matches that of the neighboring lots along Chesterfield Airport Blvd. Foundation plantings have been added around the building.



Dumpster enclosure and service areas have evergreen shrubs planted to provide year-round screening. In addition to screening from landscaping, the dumpster enclosure is screened with a CMU screen walls and painted metal gates.

#### Signage

It is understood that signage review is not part of this process and will be reviewed in a separate submittal.

#### Lighting

The site lighting primarily consists of building lighting and specific lighting adjacent to various building functions for drive thru and menu board access. The building lighting is achieved with the use of wall mounted luminaires to highlight the walls and LED strip lighting is being proposed at the parapet level housed in a metal reveal around the entire building. Photometrics and fixture cut sheets have been provided in the submittal package for your reference.


Thank you for your consideration. If you have any questions or comments, please me at 480.397.0048.


Sincerely,


**FM GROUP INC** 


Michele M. McCoy Senior Project Manager mmccoy@fmgroup.net


15974 N 77th Street, Suite 100 | Scottsdale, AZ 85260 | Tel: 602.277.7877 | Fax: 602.277.8288 | www.fmgroup.net

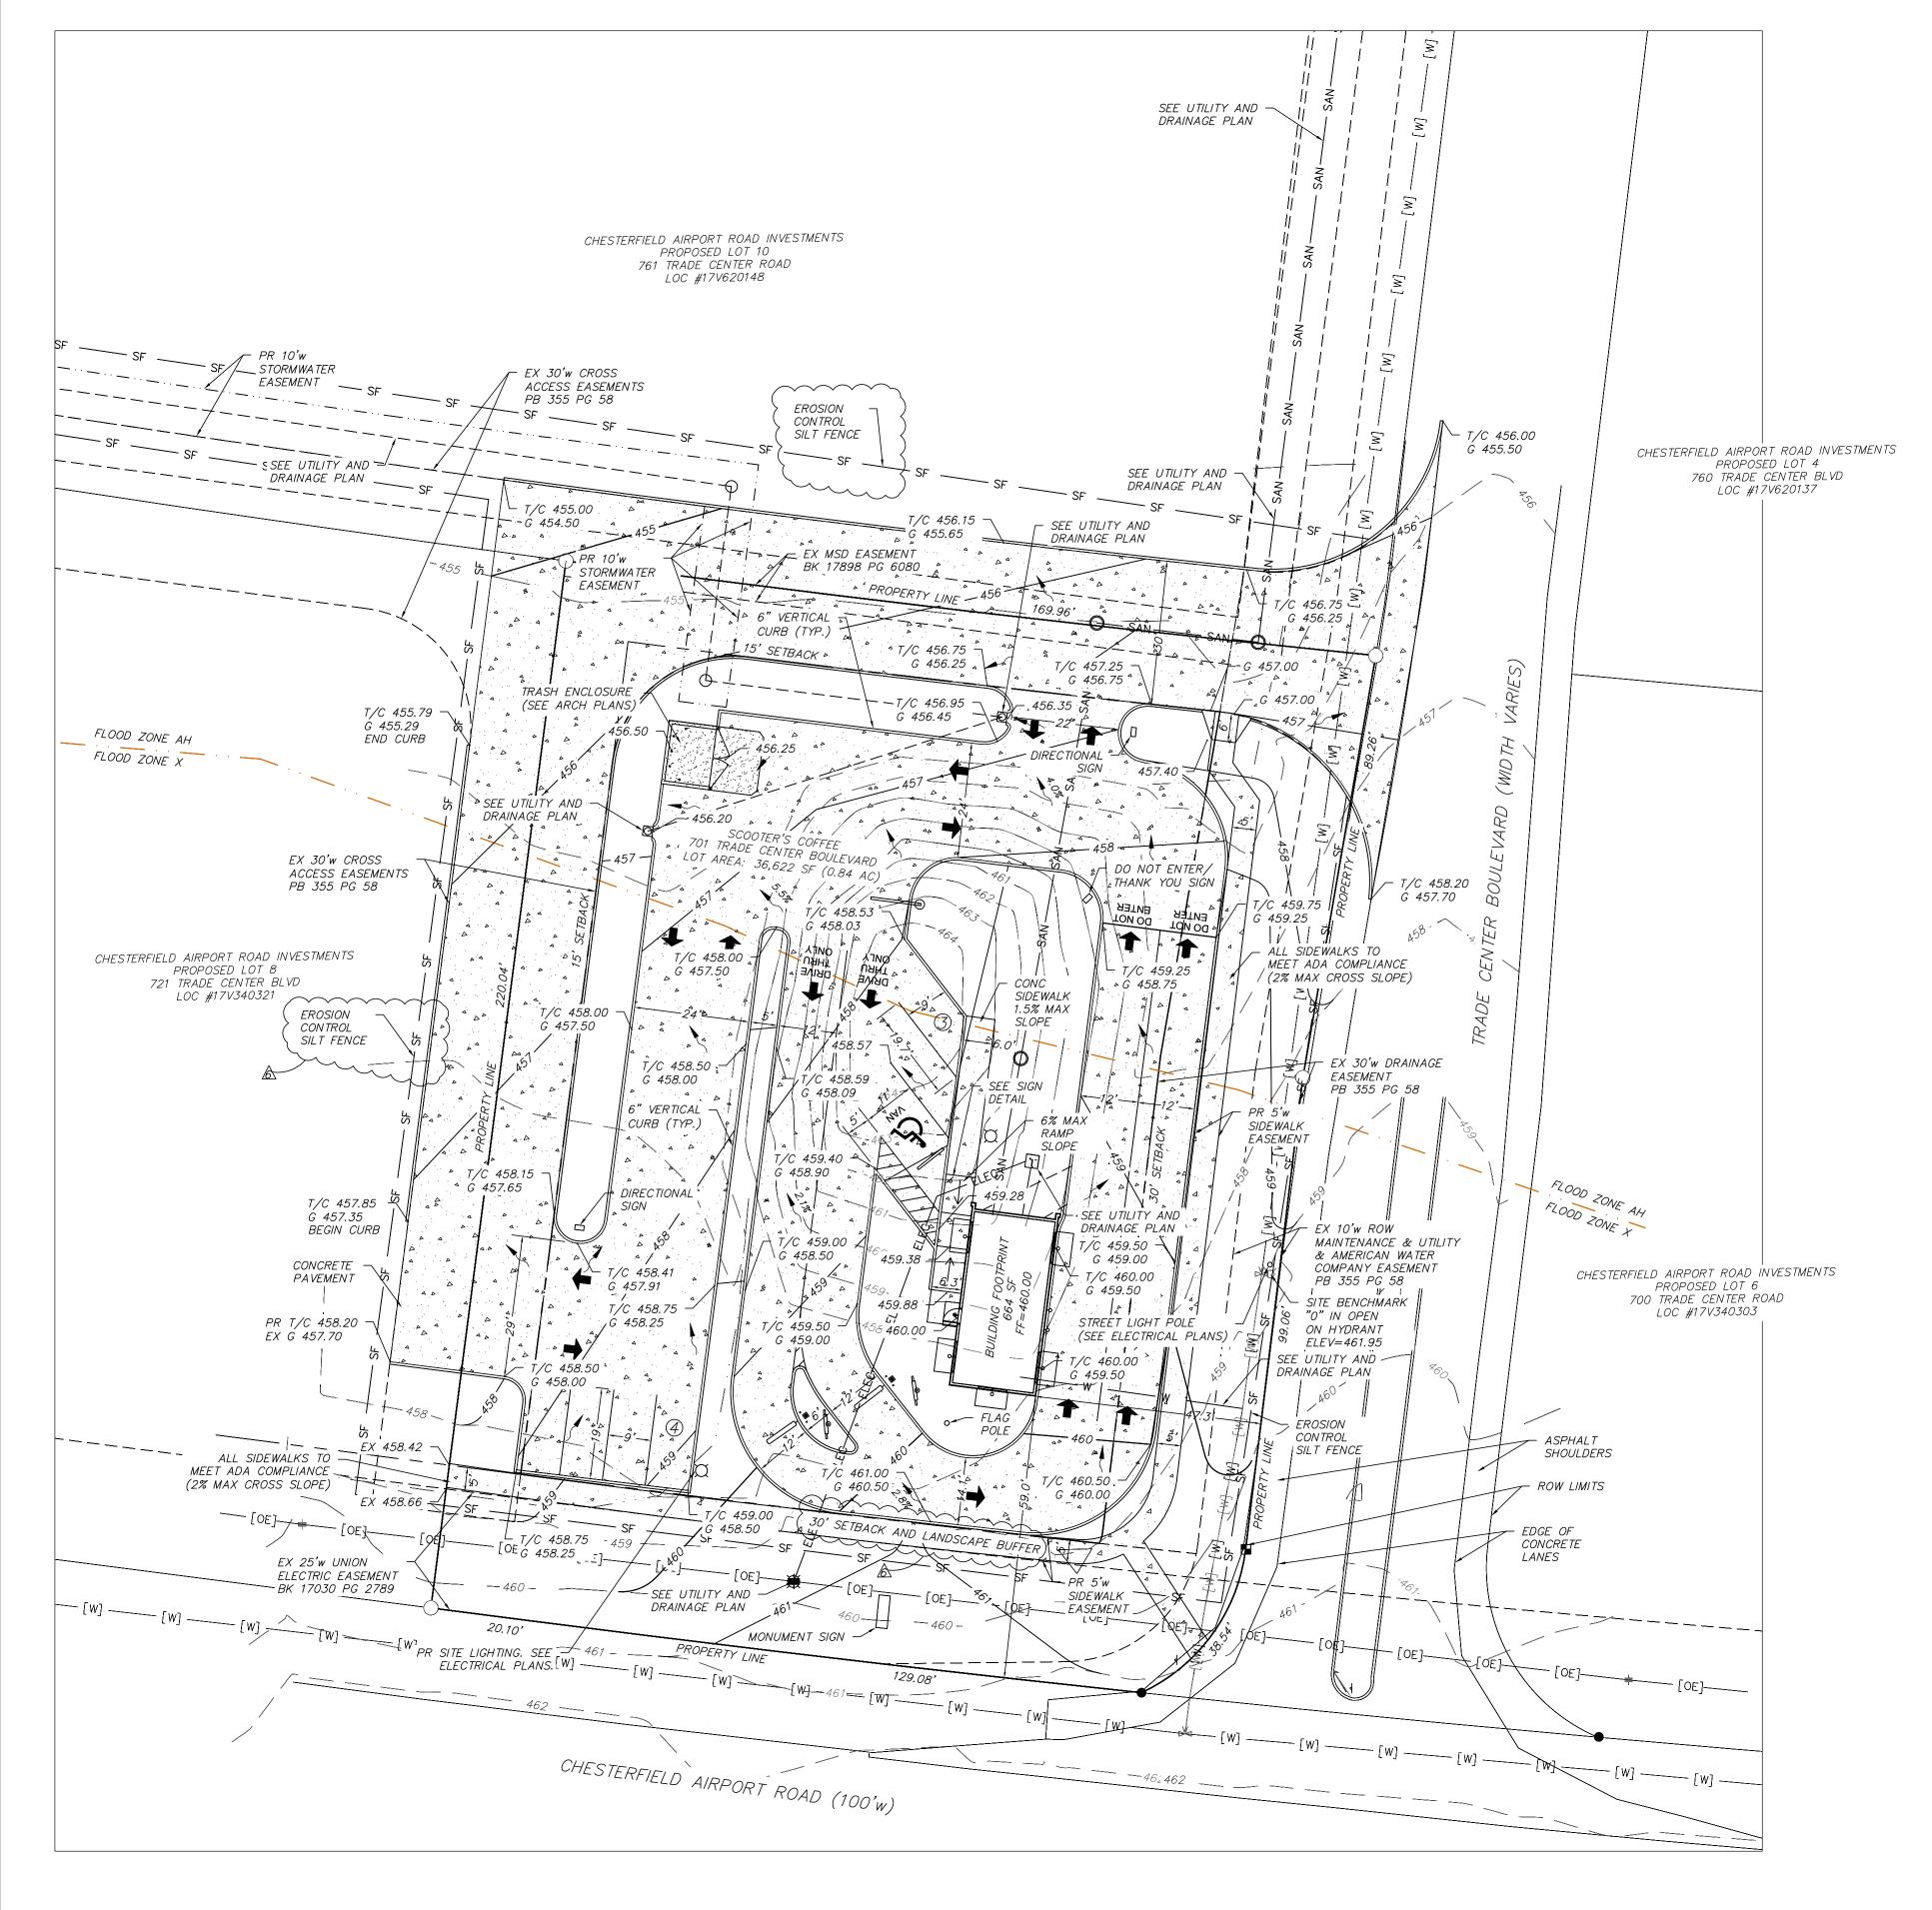

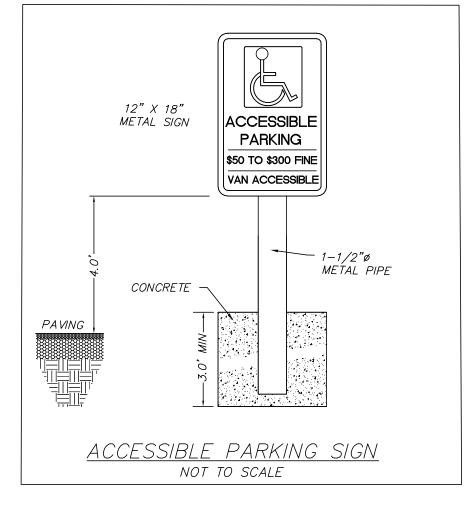

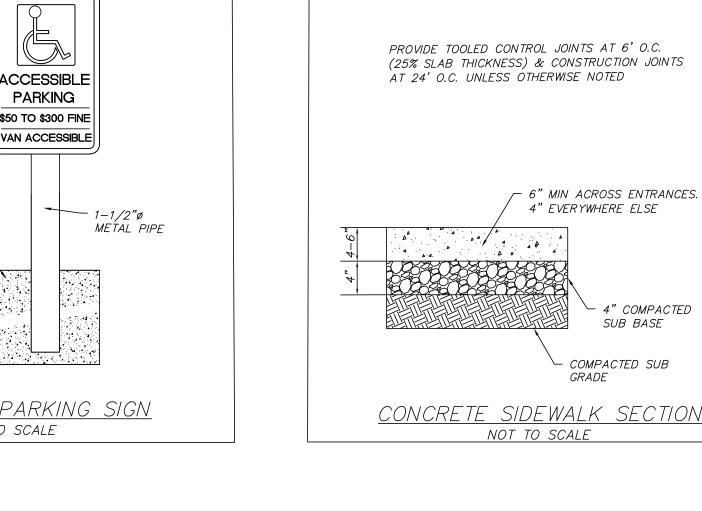

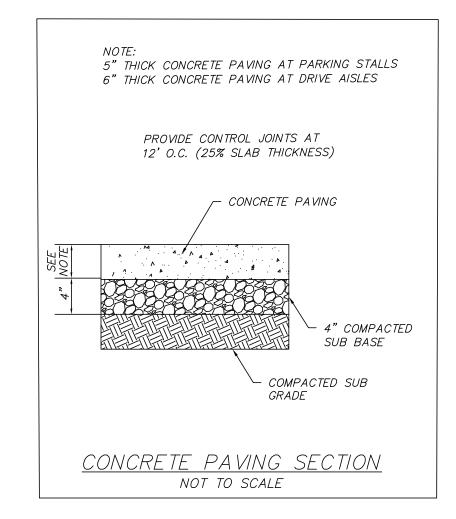

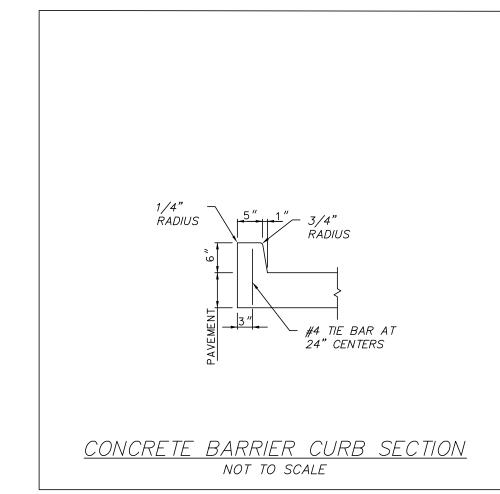



OURI 63005

SHERRILL ASSOCIATES

Planners ILLINOIS DESIGN FIRM

Surveyors - Engineers

#184-001238 MISSOURI DESIGN FIRM

#001332

316 Main Street Edwardsville, IL 62025 TEL: (618) 656-9251

DISCLAIMER OF RESPONSIBILITY I hereby specify that the documents intended to be authenticated by my seal are limited to this sheet, and I hereby disclaim any responsibility for all other Drawings, Specifications, Estimates, Reports or other Documents or instruments relating to or intended to be used for any part or parts of the engineering project or


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REVISION	12/2/21 SITE PLAN REVISIONS	1/20/22 CITY COMMENT RESPONSE	2/13/22 MSD COMMENT RESPONSE	3/14/22 CODE COMMENT RESPONSE	3/30/22 MSD COMMENT RESPONSE	4/8/22 CITY/MSD COMMENT RESPONSE	
DATE	12/2/21	1/20/22	2/13/22	3/14/22	3/30/22	4/8/22	
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PROJECT NO. DRAWN AJN SEE PLAI CHECKED WDW | 12/2/202

SHEET 2 OF 5

THIS IS TO CERTIFY THAT SHERRILL ASSOCIATES, INC. AT THE REQUEST AND FOR THE EXCLUSIVE USE OF GOOD GROUNDS PROPERTIES, LLC HAS PREPARED THIS SHEET FROM RECORD SOURCES AND ACTUAL FIELD SURVEY PERFORMED IN SEPTEMBER 2021. Wilson D. Waggoner 4/8/22



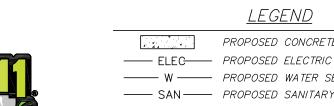

T/C

UTILITIES NOTE

Know what's **below.** 

**811** before you dig.

UNDERGROUND FACILITIES,

HAVE BEEN PLOTTED FROM

RECORDS, AND THEREFORE

CONSIDERED APPROXIMATE

ONLY. IT IS POSSIBLE

THERE MAY BE OTHERS,

THE EXISTENCE OF WHICH

IS NOT KNOWN OR SHOWN.

THEIR LOCATIONS MUST BE


AVAILABLE SURVEYS AND

STRUCTURES AND UTILITIES

PROPOSED CONCRETE PAVEMENT ---- ELEC---- PROPOSED ELECTRIC SERVICE ----- W ----- PROPOSED WATER SERVICE ---- SAN ---- PROPOSED SANITARY SERVICE — — — PROPOSED STORM DRAIN ----- SF ----- EROSION CONTROL SILT FENCE PROPOSED ELEVATION


TOP OF CURB

GUTTER LINE

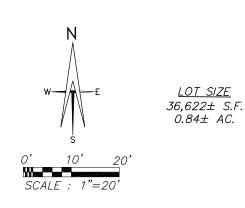



WILSON D. WAGGONER, P.E. 2013019128 IN THE STATE OF MISSOURI EXPIRES 12-31-2023

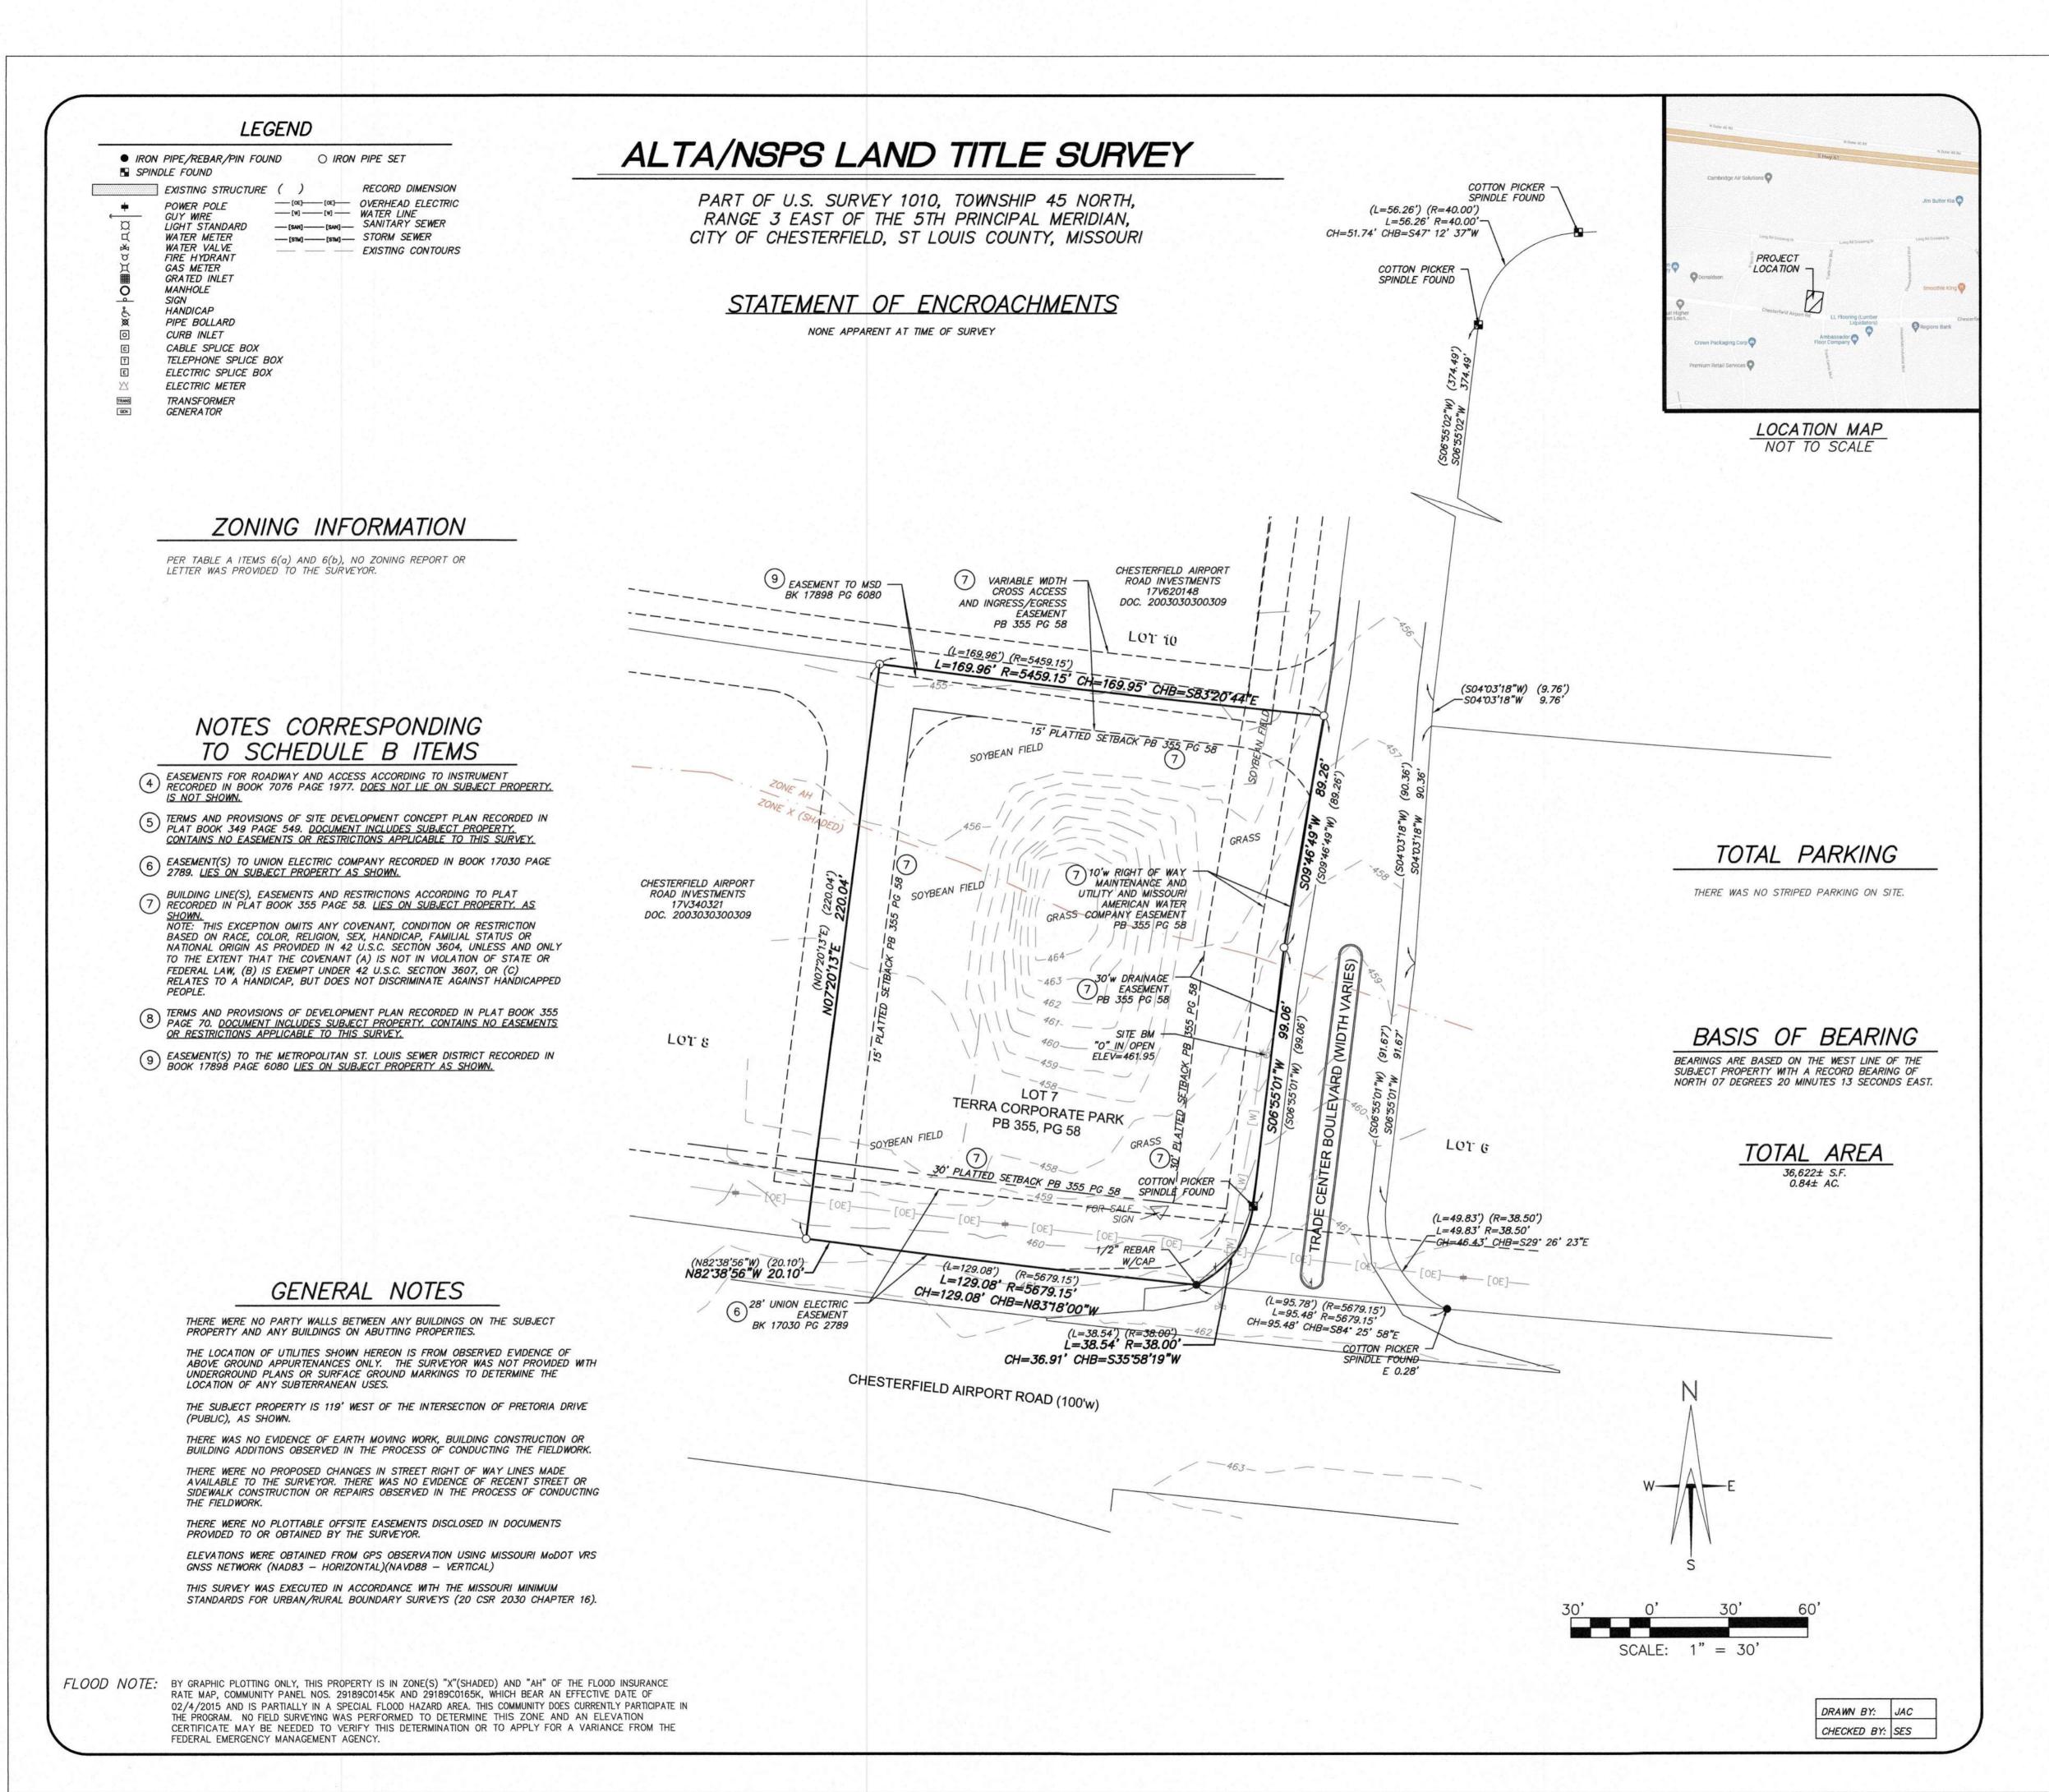

#### LEGAL DESCRIPTION

LOT 7 OF TERRA CORPORATE PARK, ACCORDING TO THE PLAT THEREOF RECORDED IN PLAT BOOK 355 PAGE

THE ABOVE DESCRIPTION AND THE SURVEY HEREON ARE THE SAME PROPERTY AS DESCRIBED IN OLD REPUBLIC NATIONAL TITLE INSURANCE COMPANY COMMITMENT NO. 2105178, DATED AUGUST 9, 2021.

### SURVEYOR'S CERTIFICATE

701 TRADE CENTER BOULEVARD CHESTERFIELD, MISSOURI 63005 BASED UPON TITLE COMMITMENT NO. 2105178 OF OLD REPUBLIC NATIONAL TITLE INSURANCE COMPANY BEARING AN EFFECTIVE DATE OF AUGUST 9, 2021

TO: GOOD GROUNDS PROPERTIES, LLC; CHESTERFIELD AIRPORT ROAD INVESTMENTS; OLD REPUBLIC NATIONAL TITLE INSURANCE COMPANY

THIS IS TO CERTIFY THAT THIS MAP OR PLAT AND THE SURVEY ON WHICH IT IS BASED WERE MADE IN ACCORDANCE WITH THE 2021 MINIMUM STANDARD DETAIL REQUIREMENTS FOR ALTA/NSPS LAND TITLE SURVEYS, JOINTLY ESTABLISHED AND ADOPTED BY ALTA AND NSPS, AND INCLUDES ITEMS 1, 2, 3, 4, 5, 6(a), 6(b), 8, 10, 11(a), 13, 14, 16, 17, AND 18 OF TABLE A THEREOF. THE FIELD WORK WAS COMPLETED ON 9-27-2021.

SHARON E. SHERRILL REGISTRATION NO. 2018038294 IN THE STATE OF MISSOURI LICENSE EXPIRATION: 12/31/2022 DATE OF PLAT: 9-30-2021 DATE OF LAST REVISION: 10-5-2021


S.A. JOB NO.: 21587-01

PLS-2018038294

21MSD-00533 BASE MAP 17V

' Y '

AKA SHEET C4.0 SHEET 1 OF

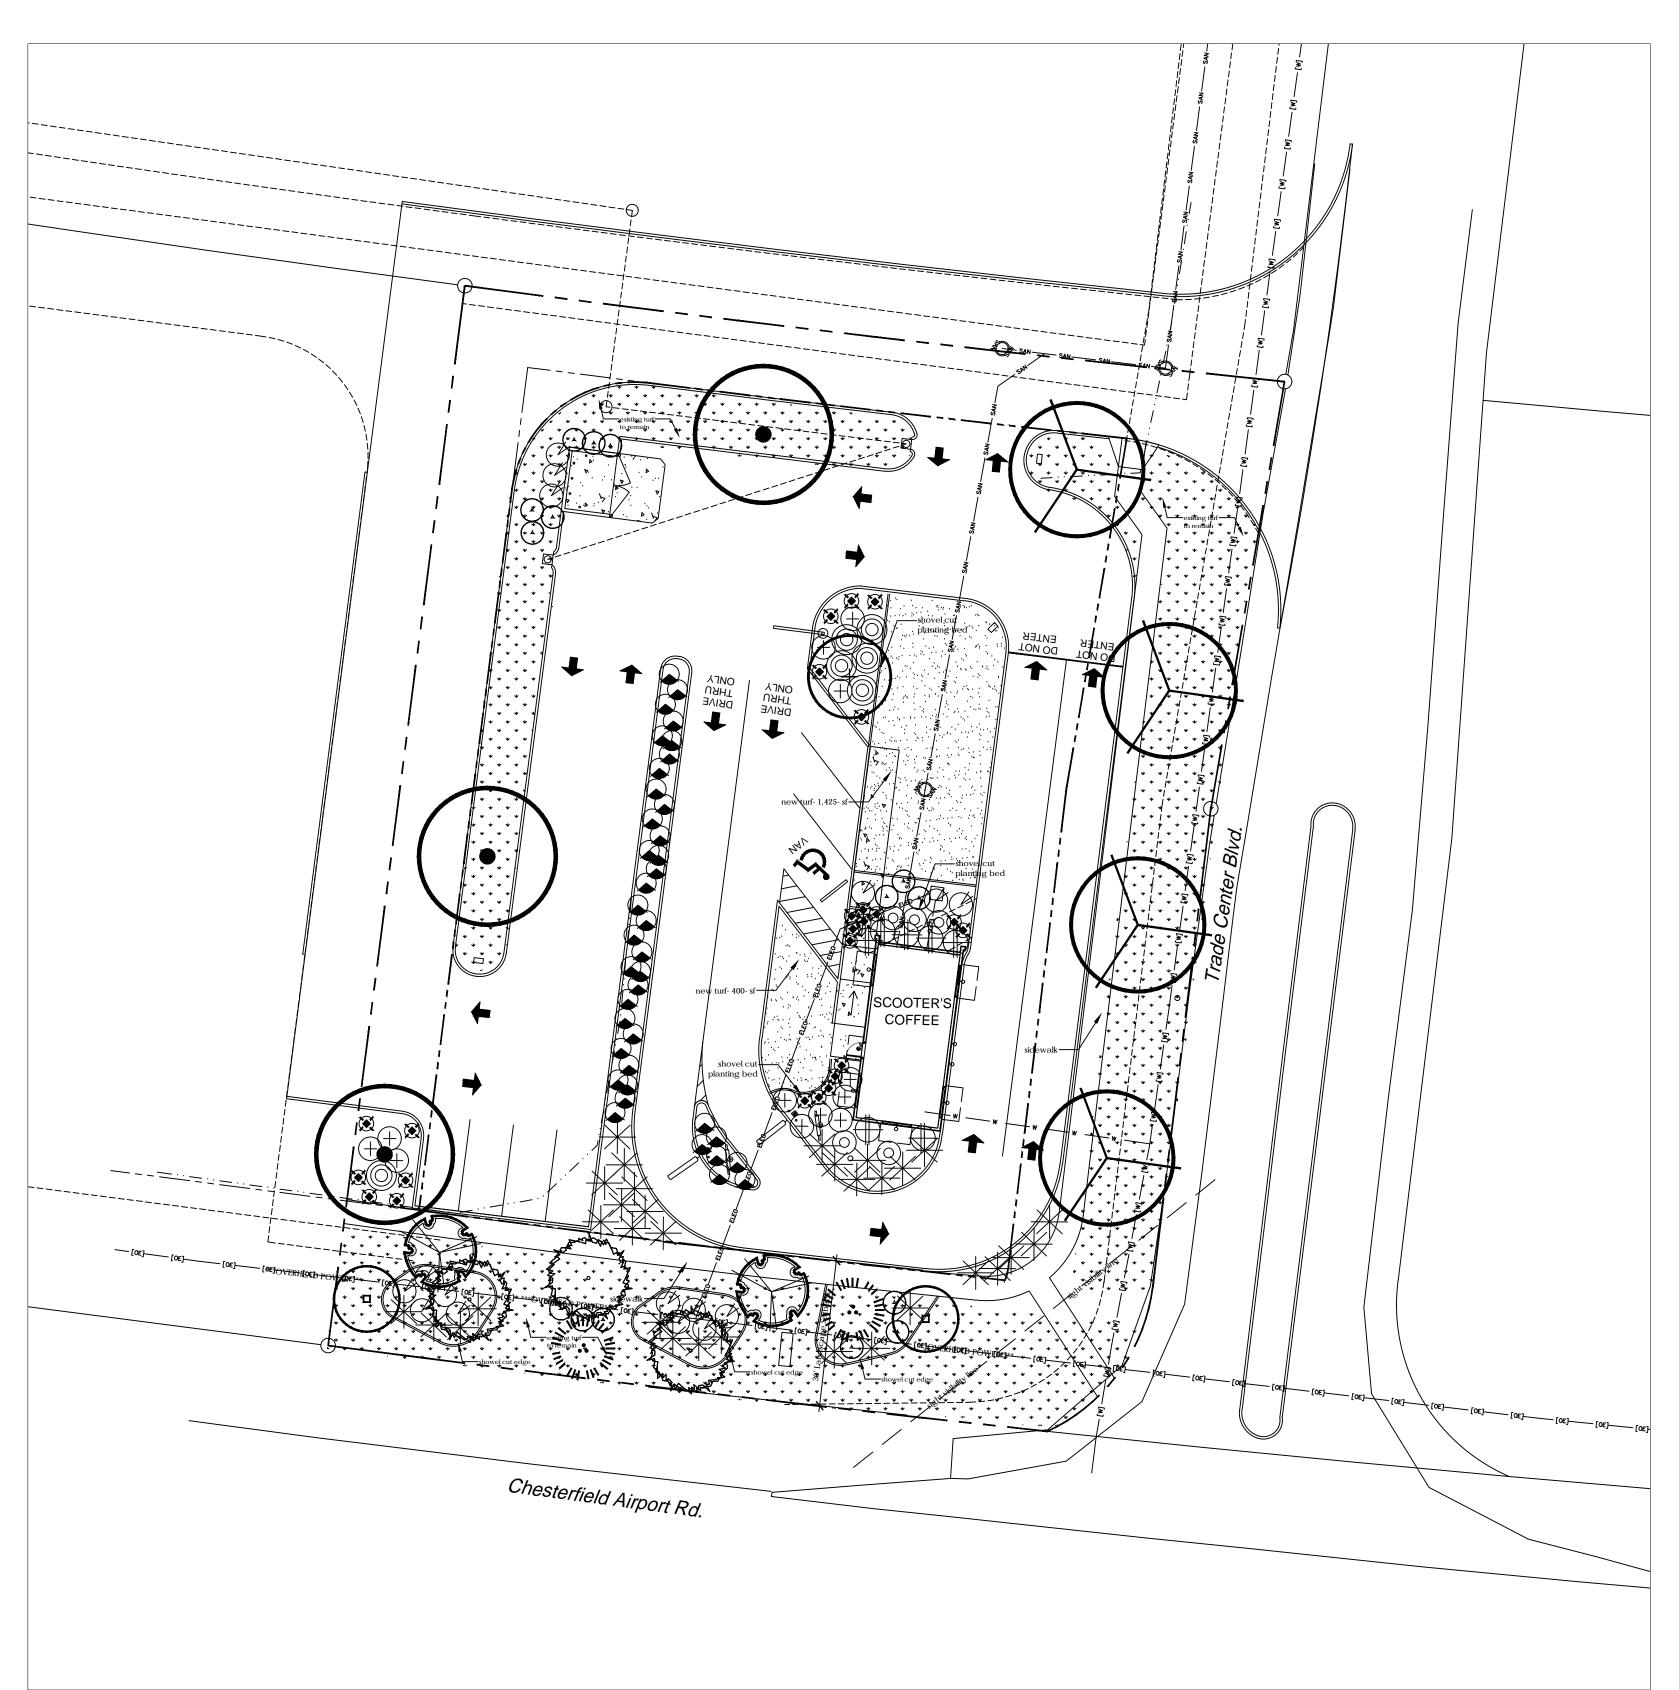

# LANDSCAPE PLAN

LIGHTLY DUST DECOMPOSED

DO NOT FORM RAISED BASIN

-DO NOT BURY TOP OF ROOTBALL

PLANTING SOIL MIXTURE (REFER TO

- PIT DEPTH: TO EQUAL ROOTBALL PIT


WIDTH: 3x DIA. OF CONTAINER

CREATE GENTLE SWALE DEPRESSION

GRANITE OVER ROOTBALL

SOIL SPECIFICATIONS)



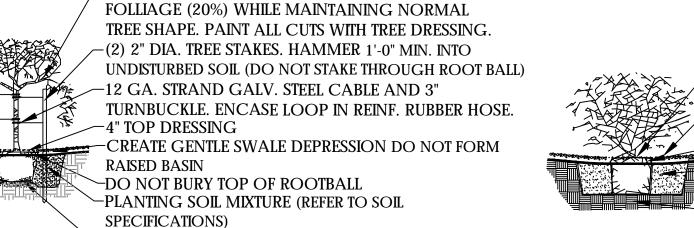


-PIT WIDTH: 3x DIA. OF CONTAINER PIT DEPTH: TO EQUAL ROOTBALL

BEFORE PLANTING. ANY ROOTBOUND PLANT SHALL BE PLANTS SHALL BE INSPECTED FOR ROOTBOUND CONDITIONS BEFORE REPLACED WITH SUITABLE PLANT. PLANTING. ANY ROOTBOUND PLANT SHALL BE REPLACED WITH SUITABLE PLANT. TREE PLANTING NO SCALE

-PRUNE BROKEN/DEAD BRANCHES AND THIN

SHRUB PLANTING NO SCALE

PLANTS SHALL BE INSPECTED FOR ROOTBOUND CONDITIONS

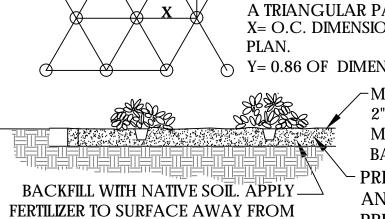

TRUNK PER SPECIFICATIONS.

1" = 20'-0"SCALE: ALL GROUNCOVERS TO BE PLANTED ON CENTER (SEE PLANT LEGEND) IN A TRIANGULAR PATTERN. X= O.C. DIMENSION AS NOTED ON Y= 0.86 OF DIMENSION "X".

MULCH SOIL TO A DEPTH OF 2", 1' IN DIAMETER. KEEP MULCH AWAY FROM PLANT

PREPARE SOIL PER SPECIFICATIONS AND ROTOTILL TO A DEPTH OF 6" PRIOR TO ANY SPRINKLER WORK.

GROUNDCOVER PLANTING NO SCALE

### PLANT PALETTE - OVERALL

<u>CANOPY</u>	NAME	QTY.	SIZE	COMMENTS
	Betula nigra	01	24" BOX	8' HT.
	RIVER BIRCH			2" CAL. MIN.
$ \checkmark $	Quercus bicolor	03	24" BOX	8' HT.
_( • /	SWAMP WHITE OAK			2" CAL. MIN.
	Acer rubrum 'October Glory'	04	36" BOX	10' HT.
()	OCTOBER GLORY RED MAPLE	01	OU DON	3" CAL. MIN.
	Comment de l'Obereles Chief	02	24" BOX	8' HT.
	Cornus florida 'Cherokee Chief' FLOWERING DOGWOOD	02	24 BOX	2" CAL. MIN.
	TEOWERING DOGWOOD			
( - )	Acer ginnala	02	24" BOX	8' HT.
motor	AMUR MAPLE			2" CAL. MIN.
	Amelanchierx grandiflora 'Robin Hill'	03	24" BOX	8' HT.
راالآكور عا	ROBIN HILL SERVICEBERRY			2" CAL. MIN.
	Juniperus chinensis	02	24" BOX	8' HT.
; •• <u>₹</u>	CHINESE JUNIPER			2" CAL. MIN
SHRUBS				
SHRUDS	NAME	QTY.	SIZE	COMMENTS
		•		
( A )	Forsythia x intermedia 'Kolgold' MAGICAL GOLD FORSYTHIA	12	5 GAL	24"-30" HT.
	Cornus alba 'Sibirica'	16	5 GAL	24"-30" HT.
	RED TWIG DOGWOOD			
$((\bigcirc))$	Clethra alnifolia 'Ruby Spice'	05	5 GAL	24"-30" HT.
	RUBY SPICE SUMMER SWEET			
	Clethra alnifolia 'Vanilla Spice'	12	5 GAL	24"-30" HT.
	VANILLA SPICE SUMMER SWEET			
	Rhamnus fragula 'Ron Williams'	06	5 GAL	24"-30" HT.
	FINE LINE BUCKTHORN			
	Ilex 'Mesog' China Girl	07	5 GAL	18"-24" HT.
	CHINA GIRL HOLLY			
A C C ED III	9			
ACCENT	NAME	OTV	CEZE	COMMENTS
	NAME	QTY.	SIZE	COMMENTS
$\langle \downarrow \rangle$	Calamagrostis x acutiflora 'Karl Foerster'	32	3 GAL	18" HT.
	KARL FOERSTER PINK FEATHER REED GRASS			
GROUNI	OCOVERS			
	NAME	QTY.	SIZE	COMMENTS
	Euonymus fortunei 'Variegata'	39	1 GAL	
	WINTERCREEPER EUONYMUS	33	IGAL	
	Liriope muscari 'Big Blue'	24	1 GAL	
	BIG BLUE LIRIOPE			
SURFACE	E MATERIALS			
JUM ACI	DESCRIPTION	QUA	NTITY	
		•		
3.55	Cynodon dactylon	1,82	5 S.F.	
[6] **********	- 5			

### LANDSCAPE MATERIALS

Shredded hardwood mulch- 3" in all

# LANDSCAPE NOTES

-All finished grades to be approved by the landscape architect prior to the installation of any plant

-Plant material to be approved by the landscape architect prior to installation.

-All tree locations to be staked by the landscape contractor and approved by the landscape architect prior to any holes being dug.

-The contractor is to provide a 2 lb sample of the proposed decomposed granite for review and approval by the landscape architect and owner. The contractor shall provide 100% coverage of non-paved areas within the limits of construction.

-For all tree planting that encounters hardpan/caliche provide separate unit price to install trees

with an auger.

-It is the responsibility of the landscape contractor to inform the landscape architect of any plant material concerns based on the planting season (e.g. summer vs winter). Should the landscape contractor have any concerns about plant material due to heat or frost exposure, the installer shall request a substitution or delay in planting. Once planted, all plant material is subject to specified

-All palm and deciduous trees to be unconditionally guaranteed for one year after installation. All other plants shall be guaranteed for a minimum period of 90 days from the date of final approval by the city/owner. Any plant materials not approved by city/owner prior to October 1 of the calendar year in which they are installed shall be further guaranteed until may 20th of the following

-Trees, shrubs, vines, groundcovers and turf which have to be replaced under the terms of the guarantee shall be guaranteed for an additional 90 days from the date of replacement. -The landscape contractor shall be responsible for providing all finished grades and for maintaining positive drainage away from all buildings during the finish grading process. All slopes not to exceed 4:1 in landscape areas.

-The landscape contractor shall verify berm and retention basin locations shown on these plans with those on the civil engineering plans. Should a discrepancy exist between the plans, Studio Sprawl should be notified immediately.

-Under no circumstance shall any tree be planted within 6' of any building without the express written approval of the landscape architect.

-Trees and shrubs shall be placed a minimum of 6' from public accessways, utility cabinets and fire -Shrubs must be at maturity, 6' from the rear of a fire hydrant. No material other than groundcovers

may be placed between a fire hydrant and the street or roadway or 6' on either side. Field verify all hydrant location with the civil engineering plans.

-All site improvements, including landscape and site clean up must be completed prior to final approval or certificate of occupancy.

-Trees adjacent to pedestrian walkways should have minimum canopy clearance of 6'8". -No plant material with mature growth greater than three (3) feet in height shall be planted within potable water, sanitary sewer, or non-potable irrigation easements. [Volume III, Section 2.05(A)] -No shrubs shall be planted within five (5) feet or trees within ten (10) feet of potable and non-potable water meters, fire hydrants, sanitary sewer manholes, or potable water, sanitary water, and non-potable irrigation mains and services. [Volume III, Section 2.05(B)] -Automatic irrigation system shall be equipped with an automatic rain detection device. [Chapter









701 TRADE CENTER BLVD. CHESTERFIELD, MO 63005

**REVISIONS:** 

CITY COMMENTS 3.07.22

LANDSCAPE PLAN

DATE: 04.08.2022


PROJECT NO. 21-378

DESIGN DEVELOPMENT X PERMIT SUBMITTAL

☐ CONSTRUCTION ISSUE

☐ BID PACKAGE

SHEET NO.

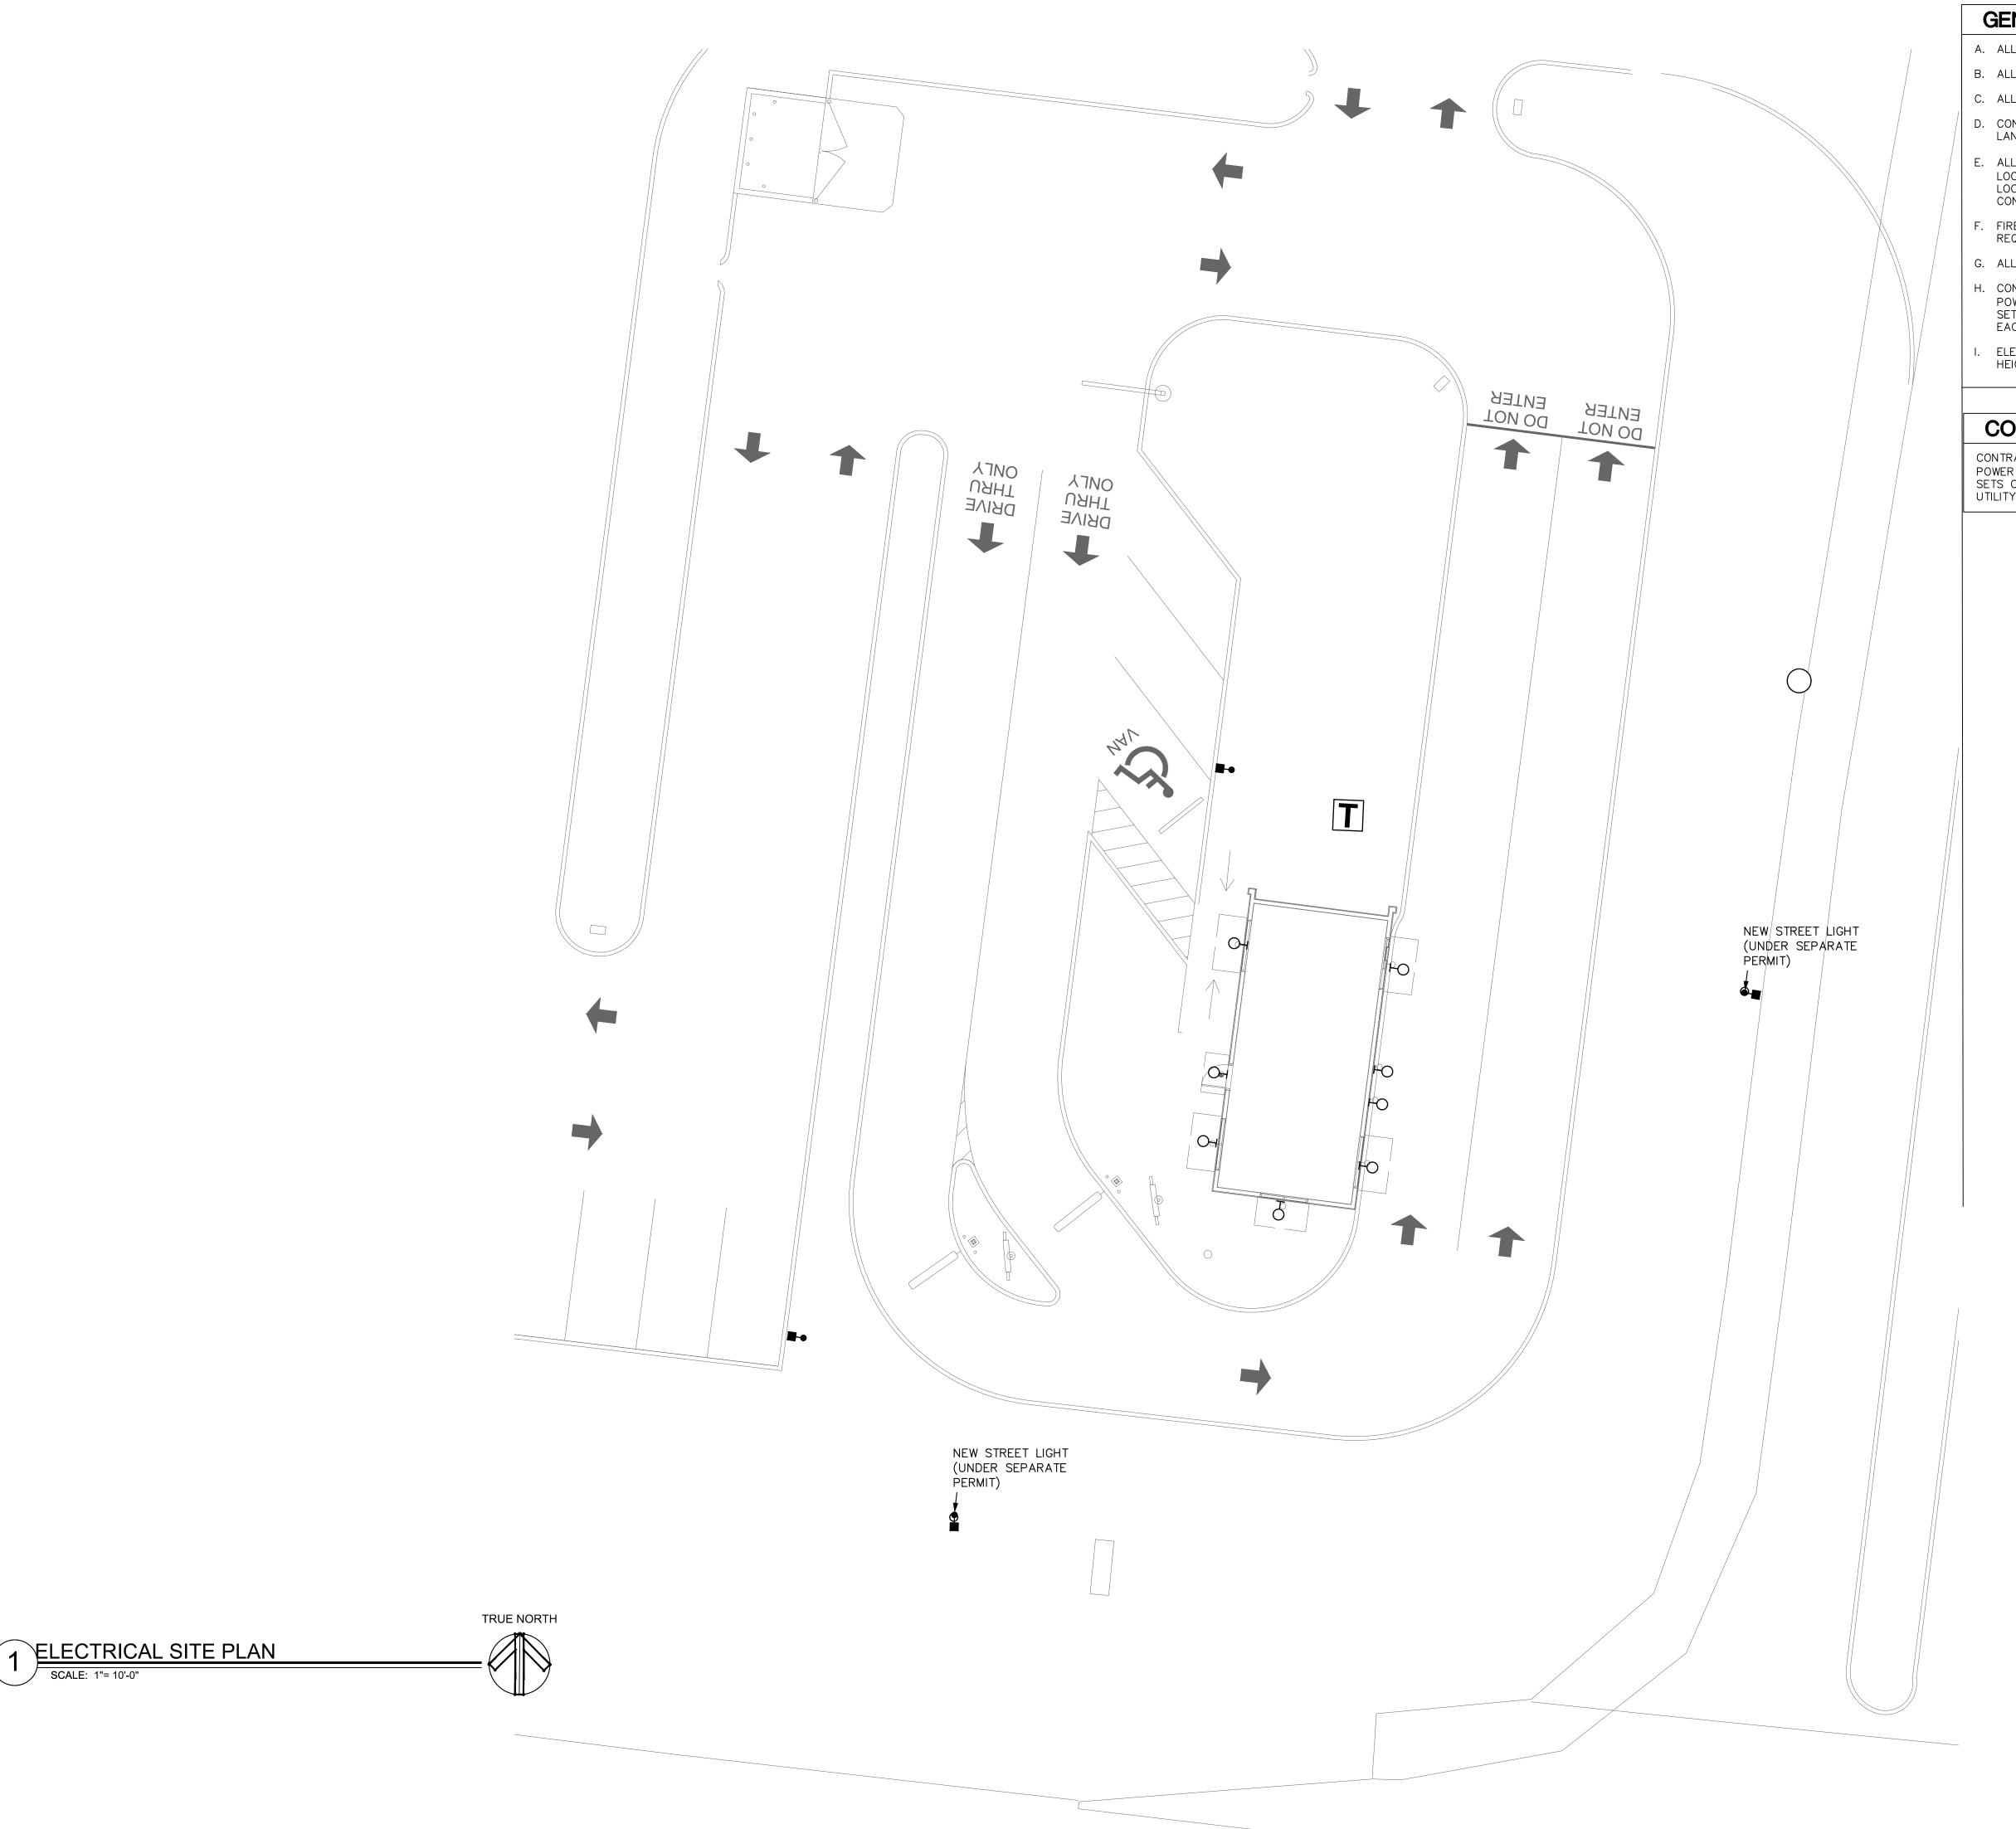

### GENERAL NOTES

- A. ALL EXTERIOR LIGHT FIXTURES TO COMPLY WITH LOCAL NIGHT SKY ORDINANCE.
- B. ALL EXTERIOR LIGHTING AND SIGNAGE TO BE FED WITH #10 CU. U.N.O.
- C. ALL EXTERIOR ELECTRICAL EQUIPMENT TO BE NEMA-3R RATED.
- D. CONTRACTOR TO COORDINATE EXACT SITE LIGHTING FIXTURE LOCATIONS WITH LANDSCAPE DRAWINGS.
- E. ALL FIXTURES INSTALLED OUTDOORS SHALL BE RATED FOR DAMP/WET LOCATIONS AS REQUIRED. THE CONTRACTOR SHALL COORDINATE DAMP/WET LOCATION RATING PER NEC ARTICLE 410-4. ALL INSTALLATIONS SHALL CONFORM TO NEC ARTICLE 410, ALL SUB ARTICLES.
- F. FIRE ALARM EQUIPMENT SHALL BE COORDINATED FOR EXACT LOCATION AND REQUIREMENTS WITH FIRE MARSHALL.
- G. ALL PVC CONDUIT MUST HAVE A MINIMUM OF #10 CU. GROUND CONDUCTOR.
- H. CONTRACTOR SHALL BE RESPONSIBLE FOR COORDINATION AND SCHEDULING WITH POWER AND TELEPHONE UTILITY COMPANIES INCLUDING PROVIDING (2) COMPLETE SETS OF DRAWINGS TO EACH COMPANY. ALL WORK SHALL BE INSTALLED PER EACH UTILITY COMPANIES FINAL DESIGN DRAWINGS.
- I. ELECTRICAL CONTRACTOR SHALL COORDINATE EXACT LOCATIONS AND MOUNTING HEIGHTS OF ALL EXTERIOR LIGHT FIXTURES WITH ARCHITECTURAL DRAWINGS.

### CONTRACTOR NOTE

CONTRACTOR SHALL BE RESPONSIBLE FOR COORDINATION AND SCHEDULING WITH POWER AND TELEPHONE UTILITY COMPANIES INCLUDING PROVIDING (2) COMPLETE SETS OF DRAWINGS TO EACH COMPANY. ALL WORK SHALL BE INSTALLED PER EACH UTILITY COMPANIES FINAL DESIGN DRAWINGS.



15974 N. 77th ST., STE 100 SCOTTSDALE AZ 85260





PROJECT ADDRESS: 701 TRADE CENTER BLVD. CHESTERFIELD, MO 63005

REVISIONS:

1 CITY COMMENT 01.19.22 2 CITY COMMENT 03.07.22

TITLE:

ELECTRICAL SITE PLAN

DATE: 11.22.2021 PROJECT NO.

21-378

Electrical Engineer
OMID ARDEBILI P.E.

7328 E Stetson Dr., Scottsdale, AZ 85251
T 480-626-7072 E:omid@ardebilieng.com
Proj. Mgr: BH
Proj. No: 21672

SHEET NO.

E0.0

Accent / Back-lighting

The Pro Series offers energy efficient, economical LED lighting for indoor and outdoor applications.

 Indoor / Outdoor · Commercial / Residential





B



NOVA\*FLEX\*

Power Max

(w/ft) Run

1.5 48.8 ft

**Specifications** 

WDGE LED Family Overview

Depth (D1):

Depth (D2):

Weight: (without options)

nysical				CCT	CRI	Lumens/ft	Efficacy (lm/w)	
perating Temp	-15° to 140°F (-25° to 60°C)			2700K	81	94	63	
invironment	IP65 Standard (Dust/splash proof) IP68 Rugged* (Water/chemical resistant)			3000K	81	115	77	
/lounting	3M Adhesive   Clips   Channels	09 0		3225K	83	103	67	=
Cut Length	See page 2	PRO		4100K	84	101	67	
out Length	See page 2			5500K*	82	92	61	
erformance				6200K	85	87	58	-
umen Maintenance	50,000 Hrs			2700K	80	214	71	
Varranty	2 years			3000K	81	210	70	3
CCT Binning	<3SDCM	120		3225K	83	197	66	
Certifications	UL Closet Rated (Pro 60 / 120)	PRO		4100K	83	212	71	
	Closet Nated (F10 00 / 120)			5500K*	82	208	69	
ectrical				6200K	83	172	57	
/oltage	24V			2700K	81	384	65	
Vire Size	20 AWG. 2 Wire	_		3000K	81	368	62	
Dimming	MLV   0-10V   S3i Series Controller	240		3225K	84	417	71	3
		PRO		4100K	83	421	71	3
omplete Solution				5500K*	83	407	69	
Step 1 Build your r	ibbon order code			6200K	80	381	65	3
Step 2 Select your	channel (pg 3-4)	Lur	nens	have a tol	erance	of +/- 10%.		

*Special order, allow 4 - 6 weeks delivery.	IES	LM79   TM30	INSTALL GUIDI
Designed & Assembled in Minnesota.	Specifications are subject to change without notice.	800.595.630	2 novaflexled.com

### **CHANNEL OPTIONS PRO SERIES**

Create a fixture, diffuse light, or add another level of protection with our aluminum channel options. All orders come with mounting clips, end caps, and choice of lens. A variety of color channel is available as special order. Lens Type defaults to soft lens, unless specified

CL) Clear (0% - 5%) SF) Soft (20% -30%) SL) Solid\* (50+%)

\*Solid Lens, allow 4 - 6 weeks delivery.

Designed & Assembled in Minnesota.

Step 3 Select your power and controls (pg 5-6)

Step 5 Contact your local agent or Nova Flex Rep.

Step 4 Select your accessories (pg 7)


roduct Image	Product Code	Compatible with	Lens Options	Dimensions	Downloads
	Surface 1707 NF-CH-1707-2M	IP65: 60, 120	CL SF	0.69" Height with Lens 0.3"	SPEC SHEET
	Surface 1707 - 30° NF-CH-1707-C/CLEAR/30-2M	IP65: 60, 120	(CL)	0.69"	SPEC SHEET
	Surface 1707 - 60° NF-CH-1707-C/CLEAR/60-2M	IP65: 60, 120	(CL)	0.48"	SPEC SHEET
	Surface 1813 NF-CH-1813-2M	IP65: 60, 120, 240 IP68: 60, 120	CL SF	0.59" LS VO	SPEC SHEET
	Surface 1919 NF-CH-1919-2M	IP65: 60, 120	CL SF	4	SPEC SHEET
	Surface 2216 NF-CH-2216-2M	IP65: 60, 120, 240 IP68: 60, 120	CL SF	0.71" 5 6 6 6 6 6 6 6 6 6 6 6 6 6 6 6 6 6 6	SPEC SHEET
	Surface 3030 - CR NF-CH-3030-C/CLEAR/CR-2M NF-CH-3030-C/SOFT/CR-2M	IP65: 60, 120, 240 IP68: 60, 120, 240	CL SF	1.19"	SPEC SHEET
	Surface 3030 - SQ NF-CH-3030-C/CLEAR/SQ-2M NF-CH-3030-C/S0FT/SQ-2M	IP65: 60, 120, 240 IP68: 60, 120, 240	CL SF	1.19"	SPEC SHEET
	<b>Surface 3525</b> NF-CH-3525-2M	IP65: 60, 120, 240 IP68: 60, 120, 240	CL SF	1.38"	SPEC SHEET
	<b>Surface 4517</b> NF-CH-4517-2M	IP65: 60, 120, 240 IP68: 60, 120, 240	CL SF	1.67° 1.77° Height with Lens 0.70"	SPEC SHEET

Specifications are subject to change without notice.

800.595.6302 novaflexled.com | 03


LITHONIA LIGHTING.

COMMERCIAL OUTDOOR

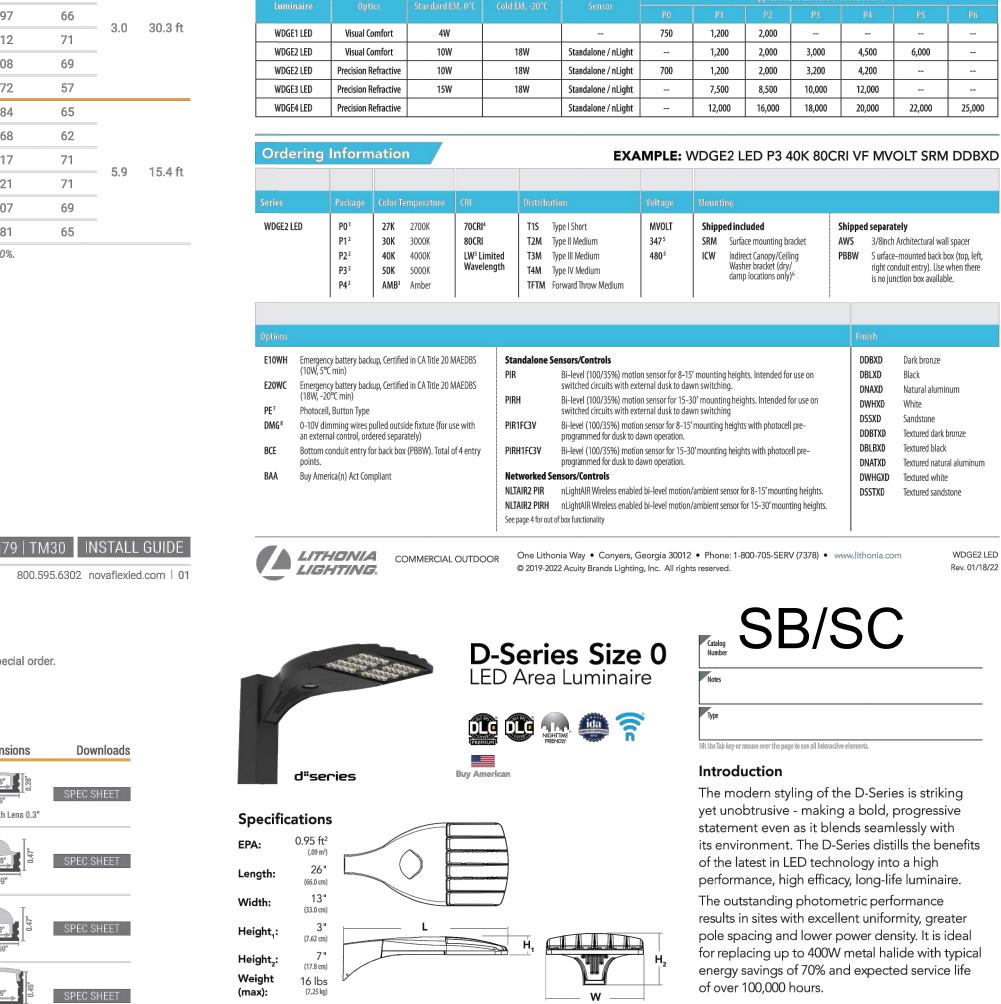


**WDGE2 LED** 

Architectural Wall Sconce Precision Refractive Optic

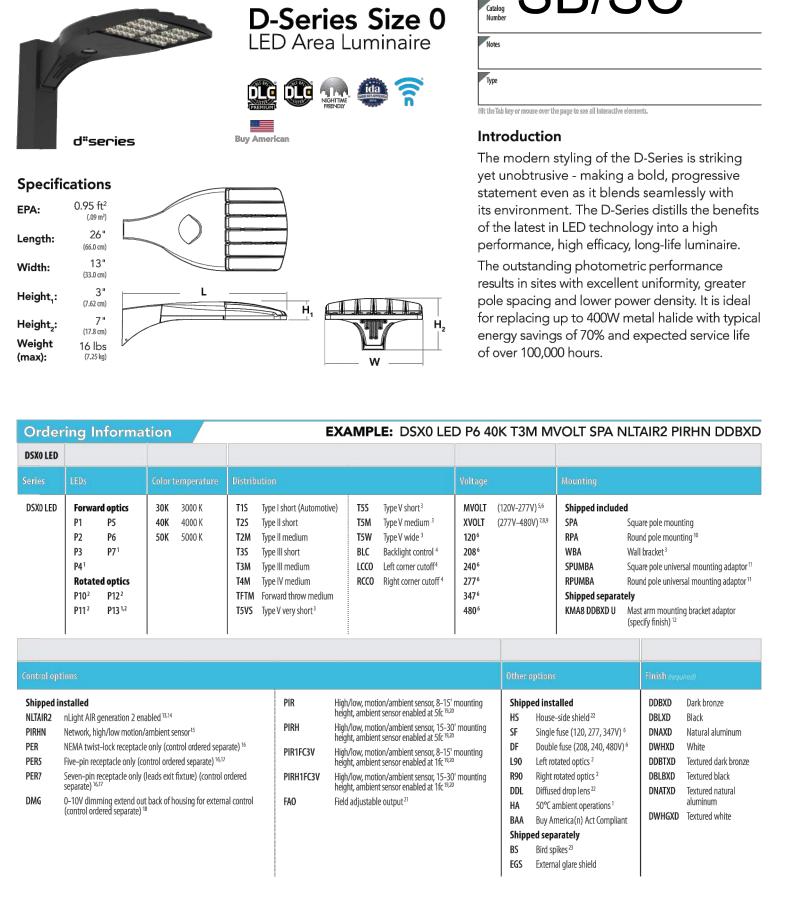

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**▶ COM***check* Software Version 4.1.5.3

2015 IECC

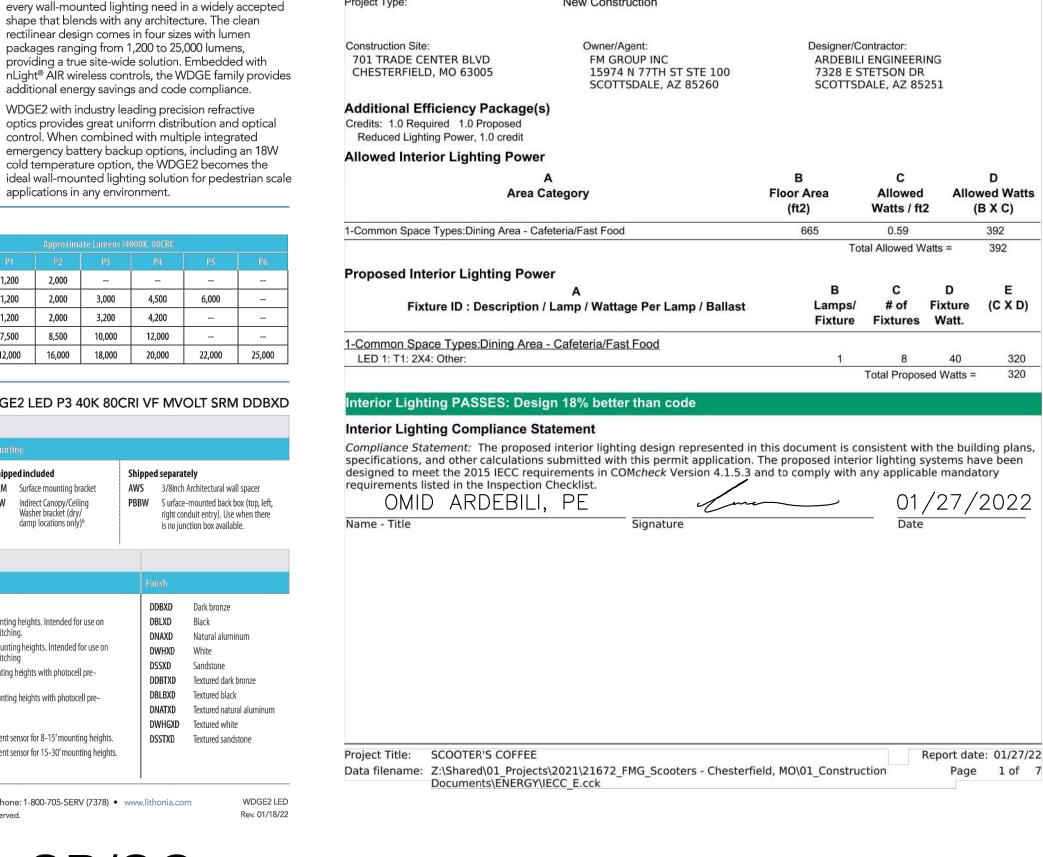SCOOTER'S COFFEE

**New Construction** 

Project Information

Energy Code:

Project Title:

Project Type:

t the Tab key or mouse over the page to see all interactive elements.

The WDGE LED family is designed to meet specifier's

DDBXD Dark bronze

DBLXD Black

DWHXD White

DSSXD Sandstone

DBLBXD Textured black

DWHGXD Textured white

Introduction

applications in any environment.

**Interior Lighting Compliance Certificate** 



specifications, and other calculations submitted with this permit application. The proposed exterior lighting systems have been

designed to meet the 2015 IECC requirements in COMcheck Version 4.1.5.3 and to comply with any applicable mandatory

Signature

requirements listed in the Inspection Checklist.

Name - Title

DSX0-LED Rev. 07/19/21 Page 1 of 8

OMID ARDEBILI, PE



| Electrical Engineer OMID ARDEBILI P.E. 7328 E Stetson Dr., Scottsdale, AZ 85251


Proj. Mgr:<u>BH</u>

T 480-626-7072 E:omid@ardebilieng.com

Proj. No: <u>21672</u>

01/27/2022

WENTY FIVE YEAR 15974 N. 77th ST., STE 100 SCOTTSDALE AZ 85260

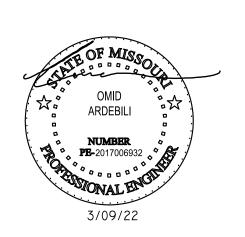



PROJECT ADDRESS: 701 TRADE CENTER BLVD. CHESTERFIELD, MO 63005

**REVISIONS:** 

1 CITY COMMENT 01.19.22 2 CITY COMMENT 03.07.22


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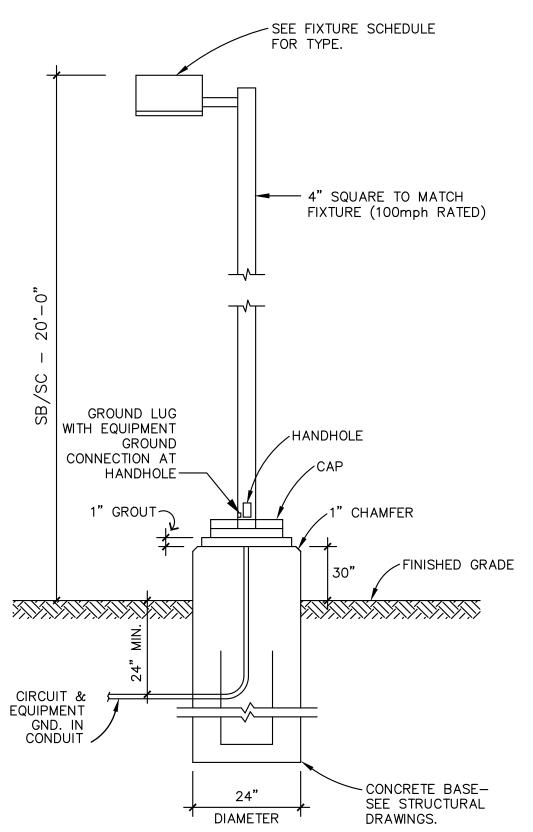
**EXTERIOR** LIGHTING **CUTSHEETS & COMCHECKS** 

DATE: 11.22.2021

PROJECT NO. 21-378

SHEET NO.



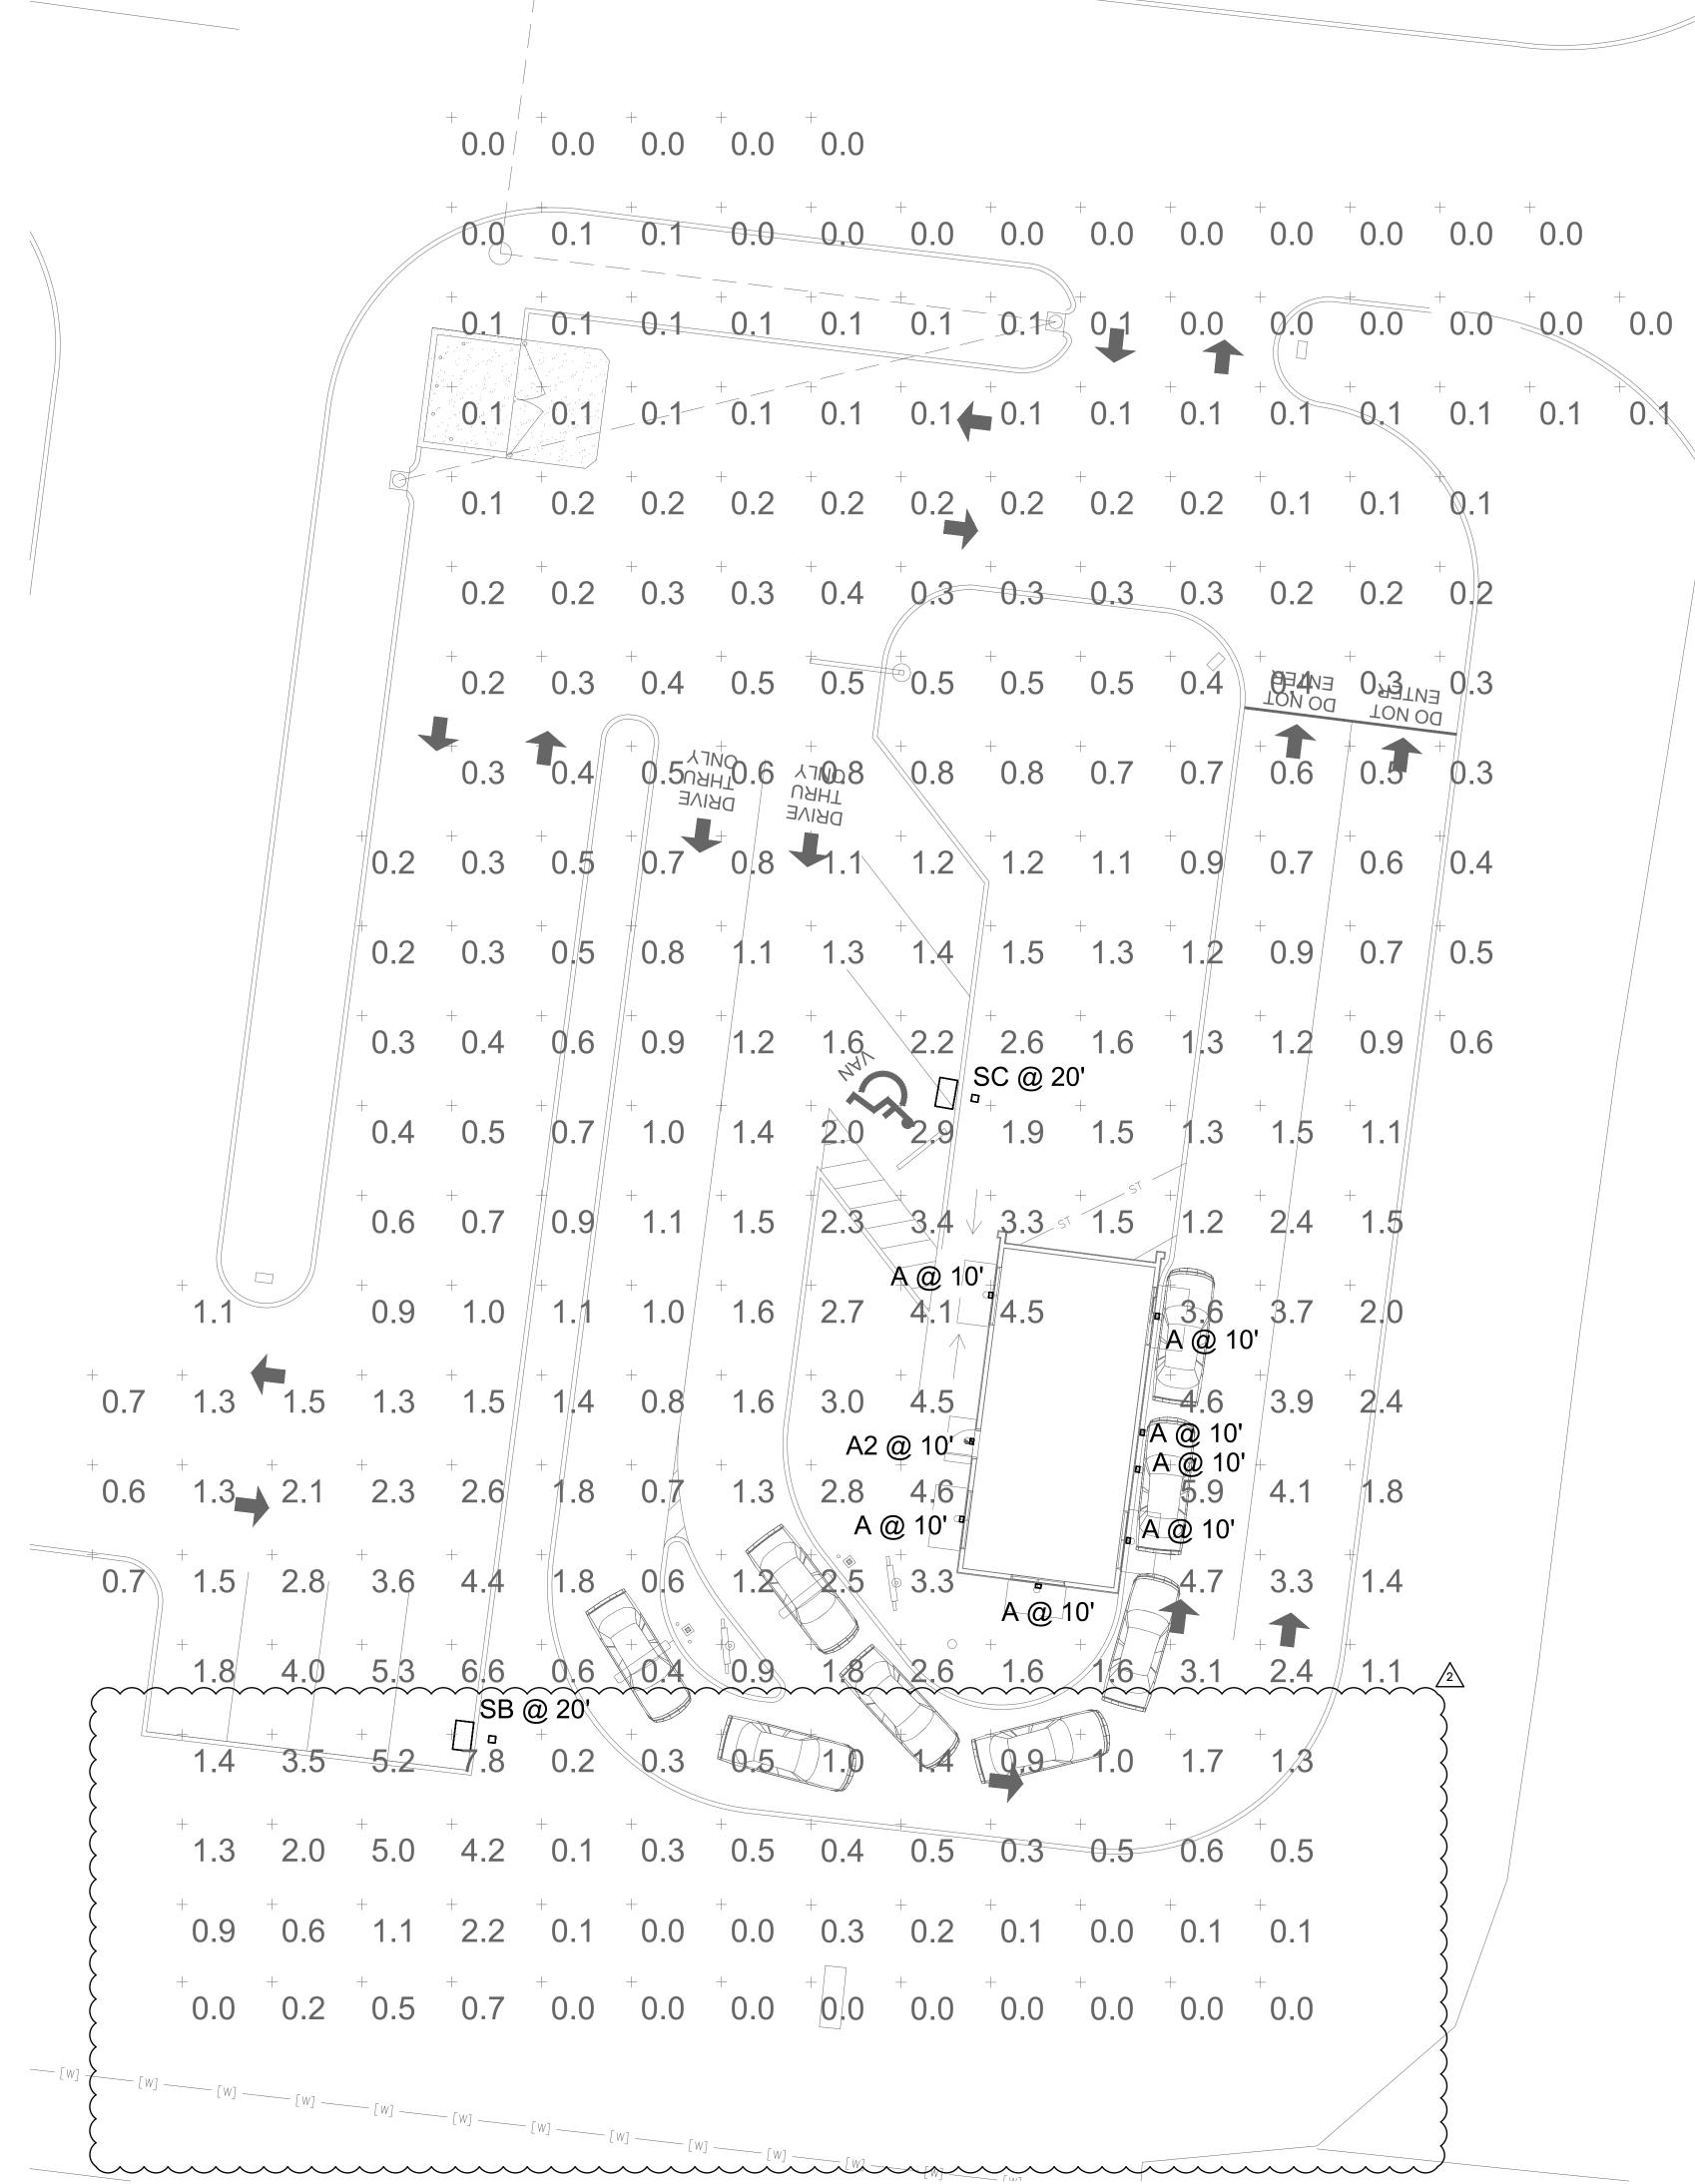

## LIGHT POLE 'SB/SC'



15974 N. 77th ST., STE 100

SCOTTSDALE AZ 85260

701 TRADE CENTER BLVD. CHESTERFIELD, MO 63005

**REVISIONS:** 

CITY COMMENT 01.19.22 2 CITY COMMENT 03.07.22

TITLE:

**PHOTOMETRIC** SITE PLAN

Statistics										
escription	Symbol	Avg	Max	Min	Max/Min	Avg/Min				
ITE - FC @ GRADE	+	1.1 fc	7.8 fc	0.0 fc	N/A	N/A				

Schedule				_						
Symbol	Label	Quantity	Manufacturer	Catalog Number	Description	Lamp	Filename	Lumens Per Lamp	Light Loss Factor	Wattage
	А	7	Lithonia Lighting	WDGE2 LED P2 30K 80CRI T4M MVOLT (FINISH)	WDGE2 LED WITH P2 - PERFORMANCE PACKAGE, 3000K, 80CRI, TYPE 4 MEDIUM OPTIC	LED - 3000K	WDGE2_LED_P2 _30K_80CRI_T4 M.ies	1922	0.91	18.9815
	A2	1	Lithonia Lighting	WDGE2 LED P2 30K 80CRI T4M MVOLT E20WC (FINISH)	WDGE2 LED WITH P2 - PERFORMANCE PACKAGE, 3000K, 80CRI, TYPE 4 MEDIUM OPTIC W/EM BATTERY PACK	LED - 3000K	WDGE2_LED_P2 _30K_80CRI_T4 M.ies	1922	0.91	18.9815
	SB	1	Lithonia Lighting	DSX0 LED P6 30K LCCO MVOLT SPA (FINISH) / SSS 17.5' W/2.5' BASE	DSX0 LED P6 30K LCCO MVOLT	LED - 3000K	DSX0_LED_P6_3 0K_LCCO_MVOL T.ies	9041	0.91	134
	SC	1	Lithonia Lighting	DSX0 LED P6 30K T5W MVOLT SPA (FINISH) / SSS 17.5' W/2.5' BASE	DSX0 LED P6 30K T5W MVOLT	LED - 3000K	DSX0_LED_P6_3 0K_T5W_MVOLT .ies	15285	0.91	134





SHEET

TRUE NORTH

Electrical Engineer OMID ARDEBILI P.E. 7328 E Stetson Dr., Scottsdale, AZ 85251 T 480-626-7072 E:omid@ardebilieng.com Proj. Mgr: <u>BH</u> Proj. No: <u>21672</u>

DATE: 11.22.2021 PROJECT NO. 21-378

SHEET NO.

**E0.2** 

**EXTERIOR ELEVATIONS-WEST** 

SCALE: 3/8" = 1'-0"

ELEV, 18-3 A

T.O. PARAPET

T.

1 EXTERIOR ELEVATIONS - NORTH

SCALE: 3/8" = 1'-0"

### **KEYNOTES**

(

- ENDICOTT THIN BRICK VENEER, RUNNING BOND COLOR: MANGANESE BROWN, SMOOTH FINISH
- HARDIE REVEAL PANEL SYSTEM WZ10 SMOOTH FINISH, SEE HARDIE DETAIL SHEET A6.5 - COLOR: SW 1015 SKYLINE STEEL
- 3. ENDICOTT 3 5/8" ROLOCK SILL COLOR: MANGANESE BROWN, SMOOTH FINISH
- 4. 20 GUAGE METAL ACCENTS AND SOFFITS COLOR: DARK BRONZE
- INSULATED DARK BRONZE ALUMINUM WINDOWS WITH DUAL PANE TEMPERED GLASS
- 6. QUICKSERVE 48X48 WINDOW COLOR: DARK BRONZE
- 7. AWNING BY OTHERS COLOR: TERRACOTTA
- 8. INSULATED HOLLOW METAL DOOR AND FRAME COLOR: SHERWIN WILLIAMS SW9175 DEEP FOREST BROWN EGGSHELL FINISH
- 9. PEEP HOLE, BY DOOR MANUFACTURER
- DOOR BELL
- 11. 20 GUAGE METAL PARAPET CAP COLOR: DARK BRONZE
- 12. LINE OF ROOF BEYOND
- 13. ROOF TOP UNIT BEYOND, SEE MECHANICAL DRAWINGS
- 14. ROOF SCUPPER AND DOWNSPOUT, SEE DETAIL 8/A6.3
- 15. MAILBOX BY OWNER
- 16. WALL MOUNTED LIGHT FIXTURE, SEE ELECTRICAL DRAWINGS
- 17. LED LIGHT BAND, SEE ELECTRICAL DRAWINGS
- 18. SES PANEL, SEE ELECTRICAL DRAWINGS
- 19. ELECTRICAL OUTLETS, SEE ELECTRICAL DRAWINGS
- 20. HOSE BIBB, SEE PLUMBING DRAWINGS
- 21. NOT USED
- 22. SPANDREL GLASS
- 23. START HARDIE PANEL SIDING HERE



SCOOTER'S COFFEE

PROJECT ADDRESS:

REVISIONS:

EXTERIOR ELEVATIONS

DATE: 11.22.2021

> PROJECT NO. 21-378


- ☐ DESIGN DEVELOPMENT☒ PERMIT SUBMITTAL
- IX PERMIT SUBMIT☐ BID PACKAGE
- ☐ CONSTRUCTION ISSUE

SHEET NO.

A3.1

2 EXTERIOR ELEVATIONS - SOUTH

SCALE: 3/8" = 1'-0"

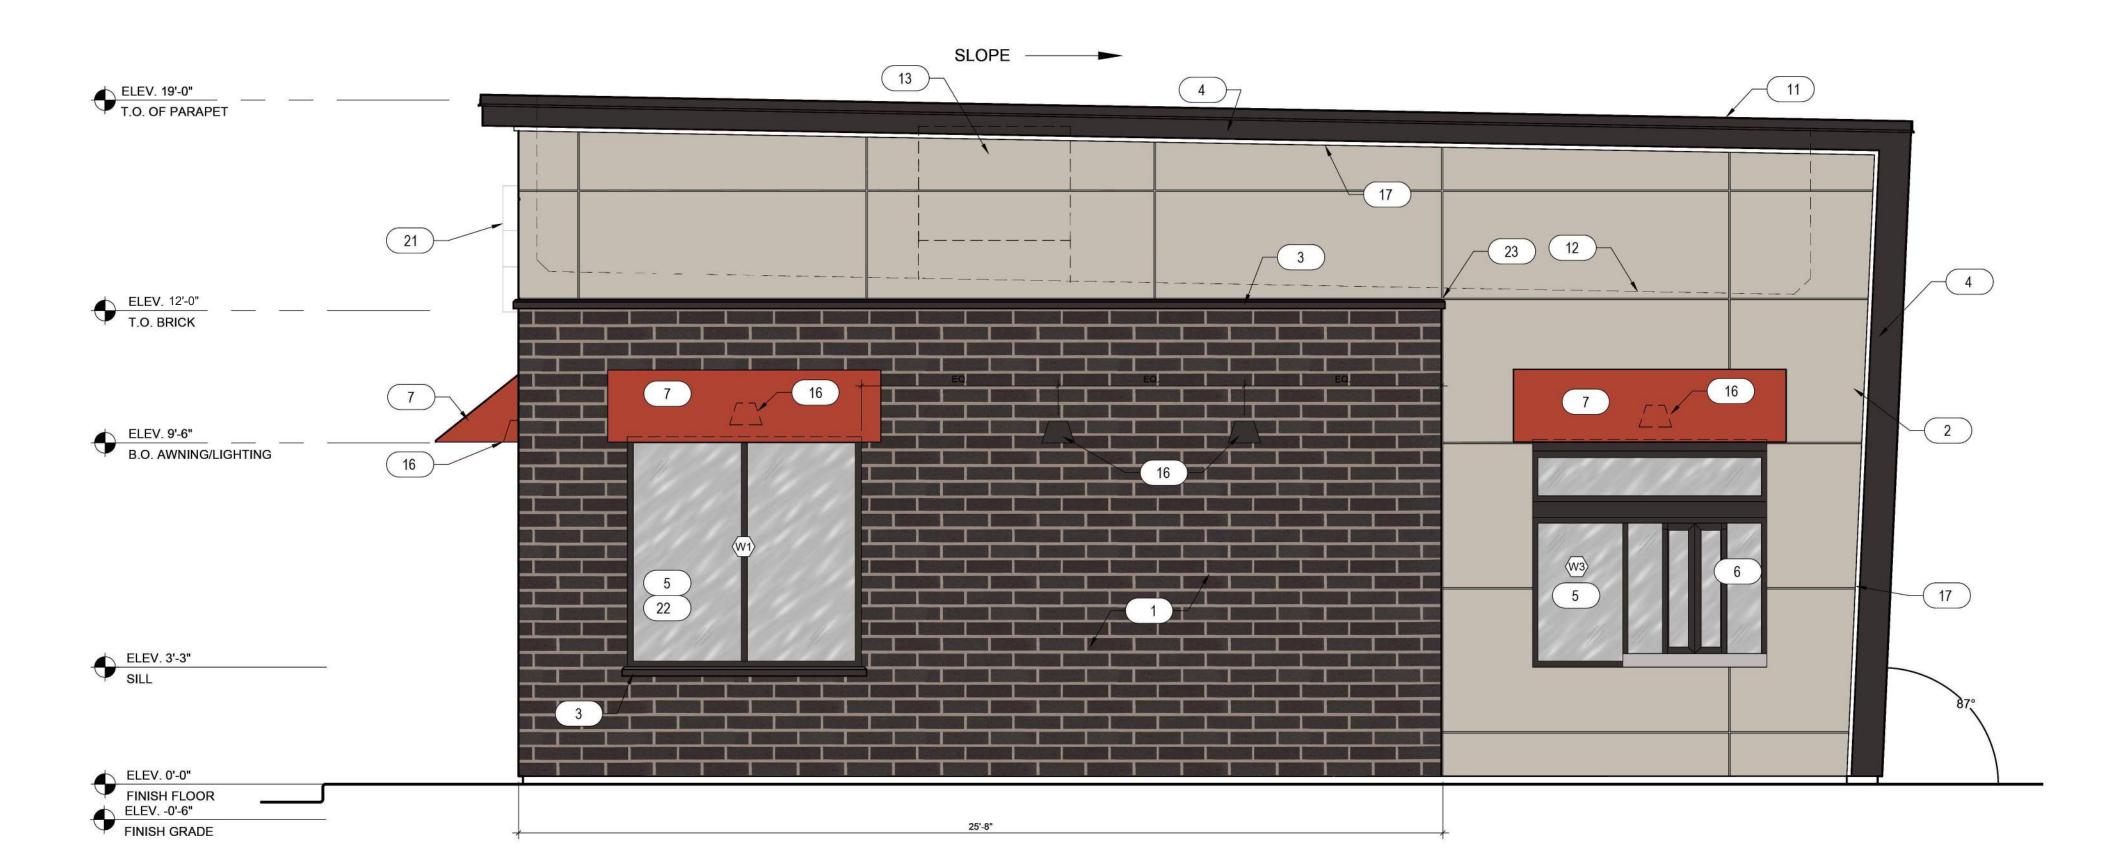

1 EXTERIOR ELEVATIONS - EAST

SCALE: 3/8" = 1'-0"

### **KEYNOTES**



- ENDICOTT THIN BRICK VENEER, RUNNING BOND COLOR: MANGANESE BROWN, SMOOTH FINISH
- 2. HARDIE REVEAL PANEL SYSTEM WZ10 SMOOTH FINISH, SEE HARDIE DETAIL SHEET A6.5 COLOR: SW 1015 SKYLINE STEEL
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- 14. ROOF SCUPPER AND DOWNSPOUT, SEE DETAIL 8/A6.3
- 15. MAILBOX BY OWNER
- 16. WALL MOUNTED LIGHT FIXTURE, SEE ELECTRICAL DRAWINGS
- 17. LED LIGHT BAND, SEE ELECTRICAL DRAWINGS
- 18. SES PANEL, SEE ELECTRICAL DRAWINGS
- 19. ELECTRICAL OUTLETS, SEE ELECTRICAL DRAWINGS
- 20. HOSE BIBB, SEE PLUMBING DRAWINGS
- 21. NOT USED
- 22. SPANDREL GLASS
- 23. 3 1/2" HARDIE TRIM, SEE HARDIE DETAIL SHEET A6.5 COLOR: SW 1015 SKYLINE STEEL
- 24. START HARDIE PANEL SIDING HERE



TWENTY FIVE YEARS

15974 N. 77th ST., STE 100



PROJECT ADDRESS:

REVISIONS:

EXTERIOR ELEVATIONS

DATE: 11.22.2021

PROJECT NO. 21-378

☐ DESIGN DEVELOPMENT

▼ PERMIT SUBMITTAL

■ BID PACKAGE

☐ CONSTRUCTION ISSUE

SHEET NO.

A3.2