



690 Chesterfield Pkwy W • Chesterfield MO 63017-0760 Phone: 636-537-4000 • Fax 636-537-4798 • www.chesterfield.mo.us

Architectural Review Board Staff Report

Project Type: Architectural Specialty Lighting Package

Meeting Date: November 14, 2019

From: Chris Dietz, Planner

Location: North of Chesterfield Airport Road, east of its intersection with Chesterfield

Commons Drive and abutting Interstate 64.

Applicant: Core States Group

Description: Kemp Auto Museum, Lot B (Chase) Specialty Lighting Package: An Architectural

Specialty Lighting Package for a 1.03-acre tract of land zoned "PC"—Planned Commercial District located north of Chesterfield Airport Road, east of its

intersection with Chesterfield Commons Drive.

PROPOSAL SUMMARY

This request is for an Architectural Specialty Lighting Package for the proposed financial institution building on Lot B of the Kemp Auto Museum subdivision. Specifically, blue accent lighting is proposed that is intended to shine upward from the top of canopies on north and south façades facing Interstate 64 and Chesterfield Airport Road, respectively. The blue accent LED lighting would be static in nature and would highlight soffits, upper walls above the main entry as well as the hip roof on the tower element. The blue color is specific to the tenant's corporate color scheme. Within this submittal packet, the applicant has provided a Statement of Design, cutsheets, night renderings, elevations and real-life examples of similar lighting on existing buildings elsewhere. The hours of illumination requested for this fixture are from dusk until dawn.



Figure 1: Aerial View

(Continued)

Nov 04 2019

Department of Public Services



PLANNING & DEVELOPMENT SERVICES

ARCHITECTURAL SPECIALTY LIGHTING PACKAGE APPLICATION

The purpose of an architectural specialty lighting package is to provide comprehensive, complementary and unified architectural specialty lighting throughout a single development or contiguous lots under common ownership. If an architectural specialty lighting package exists for a multi-lot development or subdivision, then individual lots within that subdivision or development may not submit their own, separate architectural specialty lighting package. In addition, developments of a certain size, quality, or mix of uses may require special architectural specialty lighting consideration. Therefore, in order to encourage superior design, quality and character, comprehensive architectural specialty lighting packages allow for specialized review of architectural specialty lighting and flexibility from standard site lighting requirements.

Consideration of flexibility in architectural specialty lighting criteria is based on a number of review factors including, but not limited to, the physical impact of the proposed architectural specialty lighting package, the quality of the proposed architectural specialty lighting package, and mitigation of unfavorable conditions such as excessive lighting, light spillover, height, and other related conditions and potentially negative impacts.

Prior to submitting an application to the Dept. of Planning & Development Services, the Applicant is encouraged to schedule a pre-application meeting to discuss the proposal. To schedule a meeting, contact the Department at (636) 537-4748. For questions about this application, contact the "Planner of the Day" at (636)-537-4733.

I. APPLICANT INFORMATION							
Owner(s)	Owner(s) of record of the hereinafter described property according to St. Louis County Assessor's						
Record:	: Caplaco Ninteen, Inc. (Capitol Land Company), Patrick Cunningham Director of Devel						
Address:	11850 Studt Ave (Owner A	ddress), 16985 Chest	terfield A	Airport F	Rd (Site	Address)	
City:	St. Louis		State:	МО	Zip:	63141	
Tel.:	(314) 991-8900, Ext. 253		Fax:				
Applicant, if other than owner(s):		Gerald Howley, P.E.	•				
Address:	6500 Chippewa Street						
City:	St. Louis		State:	МО	Zip:	63109	
Tel.:	314-843-4320		Fax:				
Legal Interest: Representative of Bank leasing property (JPMorgan Chase Bank, N.A.)					, N.A.)		
(Provide da	Provide date of contract and date of expiration of contract)						

690 Chesterfield Parkway West, Chesterfield, MO 63017-0760 Ph. (636)537-4746 Fax (636)537-4798 www.chesterfield.mo.us

	II. PROPERTY INFORMATION	
Project Name: JPI	Morgan Chase Bank	
Locator Number(s):	17T140363	
(List additional locato	or numbers on separate sheet and attach to application)	
Acreage: 1.03	(To the nearest tenth of an acre)	
Subdivision Name:	Caplaco Ninteen	
Plat Book/Page:	09 - 0803A	
Proximity to closest	major intersection: 1.2 Mile E. of Boone's Crossing and Chesterfield Airport Rd	
Existing Overlay Districts: Check () all that apply C.U.P. Other:		
	III. ZONING	
Current Zoning Dist	rict: Planned Commercial District	
Existing Uses(s) on p	roperty: Vacant Lot	

IV. ADJACENT PROPERTY

Identify surrounding land uses and zoning designations. Include existing/approved square footage or number of dwelling units, type of units, and density.

Property	Land Use	Zoning	Lighting Package? Y/N	Ordinance No.
North	I-64 Right of Way	N/A	Υ	
South	Commercial	PC District	Υ	
East	Commercial	PC District	N	
West	Commercial	PC District	N	

V. ARCHITECTURAL SPECIALTY LIGHTING PACKAGE SUBMITTAL

All Applications shall be accompanied by an Architectural Specialty Lighting Package that presents the information below in a clear, concise, and orderly manner.

- 1) A narrative to the Architectural Specialty Lighting Package, including purpose, scope, design, and consistency with the development's architectural themes. The narrative should address how the Architectural Specialty Lighting package promotes superior design, quality and character.
- 2) The narrative shall include a description of the location, illumination level, color, dimensions, mounting height, construction material, hours of use, nature (static, shifting, flashing, blinking, animation, graphics, light patterns, etc.), frequency and duration of lighting shifts/changes, brightness, and type of all proposed architectural accent lighting fixtures.
- 3) Detailed, high-resolution, color elevations drawn to scale of all structures containing proposed architectural specialty lighting fixtures.
- 4) Night view perspectives or renderings.
- 5) Photographs of all existing architectural specialty lighting fixtures.
- 6) Lighting plans indicating the location of all standards and fixtures and the proposed type of illuminating devices, fixtures, lamps, supports, reflectors, and other devices as well as threedimensional photometric elevations denoting foot-candle levels on all impacted building elevations and adjacent ground areas.
- 7) A cut sheet will be required for each proposed fixture and associated shielding.
- 8) Where shielding is not provided in conjunction with the proposed light fixture, information indicating that no light trespass or sky glow will result from the requested fixture is required.
- 9) Photographs of similar installations or building applications.
- 10) Photographs of adjacent properties.
- 11) Any additional materials as required by the City of Chesterfield.

VI. STATEMENT OF CONSENT

AGEN	CY	CONSENT	Γ
AGEN	CY	CONSEN	

I hereby give CONSENT to Chad Fairbanks, P.E. (type, stamp or print clearly full name of agent) to act on my behalf to submit, this application and all required material and documents, and to attend and represent me at all meetings pertaining to the application(s) indicated above. Furthermore, I hereby give consent to the party designated above to agree to all terms and conditions which may arise as part of the approval of this application.

I hereby certify I have full knowledge of the property and I have an ownership interest and/or am the owner under contract in the subject of this application. I further certify the statements or information made in any paper or plans submitted herewith are true and correct to the best of my knowledge. I understand this application, related material and all attachments become official records of the City of Chesterfield, Missouri, and will not be returned. I understand that any false, inaccurate or incomplete information provided by me or my agent will result in the denial, revocation or administrative withdrawal of this application, request, approval or permits. I acknowledge that additional information may be required to process this application. I further consent to the City of Chesterfield to publish, copy or reproduce any copyrighted document submitted as a part of this application for any third party. I further agree to all terms and conditions which may be imposed as part of the approval of this application.

OWNER/CONTRACT PURCHASER INFORMATION:	
I am the ✓ owner ☐ contract purchaser. (check (✓) one)	6
Patrick Cunningham - Director of Development	Charle C.
(Name- type, stamp or print clearly) Capitol Land Company	(Signature) 11850 Studt Ave., St. Louis MO 63141
(Name of Firm) Attach additional sheets as necessary. NOTARY PUBLIC INFORMATION: STATE OF MISS	(Address, City, State, Zip) SOURI, CITY OF CHESTERFIELD
Before me appears Patrick Cunungham who has e the foregoing instrument was subscribed and sworn to before this 20 19 Signed Print N	
Notary Public My Commission Expires: ///2//9 Print N Seal/Stamp:	SHARON M. WAGNER Notary Public - Notary Seal State of Missouri Commissioned for St. Louis County My Commission Expires: November 21, 2019

Commission Number: 11271038

VII.	COMPI	ETENESS	AND A	CCURA	CV

INSTRUCTIONS: To be completed by individual submitting application (property owner, applicant with consent, or authorized agent).

.,	
Project Name: Chase Chesterfield Bank	Submittal Date : 09/26/2019
I hereby certify all property owners have full knowled application. I hereby certify that all owners and petimaterial, attachments and documents submitted to the further certify the statements or information made in correct to the best of my knowledge. I understand that attachments become official records of the City of understand that any knowingly false, inaccurate or in the denial, revocation or administrative withdrawal of acknowledge that additional information may be reapplication. I further represent and warrant that I have gratuity, or consideration, directly or indirectly, to a Chesterfield with respect to this application. I further or reproduce any copyrighted documents submitted as agree to all terms and conditions which may be impossible.	itioners have been provided a complete copy of all the City of Chesterfield relating to this application. It any paper or plans submitted herewith are true and this application, related application material and all Chesterfield, Missouri and will not be returned. It complete information provided by me will result in this application, request, approval or permit. I further equired by the City of Chesterfield to process this e not made any arrangement to pay any commission any official, employee, or appointee of the City of consent to the City of Chesterfield to publish, copy a part of this application for any third party. I further
Consent is required from all property owner(s) and/or if the property owner(s) or contract purchaser does n and submit in person all material pertaining to the a owner/contract purchaser. Consent to a firm shall be a specified. Consent is valid for one year from date of no recorded warranty deed for subject property.	ot intend to attend all meetings and public hearings application. A separate form is required from each decemed consent for the entire firm, unless otherwise
Check (v) one: * I am the property owner. I am the duly appointed ag	I have legal interest in the property.
Chad Fairbanks, P.E.	Child Davis
(Name- type, stamp or print clearly)	(Signature)
Core States Group	6500 Chippewa, Suite 200, St. Louis, MO 63109
(Name of Firm)	(Address, City, State, Zip)
* Attach additional sheets as necessary.	
NOTARY PUBLIC INFORMATION: STATE OF	MISSOURI, CITY OF CHESTERFIELD
Before me appears CHAD FAIRBANKS we executed the foregoing instrument was subscribed and before me this 20 19 Notary Rublic Seal/St	Print Name: K. SA-Bo Lumin K SABO
My Commission Expires: 12.11.2020	St. Louis County
690 Chesterfield Parkway West,	2 0 1
Ph. (636)537-4746 Fax (636)537- 05/2018	4798 www.chesterfield.mo.us

05/2018

	VIII. PARTIES O	FINTERES	ST		
Principal Address:	Contact: Bruce LaSurs 6500 Chippewa St., Suite 200	Title:	Senior	Project	t Architect
	St Louis	Ct.t.	МО	77.1	63100
City: Tel.:	314-843-4320		IVIO	Zip:	63109
Email:	blasurs@core-states.com	Fax:	(——		
eman.	Elasars@core states.som				
Other Cor	ntact: Patrick Cunningham - Owner's Repre	esentative -	Capitol	Land C	Company
Address:	11850 Studt Ave.				
City:	St. Louis	State:	МО	Zip:	63141
Tel.:	314-991-8900 ext. 253	Fax:		-	*
Email:	pfc@caplaco.com				-
Other Co.	ntact:				
Address:					
City:				Zip:	
Tel.:					
Email:					
Other Cor	ntact:				
City:	8			Zip:	
Tel.:	25—————————————————————————————————————	-			
Email:	3				
ttach addit	ional sheets as necessary.				
	IX. FE	ES			
based on th 1. Ar	fees for an application for review of architecte information below: new architectural specialty lighting package thing package will require a non-refundable for	or modifica	tion of a		
	روا الواقع المائمة الواقع الواقع الواقع ا		ar (art (art art) are are.		
	STAFF USE	ONLY			
Planner:	\ 		ate: _		

690 Chesterfield Parkway West, Chesterfield, MO 63017-0760 Ph. (636)537-4746 Fax (636)537-4798 www.chesterfield.mo.us

engineering architecture project management construction management permitting development services



September 26, 2019

City of Chesterfield, MO Architectural Review Board 690 Chesterfield Pkwy W Chesterfield, MO 63017



Re:Chase Bank, Chesterfield MO 16897 Chesterfield Airport Rd. Core States Group – Architectural Specialty Lighting Package

For consistent design and integrated branding, Chase bank in Chesterfield will have blue accent lighting to tie their signature color to the special building features, relief details, and signs, enhancing the business image and presenting Chesterfield as the premier Community of Choice in the St Louis region. To reinforce the superior design, quality and character of the bank, application of the blue accent light is a subtle feature, highlighting the high soffits, upper walls and hip roof on the tower element, strengthening the central building form/massing and connection between the Chesterfield Airport Road windows and the I-64/40-facing building entrance.

Philips Color Kinetics LED accent fixtures (eColor Graze QLX Powercore) will be limited to a 10'-8" mounting height on top the central projecting storefront canopies of the north and south facades, aiming up at the soffits and high central walls. These are high quality exterior, wet-rated LED luminaires, having anodized aluminum housings and impact resistant polycarbonate lenses, with intelligent light output in the 3500 to 4000 Kelvin color temperature range. Using 2', 4', and 8' sections, these 189 lumen output lights will extend the width of the canopy top to lightly wash the upper walls, cornice and soffits with less than 3.5 footcandles of blue light, in a 30 x 60-degree beam spread. Factory set to consume less than 5 watts per linear foot, these fixtures support ASHRAE standards and meet LEED green building certification. This design constrains the light to the window soffit depth and projecting hip roof soffit, for maximum light control and minimal light trespass/sky glow, if any.

Properly aimed, there will be no direct ground lighting component from this static blue accent lighting. Controlled switching is integrated with building sign and site/security lighting to energize at dusk and turn off at dawn, as allowed by local ordinances in coordination with 24-hour Drive Up ATM and 24-hour ATM Vestibule operations. There are no shifts in lighting frequency and duration, nor is there any animation.

Please reference the color night renderings for this Chesterfield Valley location, and similar project photographs showing the soft wall-grazing, blue accent light.

Sincerely,

R. Bruce LaSurs, AIA Senior Project Architect Core States Group Inc.





SOUTH ELEVATION (CHESTERFIELD AIRPORT RD)





PAINT - EPT 1
APPLICATION: EXTERIOR MATERIAL COLOR: MATCH TO SHERWIN WILLIAMS SW-7045 "INTELLECTUAL GRAY"



PAINT - EPT2
APPLICATION: EIFS
COLOR: TO MATCH SHERWIN WILLIAMS
SW-7036 "ACCESSIBLE BEIGE"



PAINT - EPT4
APPLICATION: EIFS
COLOR: TO MATCH SHERWIN WILLIAMS
SW-6108 "LATTE"



ROOF APPLICATION: ASPHALT SHINGLES COLOR: WEATHERED WOOD














Nov 04 2019

Department of Public Services





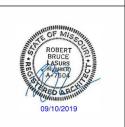

THESE DRAWINGS ARE NOT COMPLETE WITHOUT TH SEPARATE TYPE WRITTEN SPECIFICATIONS MANUAL WHICH ARE PART OF THE CONTRACT DOCUMENTS

PRELIMINARY PLANNING SUBMITTAL - NOT FOR CONSTRUCTION

ISSUE	DATE	DESCRIPTION
1	02/20/2019	ISSUE TO PLANNING BOARD
PRO	JECT INFO	ORMATION
PR	OJECT NO:	JPM.26022
DA	TE:	08/02/2019
PR	OTOTYPE:	18.2
DR	AWN BY:	K.SCHOPP
CH	ECKED BY:	B.LASURS
SC	ALE:	1/4" = 1'-0'
SHEET	TITLE	

PROPOSED **ELEVATIONS**

SHEET NUMBER

EL-01



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PRELIMINARY PLANNING SUBMITTAL - NOT FOR CONSTRUCTION

ISSUE	DATE	DESCRIPTION
1	02/20/2019	ISSUE TO PLANNING BOARD
PRO	IECT INFO	ORMATION
	OJECT NO:	JPM.26022
	TE:	08/02/2019

18.2 K.SCHOPP B.LASURS 1/4" = 1'-0" DRAWN BY:
CHECKED BY:
SCALE:
SHEET TITLE

PROPOSED **ELEVATIONS**

SHEET NUMBER

EL-02





PAINT - EPT4
APPLICATION: EIFS
COLOR: TO MATCH SHERWIN WILLIAMS
SW-6108 "LATTE"









BRICK BR-2
APPLICATION: EXTERIOR
COLOR: TO MATCH ADJACENT
SHOPPING CENTER

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J.P. MORGAN CHASE CHESTERFIELD
16897 CHESTERFIELD AIRPORT RD
CHESTERFIELD, MO 63005
38200P316271





THESE DRAWINGS ARE NOT COMPLETE WITHOUT THE SEPARATE TYPE WRITTEN SPECIFICATIONS MANUAL WHICH ARE PART OF THE CONTRACT DOCUMENTS.

PRELIMINARY PLANNING SUBMITTAL - NOT FOR CONSTRUCTION

ISSUE	DATE	DESCRIPTION
1	02/20/2019	ISSUE TO PLANNING BOARD
PRO	JECT INFO	ORMATION
PR	OJECT NO:	JPM.26022
DA	TE:	08/02/2019
PR	OTOTYPE:	18.2
DR	AWN BY:	K.SCHOPP
CH	ECKED BY:	B.LASURS
SC	ALE:	1/4" = 1'-0"

PROTOTYPE:
DRAWN BY:
CHECKED BY:
SCALE:
SHEET TITLE PROPOSED DRIVE THRU ATM & TRASH **ENCLOSURE ELEVATIONS**

EL-03





T.O. ENCLOSURE

T.O. STONE + 2'-0'

T.O. ENCLOSURE

T.O. STONE + 2'-0"



T.O. ENCLOSURE

T.O. STONE + 2'-0"

T.O. SLAB 0'-0"

WEST ELEVATION

SOUTH ELEVATION

(SIDE)

T.O. ENCLOSURE 6'-4"

T.O. STONE + 2'-0" T.O. SLAB 0'-0"

(FRONT)

NORTH ELEVATION

EAST ELEVATION

(REAR)

(SIDE)











CHESTERFIELD AIRPORT RD.

CHESTERFIELD

16897 CHESTERFIELD AIRPORT RD CHESTERFIELD, MO 63005 CHASE OVP#: 38200P316271










CHESTERFIELD

16897 CHESTERFIELD AIRPORT RD CHESTERFIELD, MO 63005 CHASE OVP#: 38200P316271



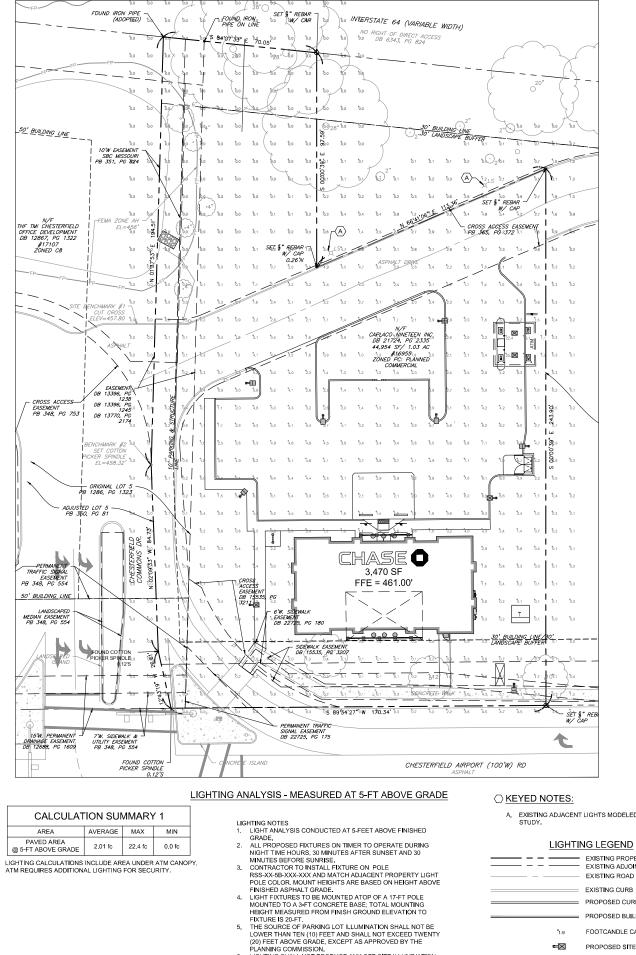

	CALCULATION SUMMARY 1						
JNT	AREA	AVERAGE	MAX	MIN			
T. -8"	PAVED AREA @ 5-FT ABOVE GRADE	2.01 fc	22.4 fc	0.0 fc			
	LIGHTING CALCULATIONS	INCLUDE AR	EA UNDER	ATM CANO	- PY		

LUMINAIRE SCHEDULE

CATALOG

ECRA0A5F54001BWHTE

DI4R10930FL1V/2V10

DSX0-LED-P4-40K-T5W-MVOLT

DSX0-LED-P4-40K-TFTM-MVOLT

DSX0-LED-P4-40K-T3M-MVOLT-HS

DSX0-I FD-P4-40K-T3S-MVOLT-HS

eCOLOR GRAZE QLX POWERCORE 2

QTY DISTRIBUTION

TYPE 5

TYPE 1

TYPE 5

TYPE 5

TYPE 4

TYPE 3

TYPE 3

9'-6"

20'-0"

20'-0"

20'-0"

20'-0"

ACCENT

MODEL

RECESSED CANOPY LIGHT

EMLED SERIES - EUE

D-SERIES 0

D-SERIES 0

D-SERIES 0

D-SERIES 0

LINEAR

SYMBOL MANUFACTURER

GE

MULE LIGHTING

GE

LIGHTING

LITHONIA LIGHTING

LITHONIA

LIGHTING

COLOR KINETICS

 \bowtie

PLANNING COMMISSION.

6. LIGHTING SHALL NOT PRODUCE ANY OFF-SITE ILLUMINATION OR AS APPROVED BY THE PLANNING COMMISSION.

A. EXISTING ADJACENT LIGHTS MODELED FOR THIS LIGHTING

 EXISTING PROPERTY BOUNDARY LINE EXISTING ADJOINING PROPERTY LINE EXISTING ROAD CENTERLINE EXISTING CURB PROPOSED CURB

FOOTCANDLE CALCULATION POINT

PROPOSED SITE LIGHT FIXTURE



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MSD BASE MAP #17T MSD P# 19MSD-00273 CORI

U



REVISIONS COMMENT 8/08/19 PER MSD COMME 09/11/19 PER CITY COMMEN 09/12/19 PER MSD COMMEN

CIVIL CONSTRUCTION DOCUMENTS FOR CHASE BANK

6985 CHESTERFIELD AIRPORT ROAD CHESTERFIELD, MO

63055



LIGHTING PLAN

JOB #:	JPM.2602
DATE:	06-17-1
SCALE:	1*=2
DRAWN BY:	ZPI
CHECKED BY:	CD
SHEET NO.	

LIGHT SYMBOL FROM LIGHTING PLAN

eColor Graze QLX Powercore

Date: ____ Type: ____ Firm Name Project: ___ RECEIVED
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Blue, 30° x 60° Beam Angle, 1219 mm (4 ft)

Performance linear exterior LED wall grazing luminaires with solid color light

eColor Graze QLX Powercore is a high-performance, exterior linear luminaire perfect for applications calling for a balance of cost and performance. It is designed to highlight architectural features ranging from surface textures and molding details to archways and windows. Graze Essential Color luminaires offer intensely saturated solid red, green, blue, or amber light. Multiple fixture lengths, beam angles, output levels, and power consumption levels support a large range of façade or surface illumination applications. Low-profile housing, connectorized cabling, a universal power input range, and direct line voltage operation make Graze luminaires easy to install and operate.



- Tailor light output to specific applications—Available in four standard lengths (1 ft, 2 ft, 3 ft, and 4 ft), four performance levels (MX, QLX, QLX 5W, and EC), and six standard 9° x 9°, 10° x 60°, 15° x 30°, 30° x 60°, 60° x 30°, and 90° x 90° (EC only) beam angles.
- Flexible integration—Graze's ultra-low profile lets it fit discretely into almost any layout, from simple to elaborate.
- Customizable accessories Customize your Graze fixture
 with a choice of three accessories: mounting arm, masking
 shield, and graze louver. Mounting arm available in three
 sizes and three colors (black, white, and gray), and masking
 shield available in four lengths (1 ft, 2 ft, 3 ft, and 4 ft).
- Integrates patented Powercore technology that controls power output to luminaires directly from line voltage – rapidly, efficiently, and accurately. The Color Kinetics Data Enabler Pro merges line voltage with control data and delivers them to luminaires over a single standard cable, dramatically simplifying installation and lowering total system cost.

- Graze provides years of reliable use under rugged conditions. Graze raises reliability even further with more protection from corrosion by meeting ASTM B117 standard and ANSI C136.31-2010 standard with a 3G vibration rating, and elimination of water pooling on the lens.
- Works seamlessly with the Color Kinetics full range of controllers, including Light System Manager, Video System Manager, Video System Manager Pro, iPlayer 3, Antumbra iColor Keypad, and ColorDial Pro—as well as third-party controllers.
- Convenient push-and-click connectors let you easily and rapidly install Leader Cables and Jumper Cables. Constant torque locking hinges offer simple and consistent position control from various angles.

For detailed product information, please refer to the eColor Graze QLX Powercore Product Guide at www.colorkinetics.com/ls/essentialcolor/ecolorgrazeqlxpowercore/



Specifications

Due to continuous improvements and innovations, specifications may change without notice.

Output

Beam Angle	30° x 60°
Color	Blue

Electrical

Input Voltage	100 to 277 VAC, auto-ranging, 50/60 Hz
Power Consumption	40 W
(Maximum at full output, steady state)	
For Surga Protection Paguiran	pants for LED Lighting Systems plags refer

For Surge Protection Requirements for LED Lighting Systems, please refer to www.colorkinetics.com/KB/surge-protection.

Control

Dimmer[‡]

Compatible with selected commercially available reverse-phase ELVtype dimmers

Physical

Dimensions (Height x Width x Depth)	69 x 1219 x 72 mm (2.7 x 48 x 2.85 in)
Weight	4.2 kg (9.3 lb)
Housing Material	Extruded anodized aluminium
Lens	Clear UV-protected polycarbonate
Luminaire Connections	Integral male/female waterproof connectors
Specs Mounting Title	Multi-positional, constant torque locking hinges

Temperature Ranges

- -40 to 50 °C (-40 to 122 °F) Operating
- -20 to 50 °C (-4 to 122 °F) Startup
- -40 to 80 °C (-40 to 176 °F) Storage

Vibration Resistance

Not compliant to ANSI C136.31, 3G. Special orders are available to conform to the standard. Please contact your Color Kinetics Lighting Sales rep for custom configurations.

Mechanical Imi	pact	IK10
Wiccinallical IIII	Jact	11110

Corrosion Resistance

Complies with ASTM B117 standard with special order. Please contact your Color Kinetics Lighting Sales rep for custom configurations.

Humidity 0 to 95%, non-condensing

Luminaire Run Lengths

To calculate luminaire run lengths and total power consumption for your specific installation, download the Configuration Calculator from www.colorkinetics.com/support/install_tool/

Certification and Safety

Approbation	UL/cUL, FCC Class A, CE, PSE, C-Tick
Environment	Dry/Damp/Wet Location, IP66












[‡] Refer to www.colorkinetics.com/support/appnotes/ for more information.

Dimensions

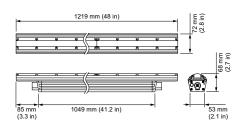

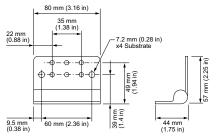



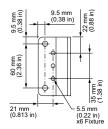

Photometrics, 305 mm (1 ft), 30° x 60° beam angle

Photometric data is based on test results from an independent NIST traceable testing lab. IES data is available at www.colorkinetics.com/support/ies.

Beam Angle	30° x 60°
Lumens	188
Efficacy (lm/W)	20.6



Polar Candela Distribution

Zonal Lumen

Lumens

183.4

187.8


4.4

Zone

- 60 - 90 0

- 90

60

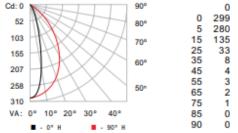


% Fixture


97.6 %

100.0 %

2.4 %

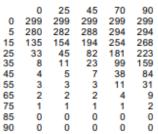

Illuminance at Distance

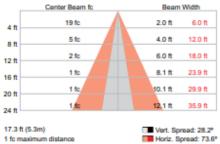

Coefficients of Utilization - Zonal Cavity Method


3


							Ξ	ffect	ive	F10	or	Cavi	ty I	Refle	cta	nce:		20%
RCC %:		8	Ø			7	Ø			80			30			10		0
RW %:	70	50	30	0	70	50	30	0	50	30	20	50	30	20	50	30	20	0
RCR: 0	119	119	119	119	116	116	116	100	111	111	111	106	106	106	102	102	102	100
1	113	110	108	105	111	108	106	93	104	102	100	100	99	97	97	96	95	93
2	107	102	98	94	105	100	97				91		92	89	91	89	88	86
3	102	95									84						81	79
4	96	89						75			77		_			78		74
5	92	83		73	90			70			72			71		73		69
6	87	78	72	67	85	77	71	66	76	70	67	74	70	66	73	69	66	64
7	83	73	67	63	81		67	62		66							62	60
8	79	69	63	59	78	69	63	58	68	62	59	67	62	58			58	57
9	75	66	60	56	74			55		59					62	58	55	54
10	72	62	56	53	71	62	56	52	61	56	52	60	55	52	59	55	52	51

For lux multiply fc by 10.7

Luminaire	Item Number	Item 12NC 910503703544		
eColor Graze QLX Powercore <i>Blue, 30° x 60° Beam Angle, 1219 mm (4 ft)</i>	223-000081-74			
Accessories				
Inground Enclosure, Outer Box for 1219 mm (4 ft) luminaire	120-000190-07	912400133691		
Inground Enclosure, Inner Box for 1219 mm (4 ft) luminaire	120-000190-06	912400133690		
Leader Cable with Terminator, UL/cUL, 3 m (10 ft)	108-000056-03	910503704071		
Leader Cable with Terminator, UL/cUL, 15.2 m (50 ft)	108-000056-00	910503703138		
Leader Cable with Terminator, CE/PSE, 3 m (10 ft)	108-000056-04	910503704072		
Leader Cable with Terminator, CE/PSE, 15.2 m (50 ft)	108-000056-01	910503704069		
lumper Cable, UL/cUL, End-to-End	108-000057-00	910503703139		
lumper Cable, UL/cUL, 305 mm (1 ft)	108-000057-03	910503704076		
Jumper Cable, UL/cUL, 1.5 m (5 ft)	108-000057-06	910503704079		
Jumper Cable, UL/cUL, 3 m (10 ft)	108-000057-09	910503704082		
lumper Cable, CE/PSE, End-to-End	108-000057-01	910503704074		
Jumper Cable, CE/PSE, 305 mm (1 ft)	108-000057-04	910503704077		
lumper Cable, CE/PSE, 1.5 m (5 ft)	108-000057-07	910503704080		
umper Cable, CE/PSE, 3 m (10 ft)	108-000057-10	910503704083		
Glare Shield, 1219 mm (4 ft)	120-000081-03	910503700748		
Mounting Arm, Short, Gray	120-000201-03	912400135843		
Mounting Arm, Medium, Gray	120-000201-04	912400135844		
Mounting Arm, Long, Gray	120-000201-05	912400135845		
Symmetric Louver, 1219 mm (48 in)	120-000202-07	912400135856		
Masking Shield, 1219 mm (48 in)	120-000203-03	912400135860		



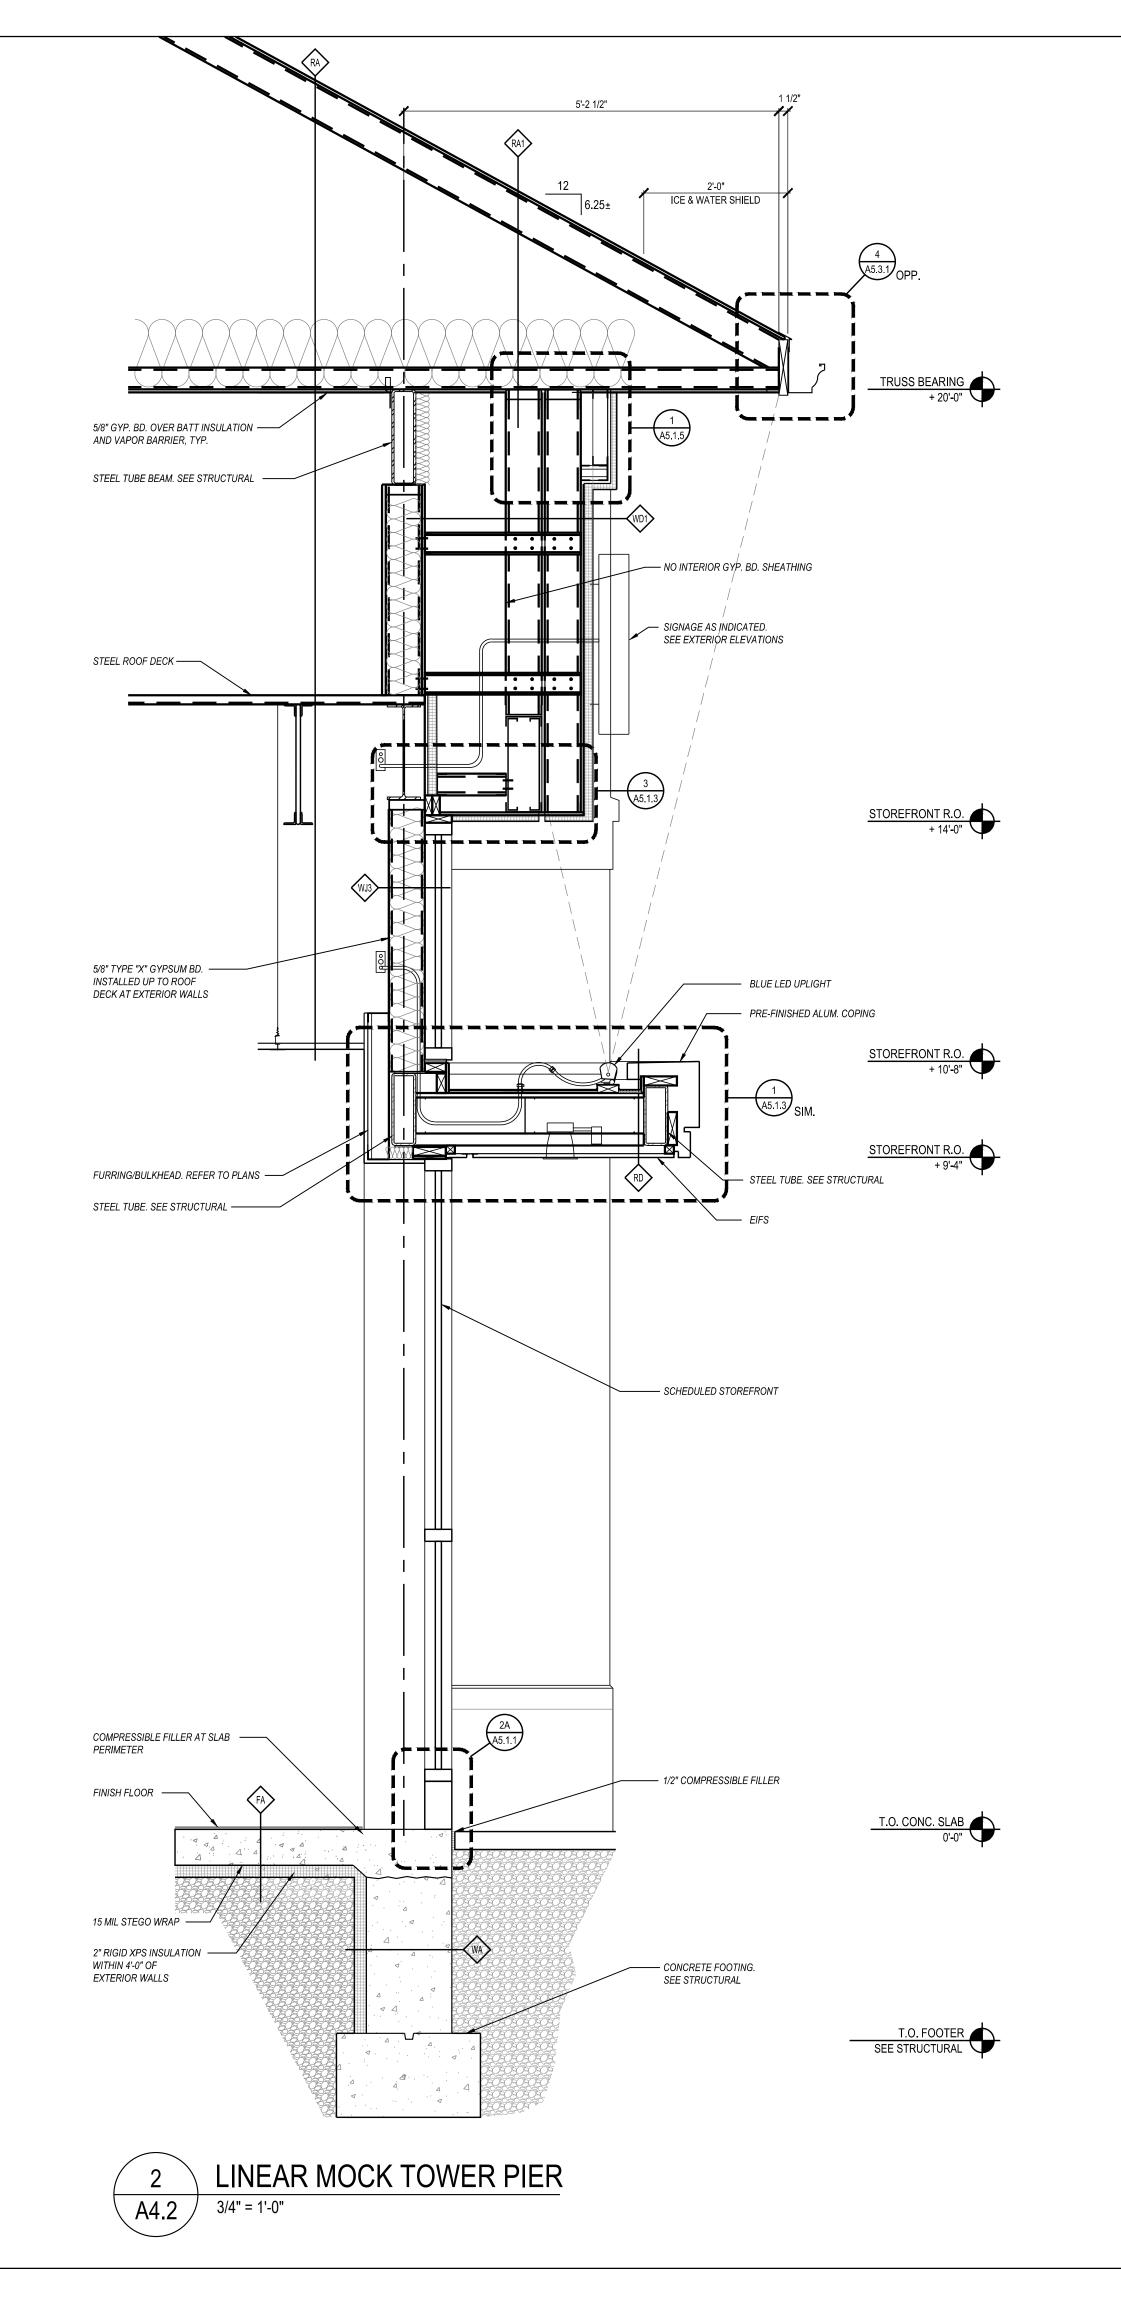

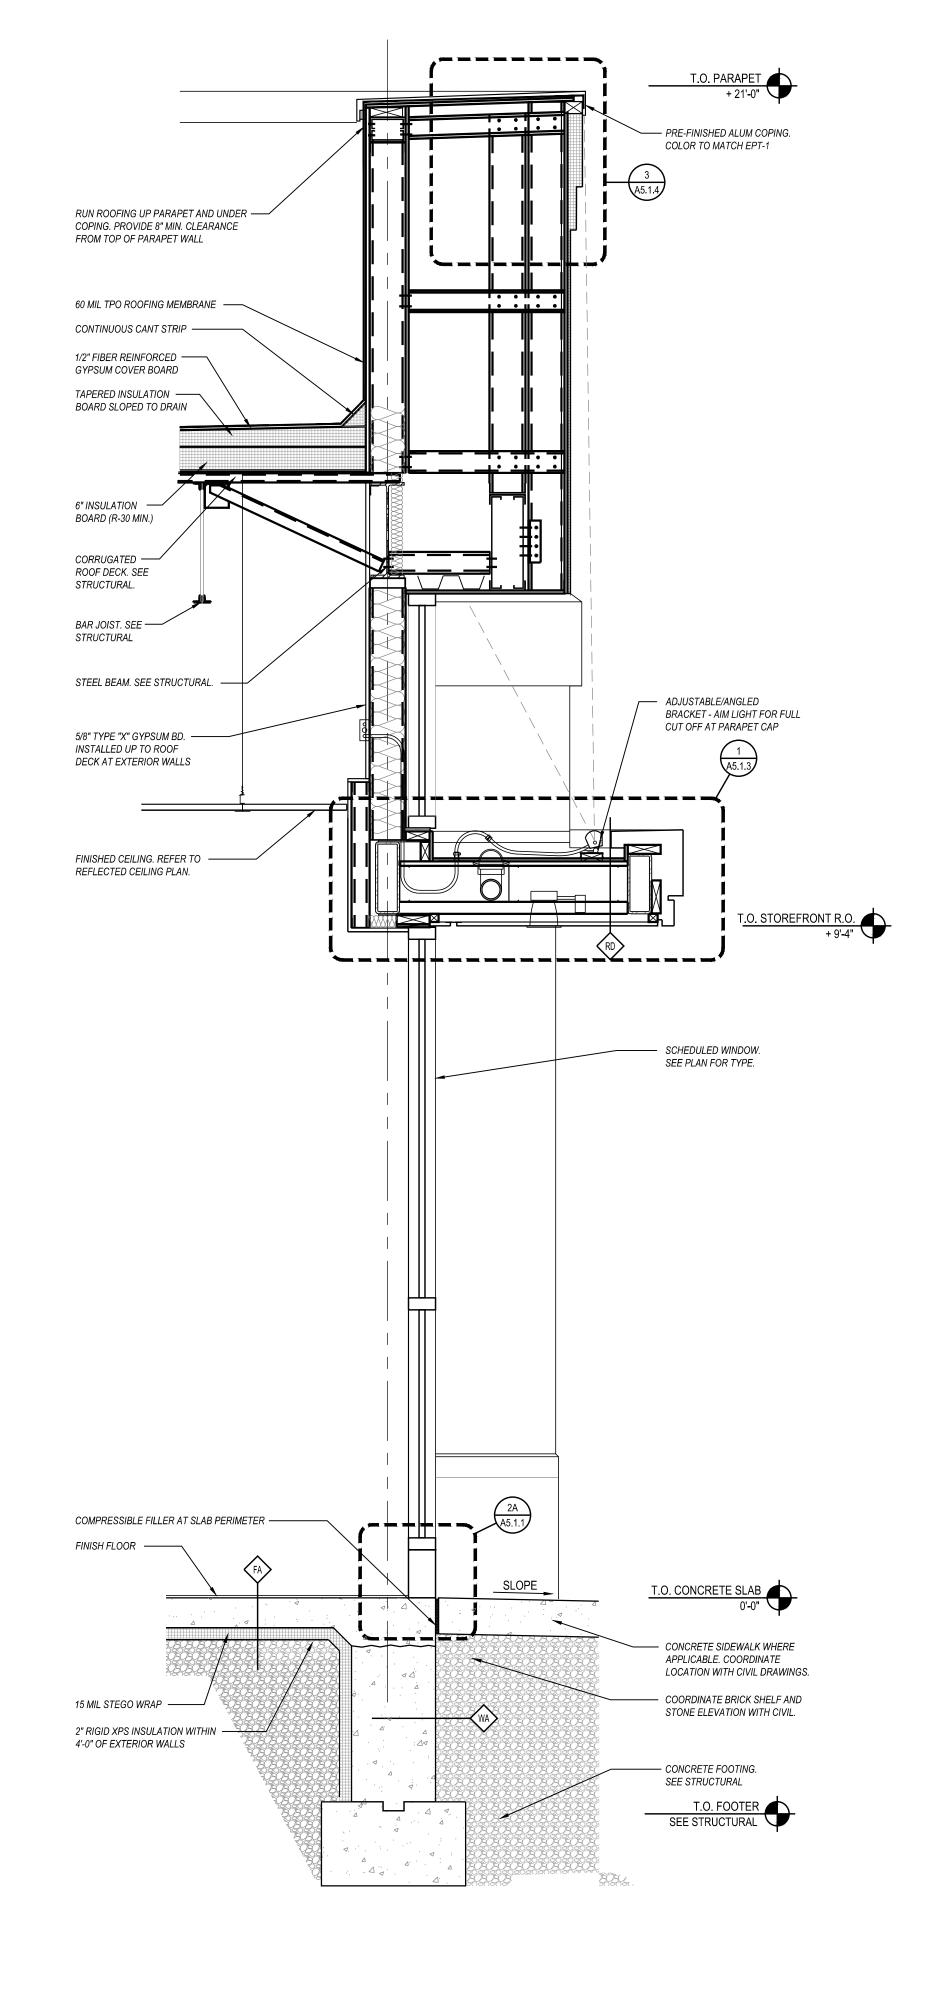

1 MOCK TOWER

A4.2 3/4" = 1'-0"

MORGAN CHASE, N.A
CHESTERFIELD

16985 CHESTERFIELD AIRPORT RD
CHESTERFIELD, MO 63005

GROUP

6500 Chippewa Street
Suite 200
St. Louis, MO 63109
314.843.4320
www.core-states.com

COA# A-2014026908

ARCHITECT OF RECORD

THESE DRAWINGS ARE NOT COMPLETE WITHOUT THE SEPARATE TYPE WRITTEN SPECIFICATIONS MANUAL WHICH ARE PART OF THE CONTRACT DOCUMENTS.

ISSUE DATE DESCRIPTION

0 09.24.2019 PERMIT SET

PROJECT INFORMATION

PROJECT NO: JPM.26022

DATE: 09/24/2019

PROTOTYPE: 18.3

DRAWN BY: K.SCHOPP

B.LASURS

MOCK TOWER SECTIONS


SHEET NUMBER

CHECKED BY:

VERSION:

SHEET TITLE

A4.2

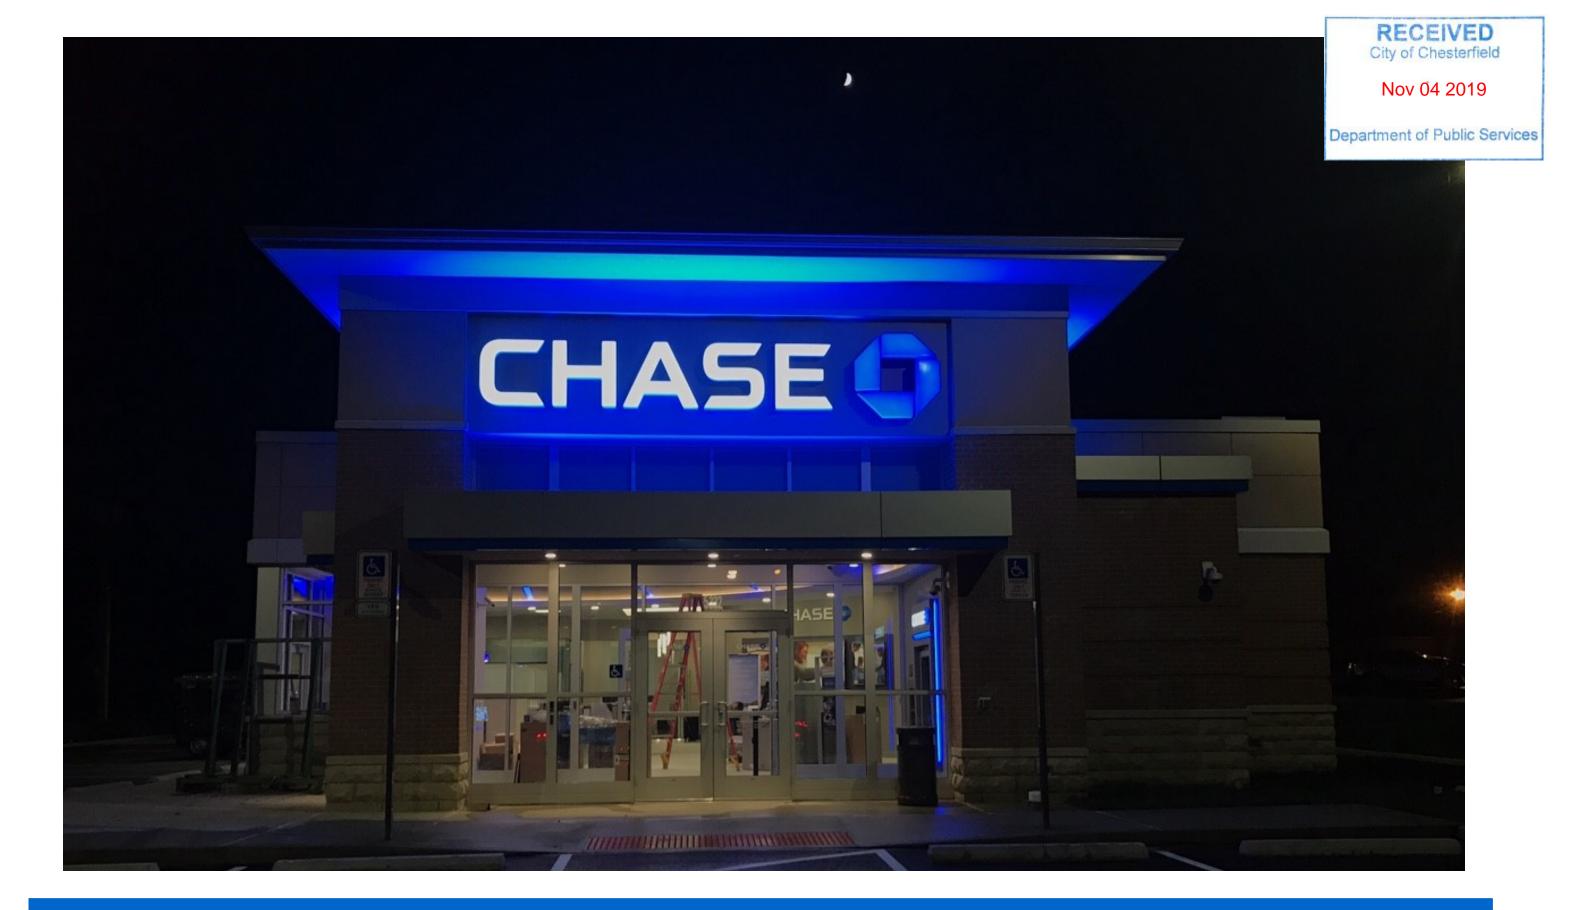





CHESTERFIELD

16897 CHESTERFIELD AIRPORT RD CHESTERFIELD, MO 63005 CHASE OVP#: 38200P316271









CHESTERFIELD

16897 CHESTERFIELD AIRPORT RD CHESTERFIELD, MO 63005 CHASE OVP#: 38200P316271





RECEIVED City of Chesterfield Nov 04 2019 Department of Public Services

LOOKING EAST TO SITE FROM CHESTERFIELD AIRPORT RD



LOOKING SOUTH TO SITE FROM CHESTERFIELD AIRPORT RD



CHESTERFIELD

16897 CHESTERFIELD AIRPORT RD CHESTERFIELD, MO 63005 CHASE OVP#: 38200P316271

PHOTOS





RECEIVED City of Chesterfield Nov 04 2019 Department of Public Services

LOOKING NORTH TO SITE FROM CHESTERFIELD AIRPORT RD



LOOKING WEST TO SITE FROM CHESTERFIELD AIRPORT RD



PHOTOS

CHESTERFIELD

16897 CHESTERFIELD AIRPORT RD CHESTERFIELD, MO 63005 CHASE OVP#: 38200P316271



STAFF ANALYSIS

In general, the Lighting Standards set forth in Section 31-04-03 of the Unified Development Code (UDC) state that exterior building lighting shall be architecturally integrated with the building style, material, and color. The color of exterior lamps shall be consistent with that on surrounding buildings.

Regarding the angle of upward projection, the UDC requires that for all planned districts:

- All exterior lighting shall be unobtrusive, harmonious with the local area, and constructed or located so that only the intended area is illuminated and off-site glare is fully controlled.
 - Applicant states that lighting will not trespass beyond soffits and characterizes proposed upward lighting as accent lighting and has provided an exhibit to depict this (Figure 2).
- Building-mounted lighting, including both utilitarian and decorative applications, shall be limited to fully shielded, cut-off optics, flat-lens luminaires.
 - All other lighting for this project is flat-lensed and fully-shielded.
- The facades of buildings facing I-64/US 40 should utilize accent lighting, as opposed to floodlighting.
 All lighting should consist of metal halide with flat lenses and mounted at a maximum height of thirty (30) feet.
 - Proposed Specialty Lighting is comprised of LED fixtures, mounted no higher than 10'-8" above finished grade and oriented to project upwards.

However, when an architectural specialty lighting package is requested for a proposed or existing development, the criteria for site lighting provided in the UDC may no longer be applicable in its entirety or portions thereof. The reason for a requested modification should be to provide for flexible architectural accent lighting criteria that promotes superior design, and is tailored to a specific development which may vary from general ordinance provisions.

The purpose of an architectural specialty lighting package is to *provide comprehensive, complementary and unified architectural specialty lighting throughout a single development or contiguous lots under common ownership.*

Consideration of flexibility in architectural specialty lighting criteria is based on a number of review factors, including, but not limited to, the physical impact of the proposed architectural specialty lighting package, the quality of the proposed architectural specialty lighting package, and mitigation of unfavorable conditions such as excessive lighting, light spillover, height, and other related conditions and potentially negative impacts. However, in no instance shall architectural specialty lighting applications result in light trespass at the property line.

As this request is specifically for up-lighting, all other lighting fixtures shall adhere to the City's lighting standards established in the UDC. This development would be the first in the Kemp Auto Museum subdivision to apply for an architectural specialty lighting package and is only the third development throughout the City to submit a specialty lighting package. This analysis is concurrent with that provided for the first two Specialty Lighting Package requests (Logan College of Chiropractic, 2018; Metro Lighting, 2019).

(Continued)

Specifically, the UDC states that Architectural Specialty Lighting:

- Shall not be on past approved hours of operation, if any, or 11:00 P.M., whichever is later for non-security lighting, except for that used for special and infrequent occasions.
 - The applicant is requesting hours of operation nightly from <u>dusk-to-dawn</u>.
- Should highlight and accentuate traditional building detailing and architectural features.
 - The applicant states that the blue accent lighting will tie the brand's signature color to the building's accent features.
- Should offer color temperature that underscores building materials and character.
 - The color proposed is the signature blue color of the bank's corporate brand.
- Should highlight distinctive architectural features.
 - The proposed Specialty Lighting fixtures are focused to shine only upon the upper walls of the building's center massing, highlighting the high soffits and tower element.
- Shall be architecturally integrated with the building style, material, and color, and that the color of exterior lamps shall be consistent with that on surrounding buildings.
 - Building material is mainly comprised of tan and off-white colored EIFS. Applicant has stated that the color scheme is consistent with national branding, found at other locations throughout the country. Examples of other locations elsewhere are found in this submittal packet.

The type of fixture proposed would be a permanently-mounted, linear set of 189 wall grazing LED luminaries with solid blue color light, not to exceed 3.5 footcandles along the upper facades of the building's center mass. No shifts in lighting frequency, duration, or animation are being proposed. Please refer to the cutsheets in the submittal packet for further information regarding the technical specifications regarding this type of fixture. For clarification, the proposed lighting fixtures would only run the width of the canopy, and would not wrap around the returns.

Figure 2 illustrates the angle of projection these architectural specialty lighting fixtures are proposed to be mounted. A copy of this exhibit is also included in the submittal packet. Figures 3 and 4 depict nighttime renderings of each of the two locations and color/intensity for these proposed specialty lighting fixtures.

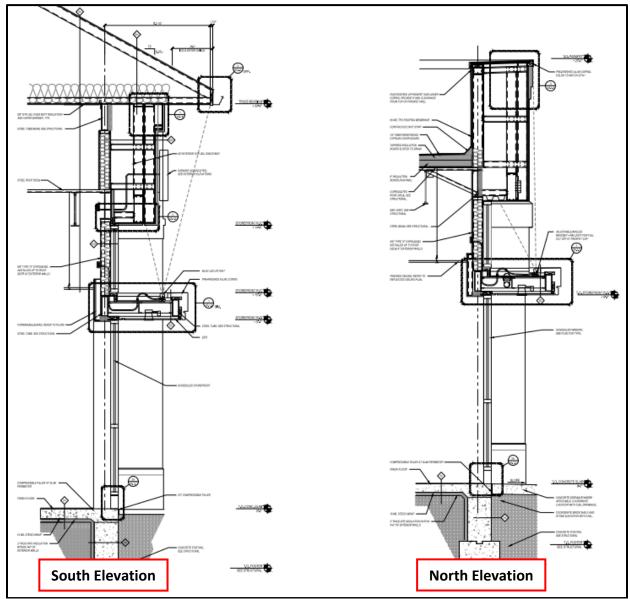


Figure 2: building profile and upward light projection

G. Exterior Renderings



Figure 3: North Elevation as seen from parking lot.



Figure 4: South Elevation as seen by vehicles traveling west on Chesterfield Airport Rd.

DEPARTMENT INPUT

Requests for Architectural Specialty Lighting Packages can be permitted if they are found to be architecturally integrated with the building design and harmonious with the surrounding area. As such, Staff is requesting a recommendation from the Architectural Review Board (ARB) on the Architectural Specialty Lighting Package proposed for the Chase Bank location in the Kemp Auto Museum subdivision. All recommendations made by the ARB will be included in the Staff's report to the Planning Commission.

Staff requests review and recommendation on this Specialty Lighting Package submittal for Kemp Auto Museum—Lot B.

MOTION

The following options are provided to the Architectural Review Board for consideration relative to this application:

- 1) "I move to forward the Architectural Specialty Lighting Package for Kemp Auto Museum, Lot B, as presented, with a recommendation for approval (or denial) to the Planning Commission."
- 2) "I move to forward the Architectural Specialty Lighting Package for Kemp Auto Museum, Lot B to the Planning Commission with the following recommendations..."

Attachments

1. Architectural Specialty Lighting Package Packet