



III. A

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Architectural Review Board Staff Report

Project Type: Site Plan

Meeting Date: November 8, 2018

From: Mike Knight, Planner *MNK*

Location: A 12.6 acre tract of land located on the south side of Old Chesterfield Road, northwest of the intersection with Wild Horse Creek Road.

Description: Aventura at Wild Horse Creek (Above All Development): A Site Plan, Landscape Plan, Lighting Plan, Architectural Elevations and Architect's Statement of Design for a 12.6 acre tract of land located on the south side of Old Chesterfield Road, northwest of the intersection with Wild Horse Creek Road.

PROPOSAL SUMMARY

This request is to allow for development of two apartment buildings containing a total of 176 units. Other significant features within the site include a clubhouse, pool, cabana, maintenance building with carwash, trash compactor with recycle center, and multiple carport structures. The exterior materials primarily range from thin set manufactured stone, cement fiber siding, cement fiber stucco board siding, and asphalt shingles. The subject site is currently zoned "R-6AA" Residence District. This is a conventional zoning district that has a minimum lot size of 3,000 square feet per unit. The area is designated Urban Core within the City of Chesterfield's Comprehensive Land Use Plan. The site will have prominent views from both Wild Horse Creek Road and Old Chesterfield Road.

On Thursday July 12th, 2018, the Aventura at Wild Horse Creek (Above All Development) project was reviewed by the Architectural Review Board. Based on discussion at this meeting, the applicant requested that no action be taken on the project in order to allow time to address issues raised and bring the project back to the ARB at a future meeting.

On Thursday August 9th, 2018, the project was reviewed by the ARB. At this meeting, the applicant requested that no vote be taken but the applicant wanted to show the ARB substantial changes they have made and receive comment/direction to move forward.

On Thursday September 13th, 2018, the project was reviewed by the ARB. At that time the Board made a motion to forward the Site Plan, Landscape Plan, Lighting Plan, Architectural Elevations and Architect's Statement of Design for Aventura at Wild Horse Creek (Above All Development) to Staff with a recommendation to approve with conditions.

The applicant fulfilled the recommendation from the ARB and addressed all comments from Staff. Power of Review was called in accordance to Section 31-02-20 of the Unified Development Code on October 10, 2018.

On October 18, 2018, the project was reviewed by the Planning and Public Works Committee. The Committee expressed the desire for the applicant to revise the plan to position the entrance of the development to align with the Burkhardt Place curb cut. A motion was made to forward the updated plan of Aventura at Wild Horse Creek to the Architectural Review Board for review and comment, and then return it to the Planning and Public Works Committee. The motion passed by a voice vote of 4-0. The applicant has since revised the Site Plan with the entrance of the development to align with the Burkhardt Place curb cut and reduced the number of buildings from 3 to 2.

HISTORY OF SUBJECT SITE

In February of 2018, the City of Chesterfield approved Ordinance 2991 which was petitioned by the same applicant for this Site Plan. The ordinance amended the Unified Development Code by changing the boundaries of a "PC&R" Planned Commercial Residential District, a "C8" Planned Commercial District and a "LLR" Large Lot Residential District to one "R-6AA" Residence District. The areas amended were previously zoned "PC&R" in 2008, "LLR" in the early 2000s, and "C8" by St. Louis County prior to the City's incorporation. The area is currently zoned "R-6AA" Residence District.



Figure 1: Aerial Site Photo

STAFF ANALYSIS

General Requirements for Site Design:

The proposed site is to construct 2 buildings that are 4 stories in height located northwest of the intersection of Old Chesterfield Road and Wild Horse Creek Road and roughly 900 feet from Interstate 64. Given that Old Chesterfield Road is classified as a minor arterial and Wild Horse Creek Road is classified as a major arterial according to the City's functional classification system, all facades will be highly visible from a large number of users. This site is surrounded by mostly undeveloped properties, however the mobile home park is located directly to the north. The area is designated Urban Core within the City of Chesterfield's Comprehensive Land Use Plan.

A. Site Relationships

The Unified Development Code outlines specific desirable and undesirable practices within site relationships. Below is a table outlining the applicable desirable site practices within the UDC and how this Site Plan relates to them.

Desirable Practices	Site Plan
Provide safe pedestrian movement between elements	Sidewalks connect throughout the site between the buildings, parking, and pool area and extend to WHCR. They do not extend down the entrance boulevard.
Provide public plazas, courtyards, assembly areas, etc.	The site has pedestrian access to both a pocket park and pet park
Incorporate scenic views, fountains, public art, etc.	Public art to be located south of the pocket park

Table 1: Desirable Practices

Below in Figure 2 is a color Site Plan for the Aventura at Wild Horse Creek project including amenities such as a trail shelter, bike lane, and proposed public art.

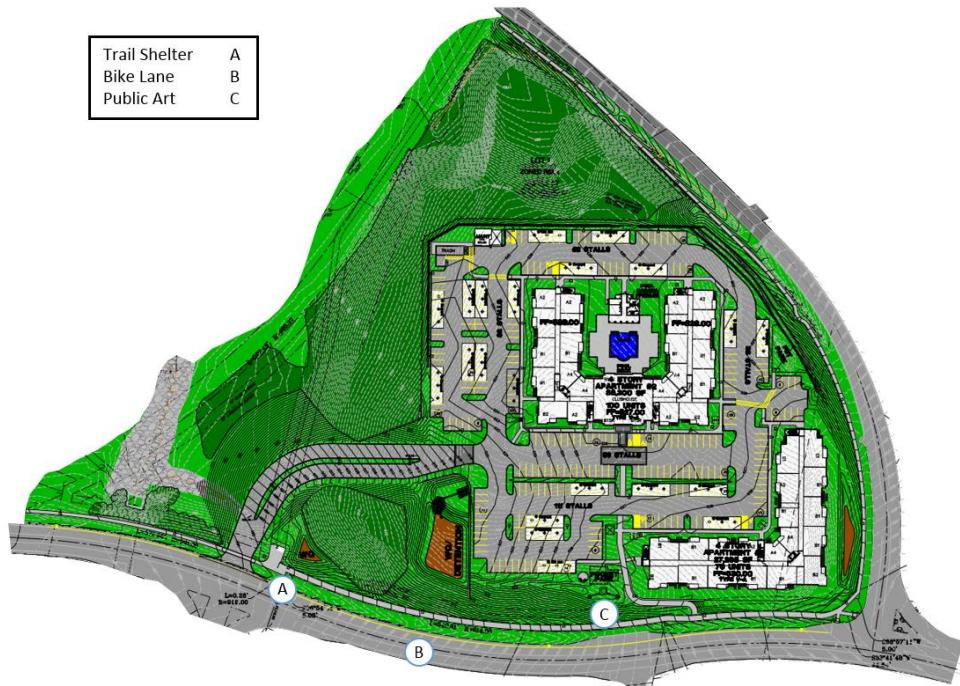


Figure 2: Color Site Plan

B. Circulation System and Access

The subject site will be served by one point of full access off of Wild Horse Creek Road (WHCR) which is a major arterial roadway, owned and operated by St. Louis County, and currently has a speed limit of 40 MPH. There will be on-street bicycle accommodations designated along WHCR. A sidewalk is proposed along both WHCR and Old Chesterfield Road (OCR). There is one pedestrian entrance by a sidewalk along WHCR. Internally there is pedestrian infrastructure that connects all the buildings, pool, trash, pocket park, pet park, and BBQ areas.

To the western edge of the site is a dedicated easement for the future Riparian Trail. This can be seen on Figure 2 directly above the "A". The "A" is referencing a future Trail Shelter. This shelter will contain seating, a bike rack, and an overhang to provide shelter from some of the elements. This also contributes to the multi-modal component referenced in the Urban Core Land Use designation. The Site Plan is currently under review in which the interaction of the Riparian Trail and the entrance to the development will have to enable safe pedestrian access across WHCR that currently is not depicted on the Site Plan.

Parking exists mostly between the buildings and near the entrance/ southeastern portion of the site. There are carports totaling 120 of the proposed 342 total spaces or roughly 35% of the overall. The total required parking for the site is 308 spaces. The UDC parking requirements do not have a maximum parking requirement for multi-family developments. Figure 3 depicts updated carports with pitched roofs and asphalt shingles similar to the proposed buildings.

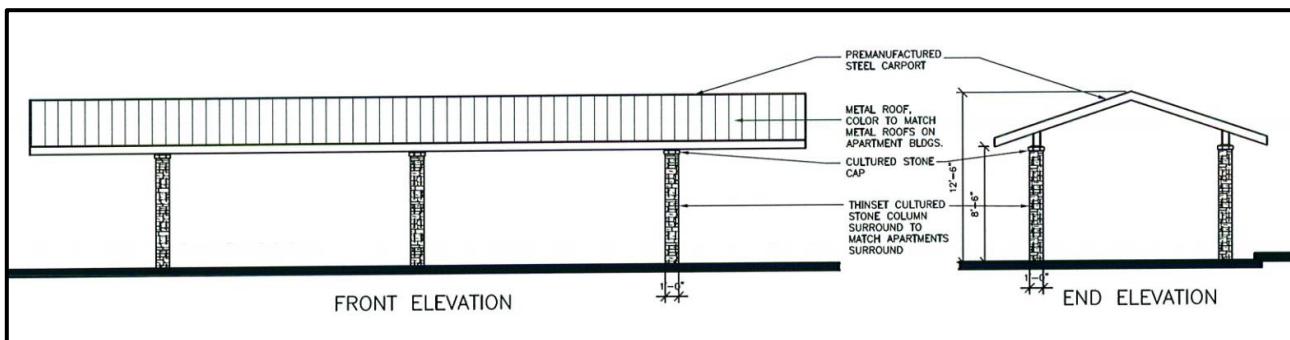


Figure 3: Carport

Given the proximity within the Urban Core and the emphasis of pedestrian connectivity, the Board gave direction during the July ARB meeting that the front entry to the proposed development should be celebrated to create a stronger sense of place, with a specific focus on the connection from Wild Horse Creek Road.

The front entrance has now shifted to the west. The current entrance on the Site Plan does not show pedestrian infrastructure along the entranceway. Where the front entry previously existed is an 8' wide sidewalk. An area of stamped concrete is present at the terminus of the walkway at the front of building two, to provide traffic calming and facilitate the pedestrian movement from WHCR into the development.

C. Topography and Retaining Walls

The site generally consists of one large hill in which there will be an abundance of cut and fill required with the project. There will be multiple retaining walls within this project, some of which will be quite prominent and in the general public's viewpoint when traveling along WHCR and OCR.

Figure 4 to the right demonstrates the current grade of the site. There is approximately anywhere from 28' to 68' in grade change from the perimeter boundaries to the hill's apex. The proposal is to lower the grade of the center of the site creating a flattened area with a finished grade for the parking and structures, which is roughly in between 522'-528'. Every side will have a retaining wall present.

The most visible retaining walls will be a triple tiered mosaic block. Along WHCR there is a mosaic wall with a maximum height of 5'. There is also a triple tiered mosaic block retaining wall along OCR with a maximum height of 21'5" (max tier 7'). An example of the mosaic retaining wall can be seen in Figure 5 to the right. The northwest and northeast corners of the site will contain a standard versa-lok retaining wall with a maximum height of 19' located along the tree preservation area. The retaining walls will be constructed of modular block with a stone type finish that will be similar to the stone of the buildings.



Figure 4: Current Site Grade



Figure 5: Mosaic Retaining Wall

General Requirements for Building Design:

This request is to allow for development of two apartment buildings containing a total of 176 units. Other significant features within the site include a clubhouse, pool, cabana, maintenance building with carwash, trash compactor with recycle center, and multiple carport structures.

D. Scale, Design, Materials, and Color

The maximum building height for any building is 60' 10" and that height occurs on building 2. Generally the buildings are 4 stories in height and 58' tall. All of the buildings contain pitched roofs. The building facades employ horizontal banding and material change. Balcony elements and other building offsets occur at each unit, which allows for visual breaks along the building elevations.

The exterior materials for most structures consist of thin set manufactured stone veneer, cementitious fiber siding, stucco board siding, vinyl shutters and roofs consisting of architectural asphalt shingles. The applicant's color palette has changed throughout submittals and updated samples can be seen in the physical packet. A more detailed look at the reasoning or intent behind the color use can be located in the color scheme section of the applicant's attached packet.

Color elevations are attached. Below are two prominent elevations from Building 1 that will be seen from both WHCR and OCR that exhibit the scale, design, materials, and color referenced above. Each building elevation is consistent in material with variation in color.



Figure 6: Building 1 along WHCR and OCR

E. Multi-Family Architecture

Section 04-01 of the UDC includes specific requirements for multi-family architecture.

Provide an on-site pedestrian system with access to common ground areas – The buildings include sidewalks that connect each building, BBQ area, trash area, and pool area. Additionally, connections are proposed to allow for access to sidewalks along WHCR and OCR.

Express architecturally the individual dwelling units within the building – The proposal includes recessed balconies which help emphasize the individual units within the building.

Utilize color, material, and plane changes to articulate facades. Avoid monotonous or institutional designs – As discussed on pages 5-6, the proposal includes color and material changes to avoid a monotonous design.

Provide functional recreation areas – Integrated among the site are a pool and cabana area, a pocket park, pet park, and BBQ area for gathering.

Provide outdoor space for each dwelling – In addition to common areas, balconies are provided. The balconies provide outdoor space for each unit and also add an element of depth to the proposed buildings.

Provide visual transitions between the street and the dwelling units – Inclusion of heavy buffering provides a break between the residential units and the street. Additionally, sidewalk and landscape areas are provided between the building and parking lot to provide this visual transition.

Primary building material - Primary building material shall be extended and installed so that no more than twelve (12) inches of concrete foundation wall is exposed.

F. Landscape Design, Screening, and Amenities

Several different areas of landscaping are proposed in accordance with City Code requirements. These include street trees along the site's frontage, a 30-foot landscape buffer along WHCR and OCR, and landscaping within the parking lot. Additionally, north of WHCR is the proposed Art Installation which is heavily decorated with small plantings. Note that to the north and west there is minimal landscaping as this is the entire preservation area.

All mechanical units will be on the ground around the buildings and screened by plantings. The screening of these units was discussed at the July ARB meeting, with the desire to see a more detailed planting palette for the screening. The mechanical units are either in groups of three or six depending on the location of the site. An exhibit of the revised screening can be seen in Figure 7. The plantings generally consist of Hibiscus, Rose Glow Barberry, and Emerald Arborvitae varieties.

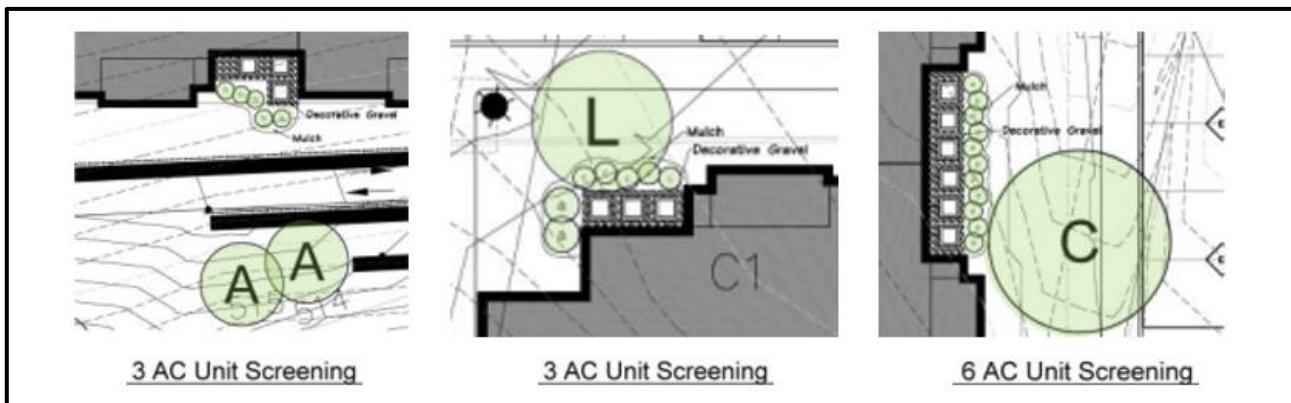


Figure 7: Mechanical Screening

The updated Site Plan includes two park features. In the south central area of the site is a pocket park just north of WHCR and on the eastern edge of the site is a pet park just west of OCR. The pocket park is roughly 850 square feet and the pet park is roughly 1,750 square feet. Both parks will have fencing around them similar to the fencing on the top of the retaining walls. An example picture of the fencing is included in the ARB packets. The BBQ area is directly to the west of the pocket park. The public art is positioned directly south of the pocket park. The 8' pedestrian path is directly east of the pocket park.

Below in Figure 8 is a detail of the pocket park with call outs that lead to expanded details of both the BBQ area, and proposed public art.

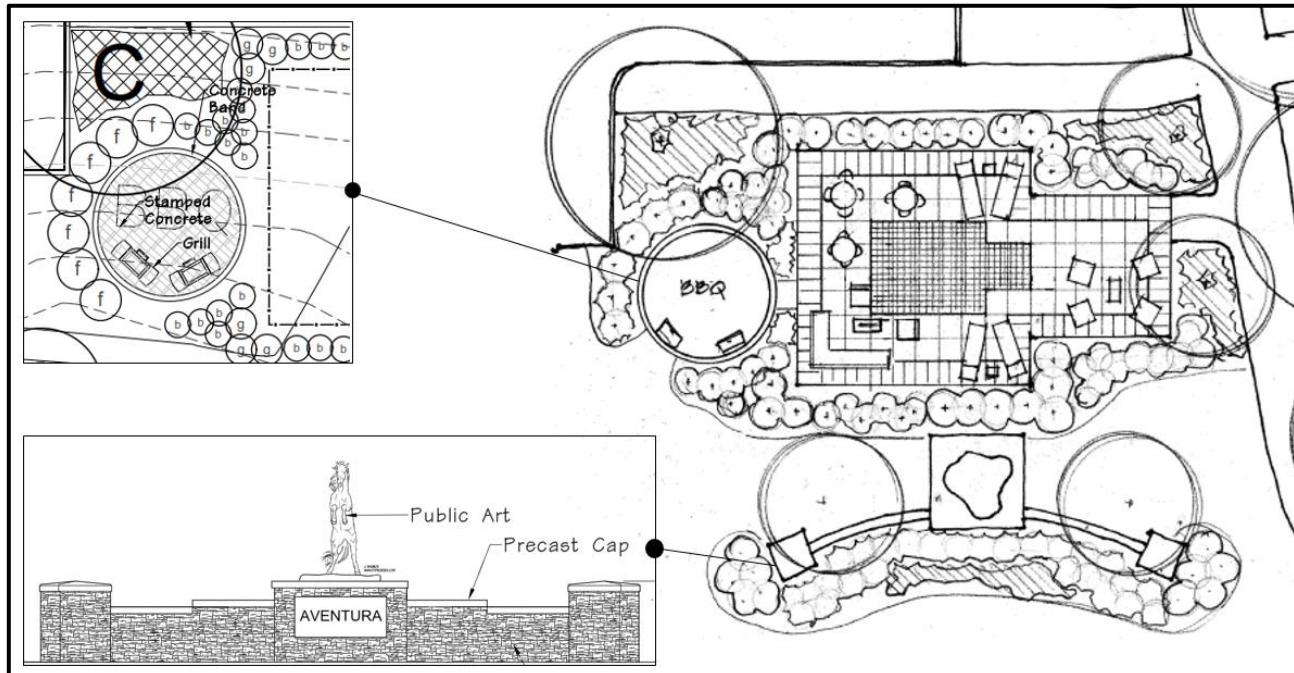


Figure 8: Pocket Park, BBQ, and Public Art

G. Lighting

All of the lighting proposed within this submittal is utilitarian in nature. There are 117 proposed fixtures for the site and roughly 70% of the proposed fixtures are either parking lighting or carport lighting. Each fixture is of a black finish except for the carport fixture which will be white. All of the proposed lighting is fully shielded and flat lensed.

Figure 9 below is a comprehensive look of all proposed fixtures and their general placement throughout the site. There are additional street lights along OCR and WHCR beyond this image including alongside the proposed trail shelter. The entire lighting plan is attached within the packet.



Figure 9: Lighting

DEPARTMENT INPUT

Be advised, this project is still going through development review by City Staff and will not proceed with approval until all outstanding items have been addressed.

Staff requests review and recommendation on this submittal for Aventura at Wild Horse Creek (Above All Development).


MOTION

The following options are provided to the Architectural Review Board for consideration relative to this application:

- 1) "I move to forward the Site Plan, Landscape Plan, Lighting Plan, Architectural Elevations and Architect's Statement of Design for Aventura at Wild Horse Creek (Above All Development), as presented, with a recommendation for approval (or denial) to PPW."
- 2) "I move to forward the Site Plan, Landscape Plan, Lighting Plan, Architectural Elevations and Architect's Statement of Design for Aventura at Wild Horse Creek (Above All Development) to PPW with the following recommendations..."

Attachments

1. Architectural Review Packet Submittal

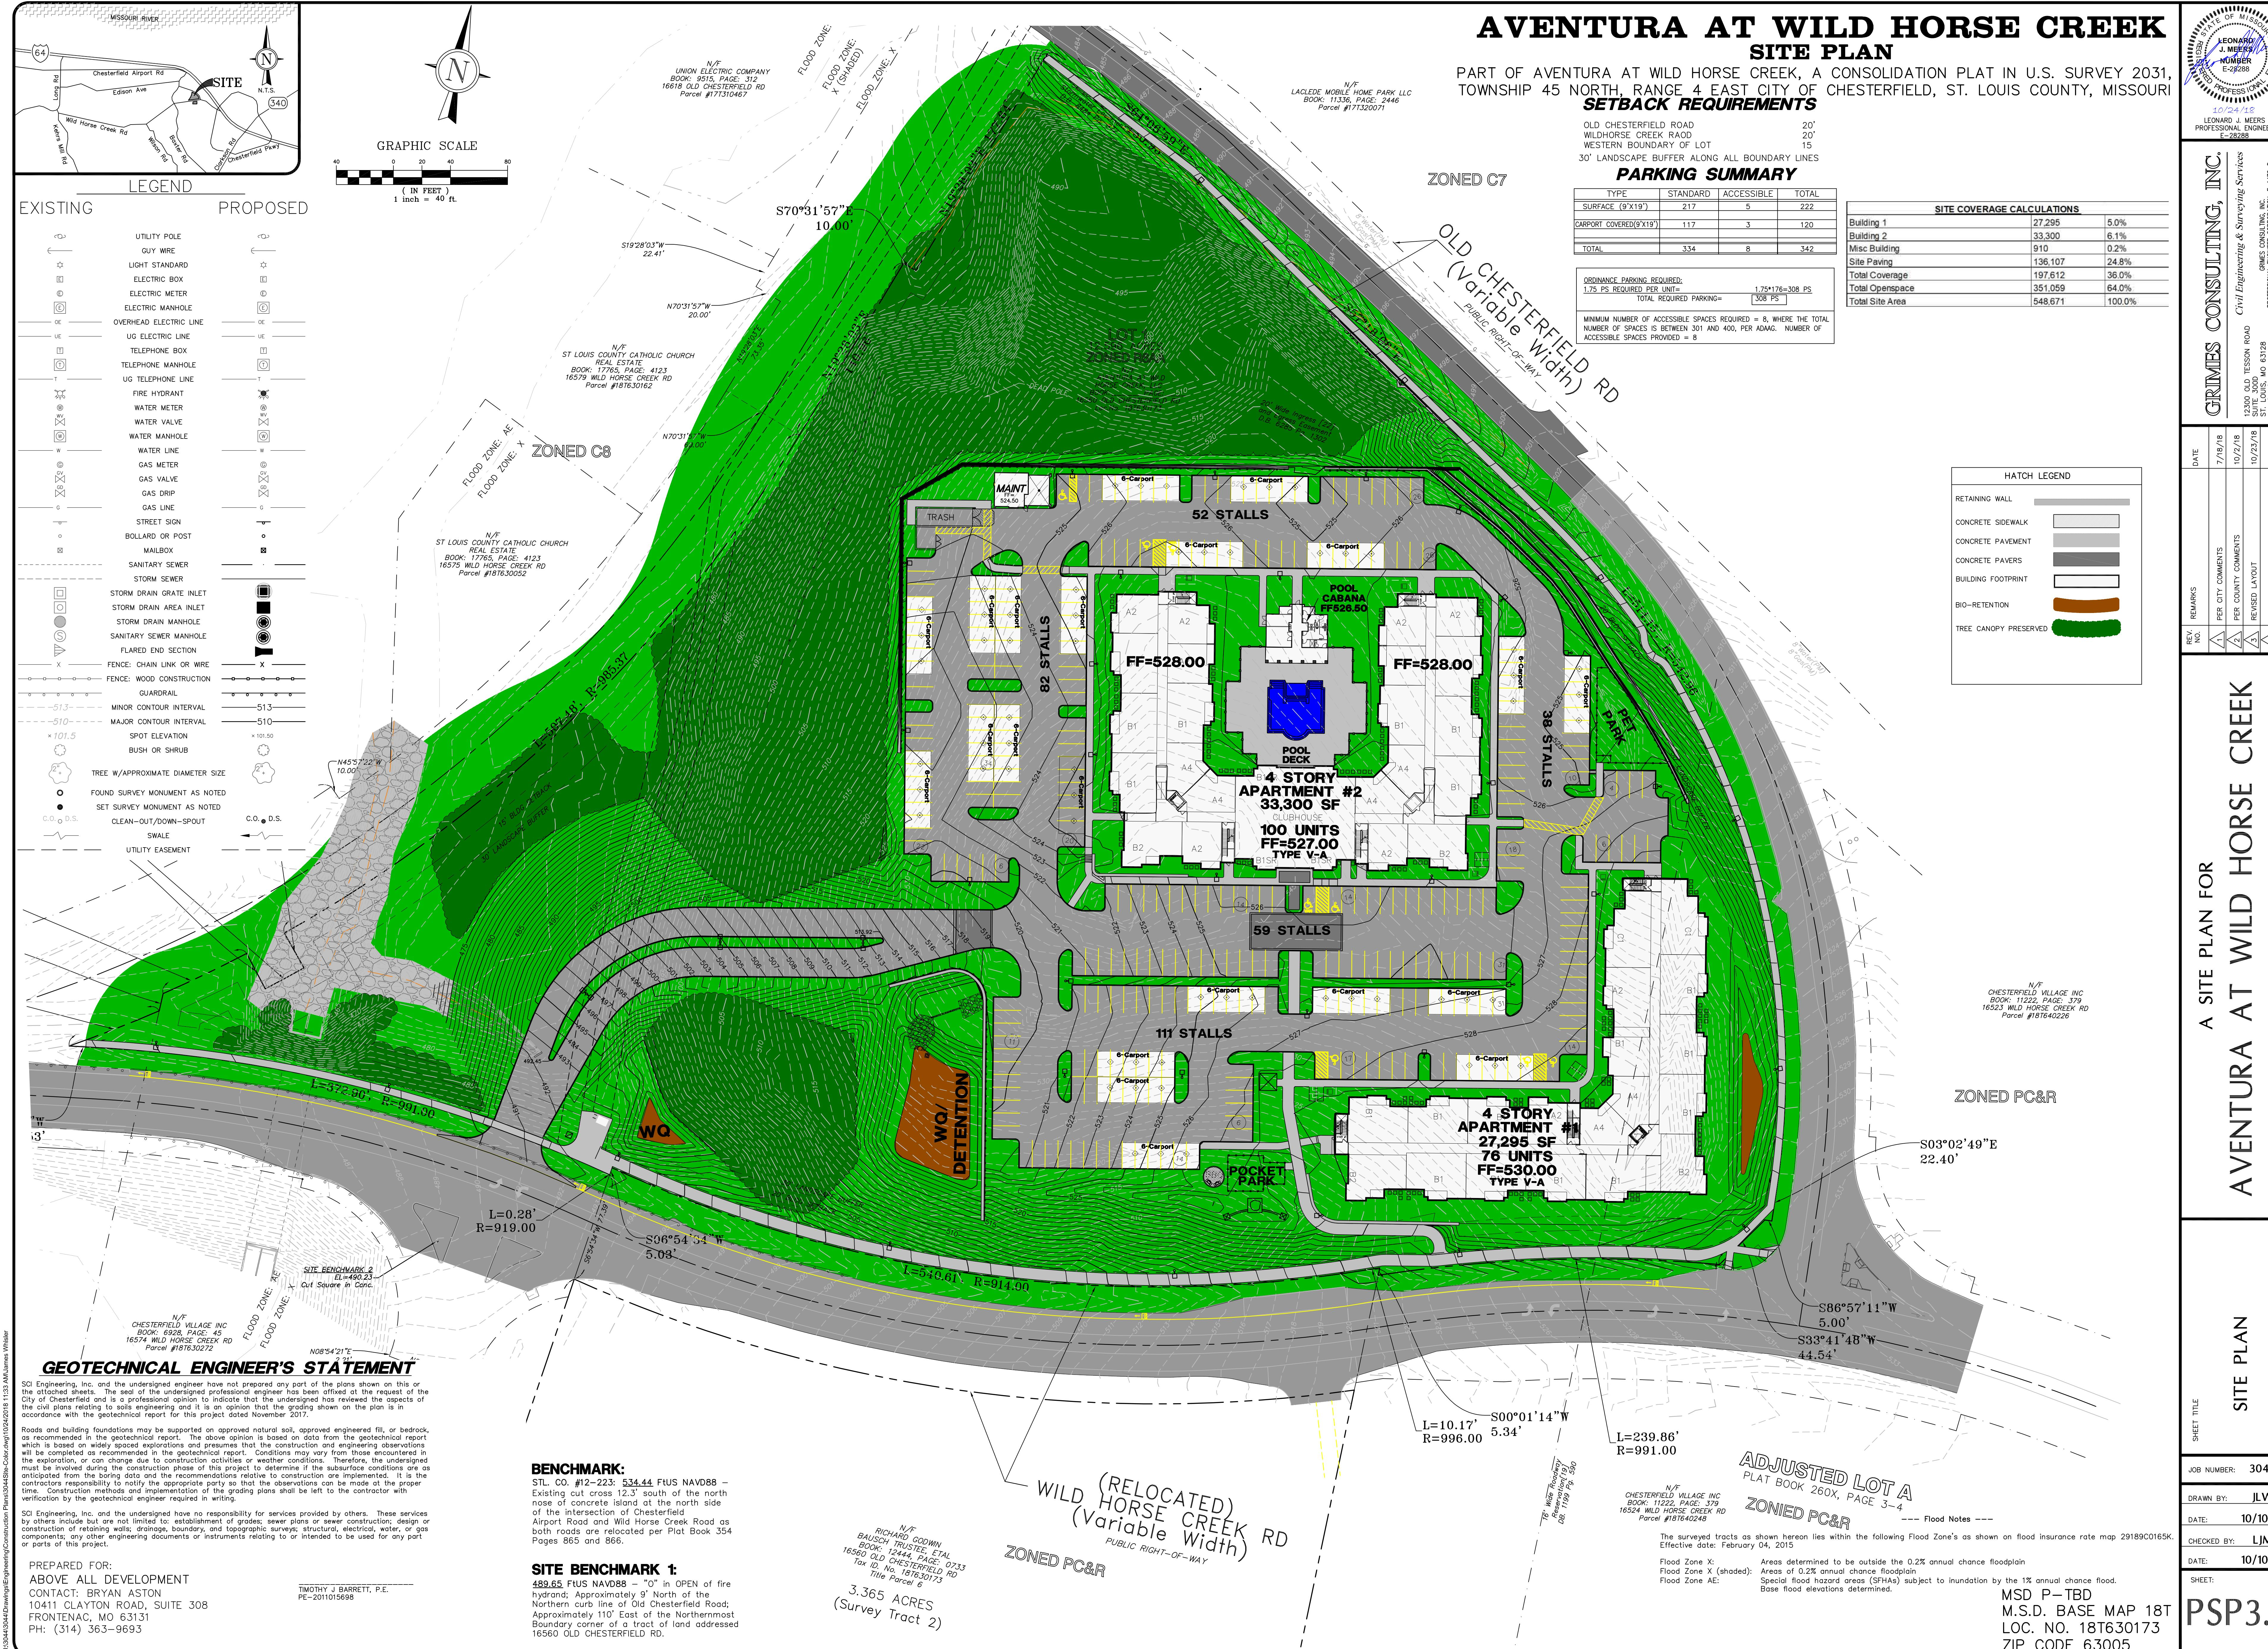





2 BUILDING TWO - SOUTH ELEVATION



1 BUILDING TWO - EAST ELEVATION

TRIM COLOR
PRAIRIE WINDS
PPG: 1111-1

ROOF COLOR
SHINGLE
MFTR: CERTAINTEED


METAL STANDING SEAM
MFTR: OTHERS
COLOR: TBD

STONE
MFTR: STONECRAFT







1 BUILDING ONE – WEST ELEVATION
3/32" = 1'-0"

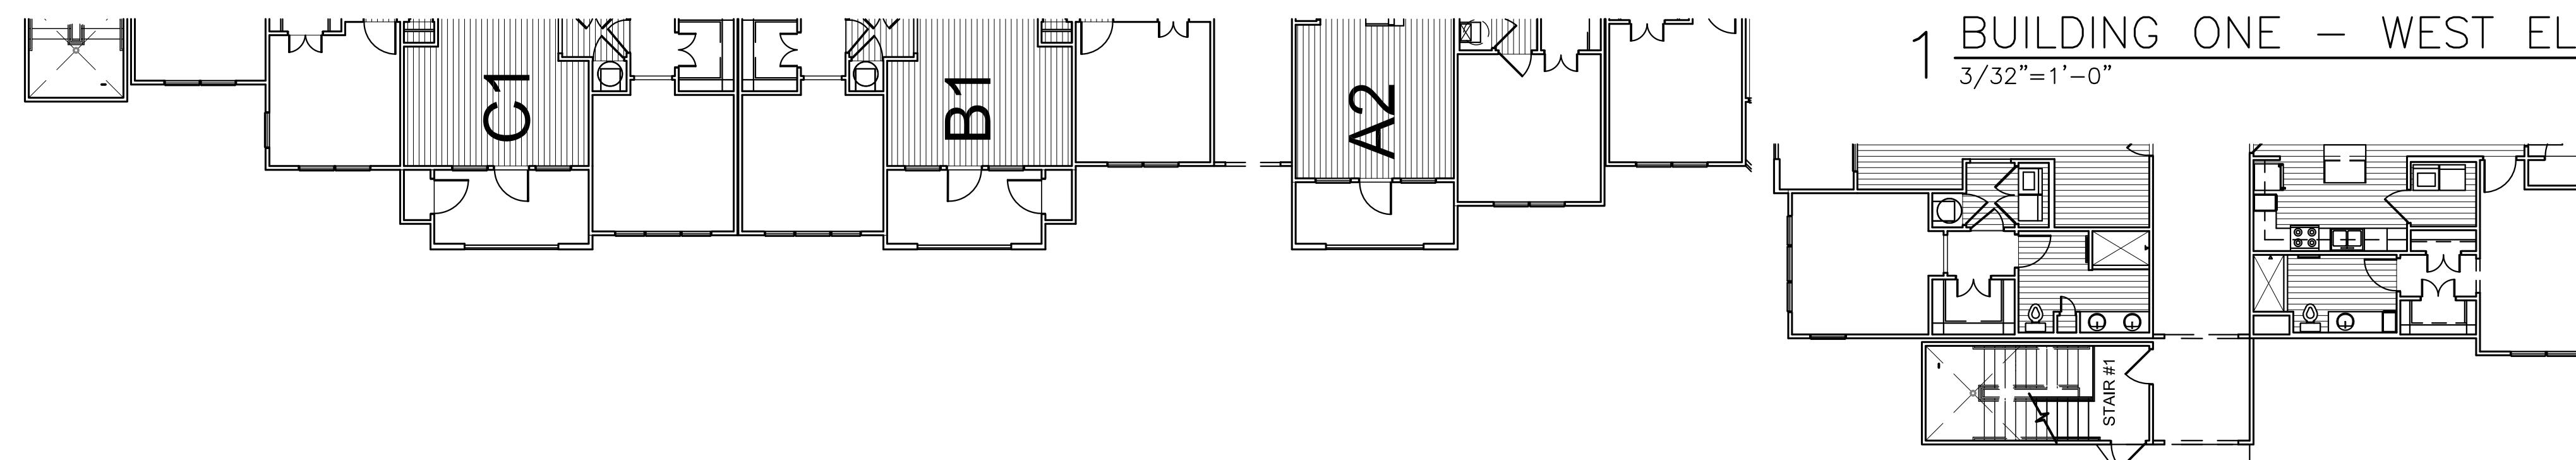

2 BUILDING ONE – NORTH ELEVATION

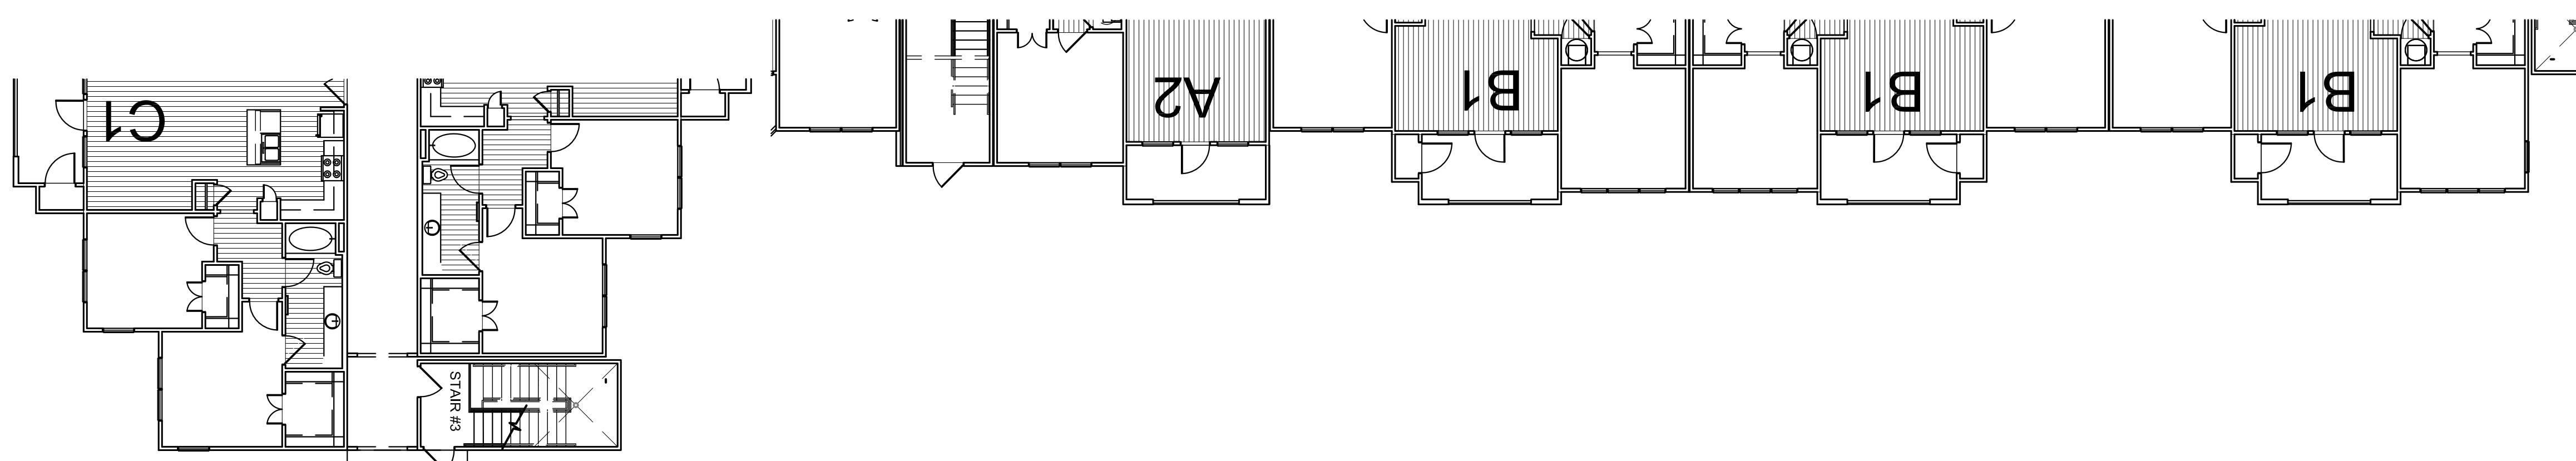


KEYNOTES

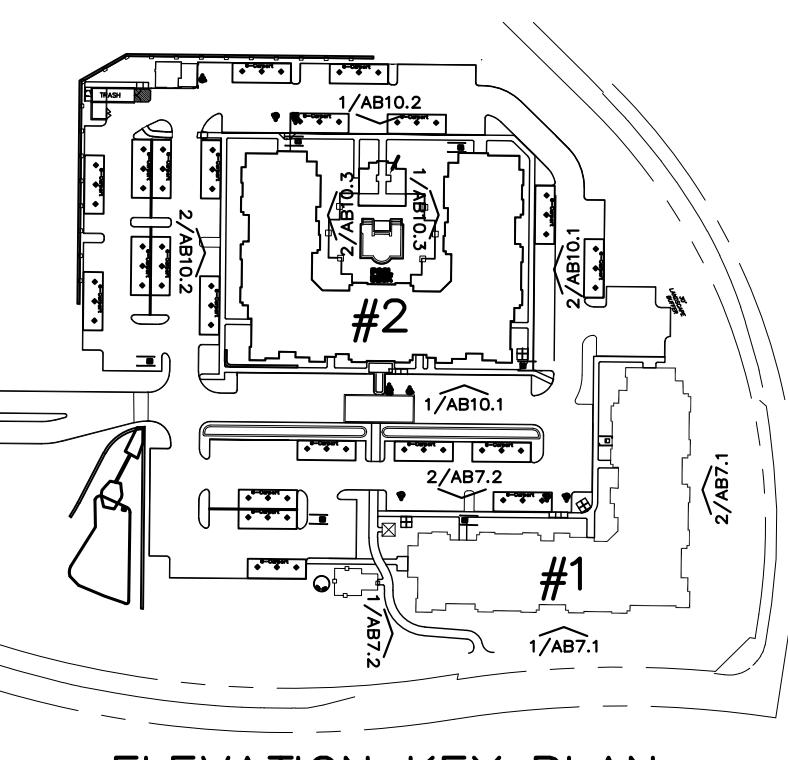

Aventure at Wild Horse Creek

a at Wild Hors

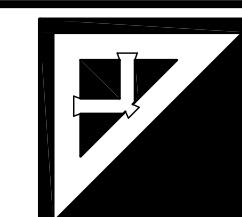

Digitized by srujanika@gmail.com

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2202 E. 49th Street, Suite 200
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918-742-2485

918-742-2463
RYAN HULST - ARCHITECT OF RECORD
MISSOURI LICENSE A-2015013986

Aventura at Wild Horse Creek, LLC

10411 CLAYTON RD., STE. 308
ST. LOUIS, MO 63131
PH 314-363-9693

DB NUMBER: 21801
DRAWN BY: SL,H
ATE: 4/5/18


WIRING DIAGRAMS

BUILDING ONE ELEVATIONS


EET
MBER AB7.2 OF 11




KEYNOTES

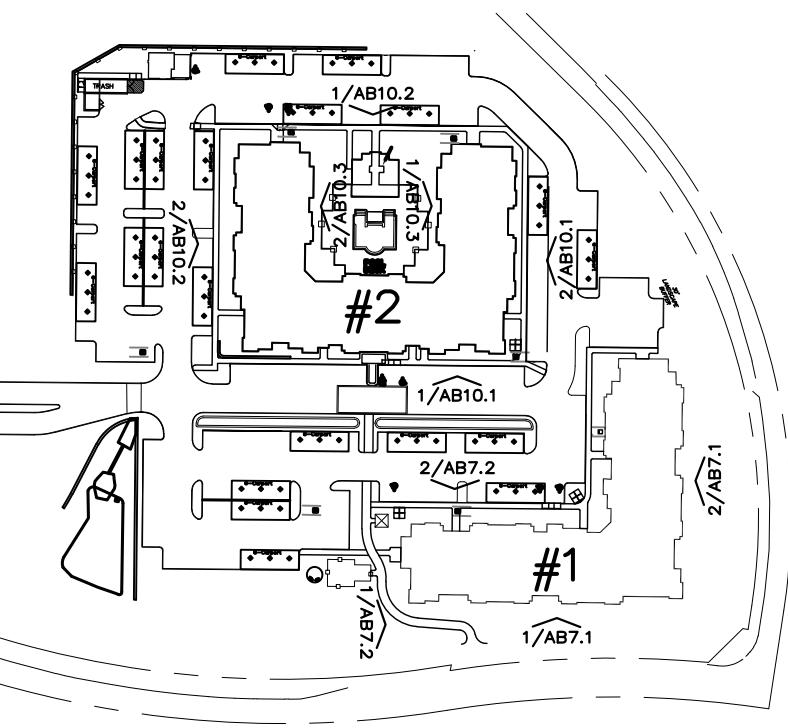

Aventura at Wild Horse Creek
Chesterfield, Missouri

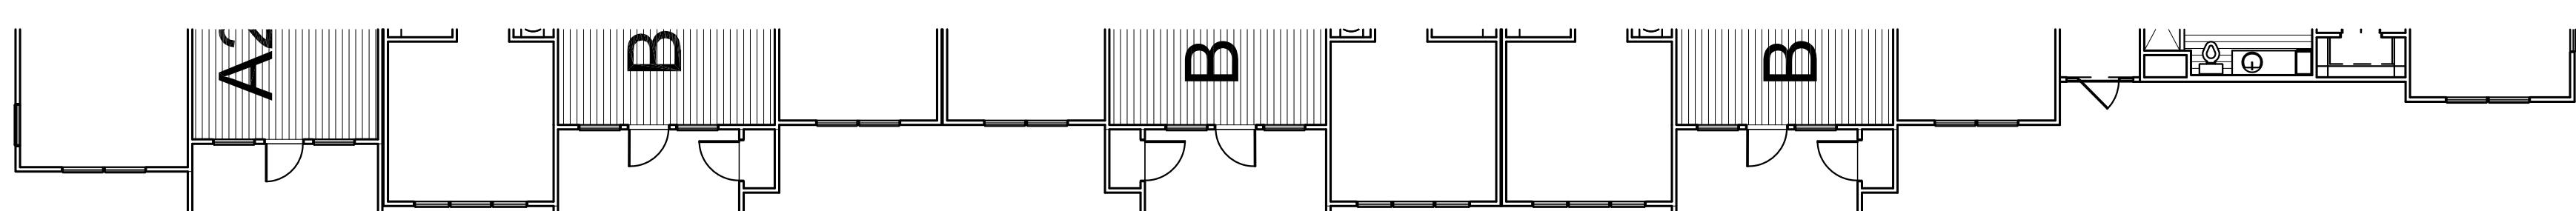

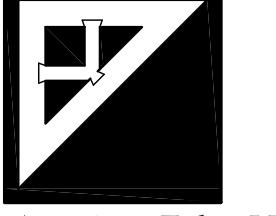
Aventura at Wild Horse Creek, LLC
Parker Associates Tulsa, LLC
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Tulsa, Oklahoma 74105
918-442-2465
BRYAN HULLS, ARCHITECT OF RECORD
MISSOURI LICENSE A-2015013986


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DRAWN BY: SL.HA
DATE: 4/5/18

BUILDING TWO ELEVATIONS



SHEET NUMBER AB10.2 OF 11




1 BUILDING TWO – EAST COURTYARD ELEVATION
3/32"=1'-0"

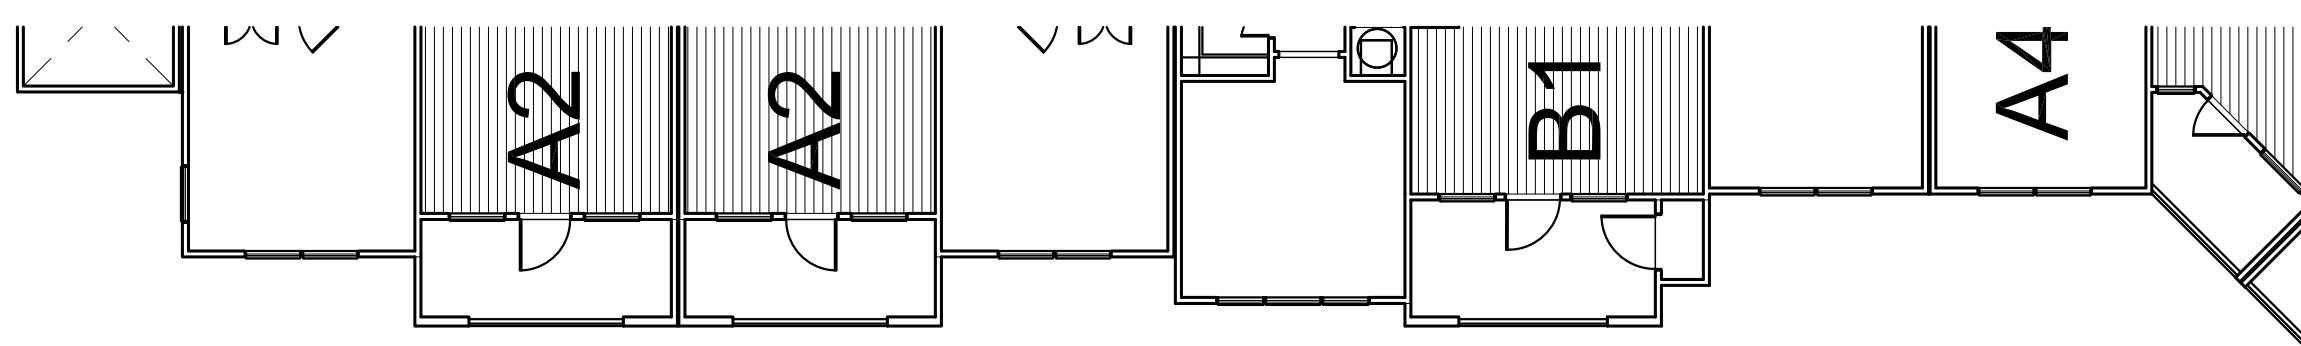

2 BUILDING TWO – WEST COURTYARD ELEVATION
3/32"=1'-0"

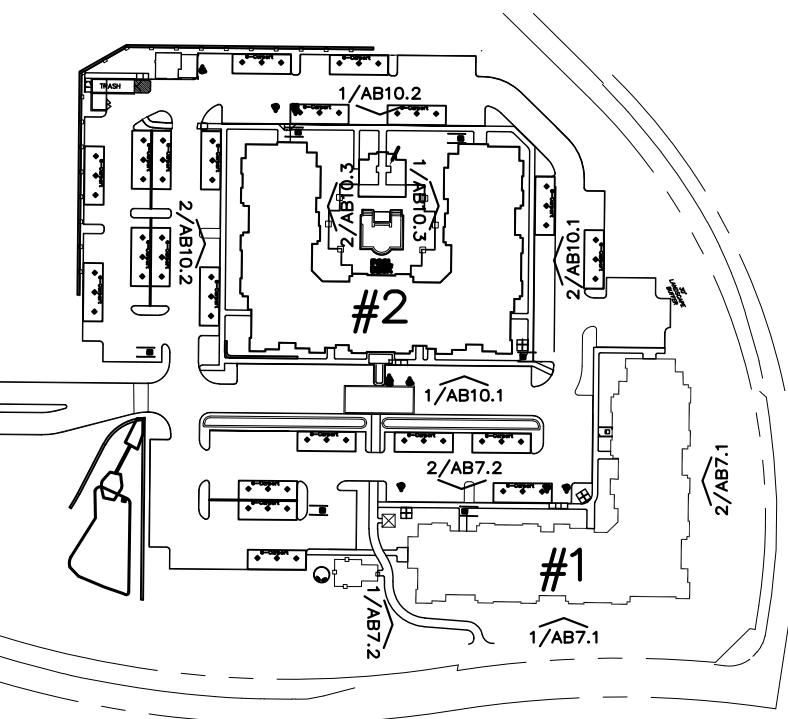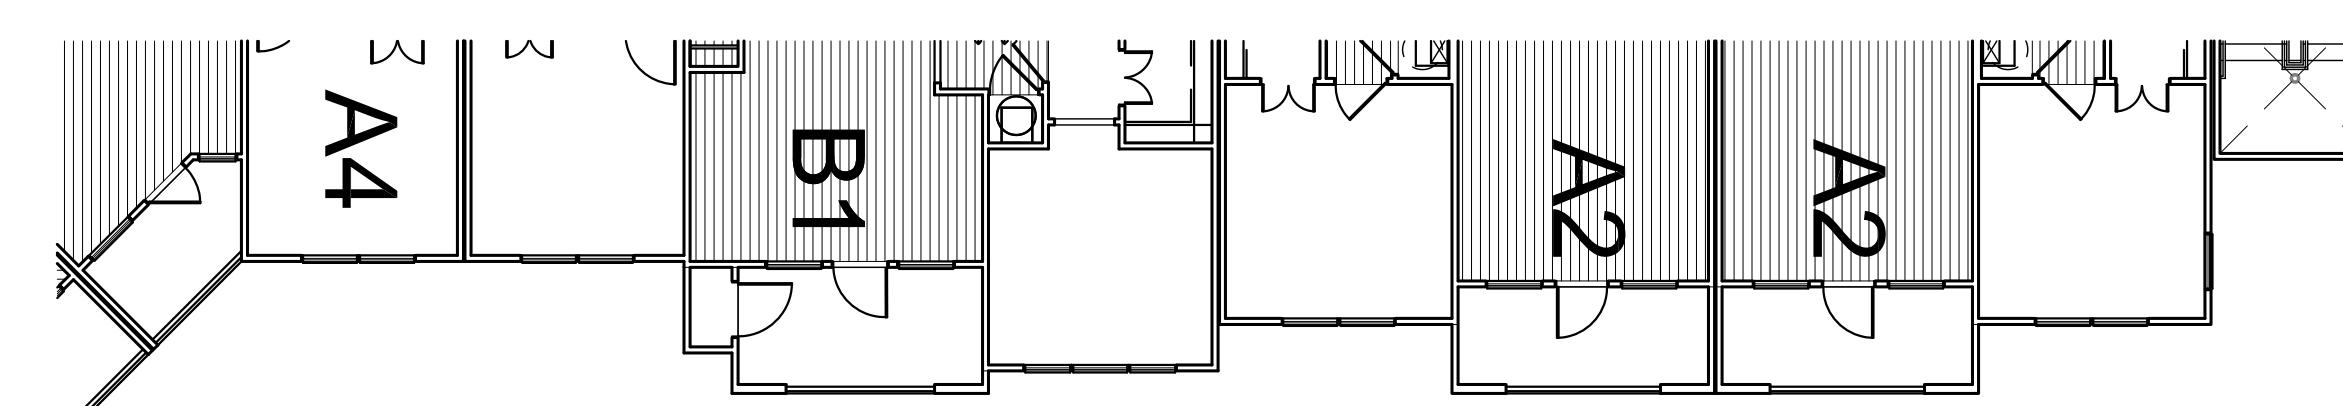

Aventura at Wild Horse Creek
Chesterfield, Missouri

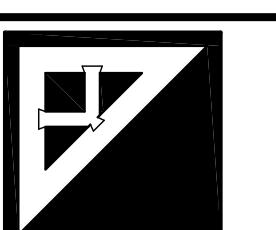


Parker Associates Tulsa, LLC
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MISSOURI LICENSE #A-2015013986
JOB NUMBER: 218011
DRAWN BY: SL.HA
DATE: 4/5/18

BUILDING TWO ELEVATIONS

SHEET NUMBER AB10.3 OF 11




TRIM COLOR PRAFIE WINDS PPG: 1111-1
ROOF COLOR SHINGLE MNFR: CERTAINEED
METAL STANDING SEAM MNFR: OTHERS COLOR: TBD
STONE MNFR: STONECRAFT

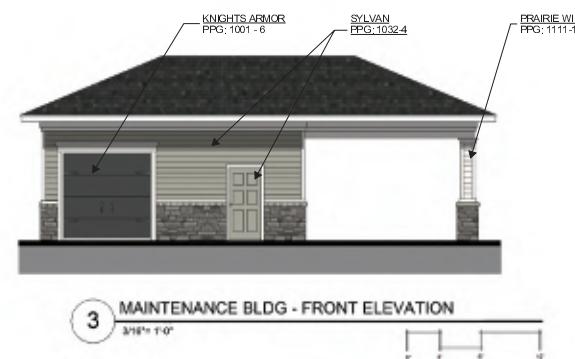


Parker Associates Tulsa, LLC

rosemann
& ASSOCIATES PC

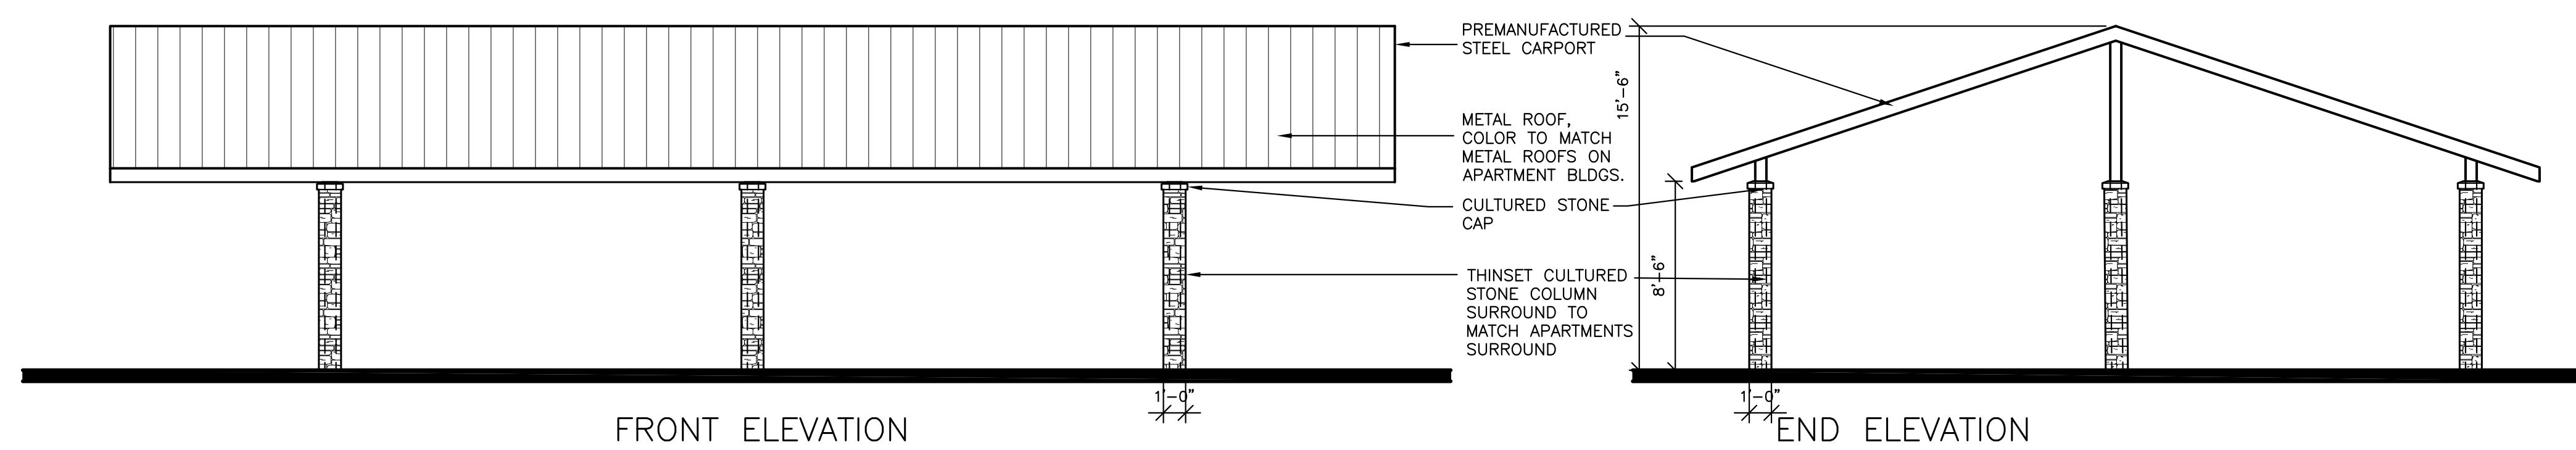


2 TYPICAL DOUBLE BAY CARPORT ELEVATION
 $\frac{3}{16}'' = 1'-0''$

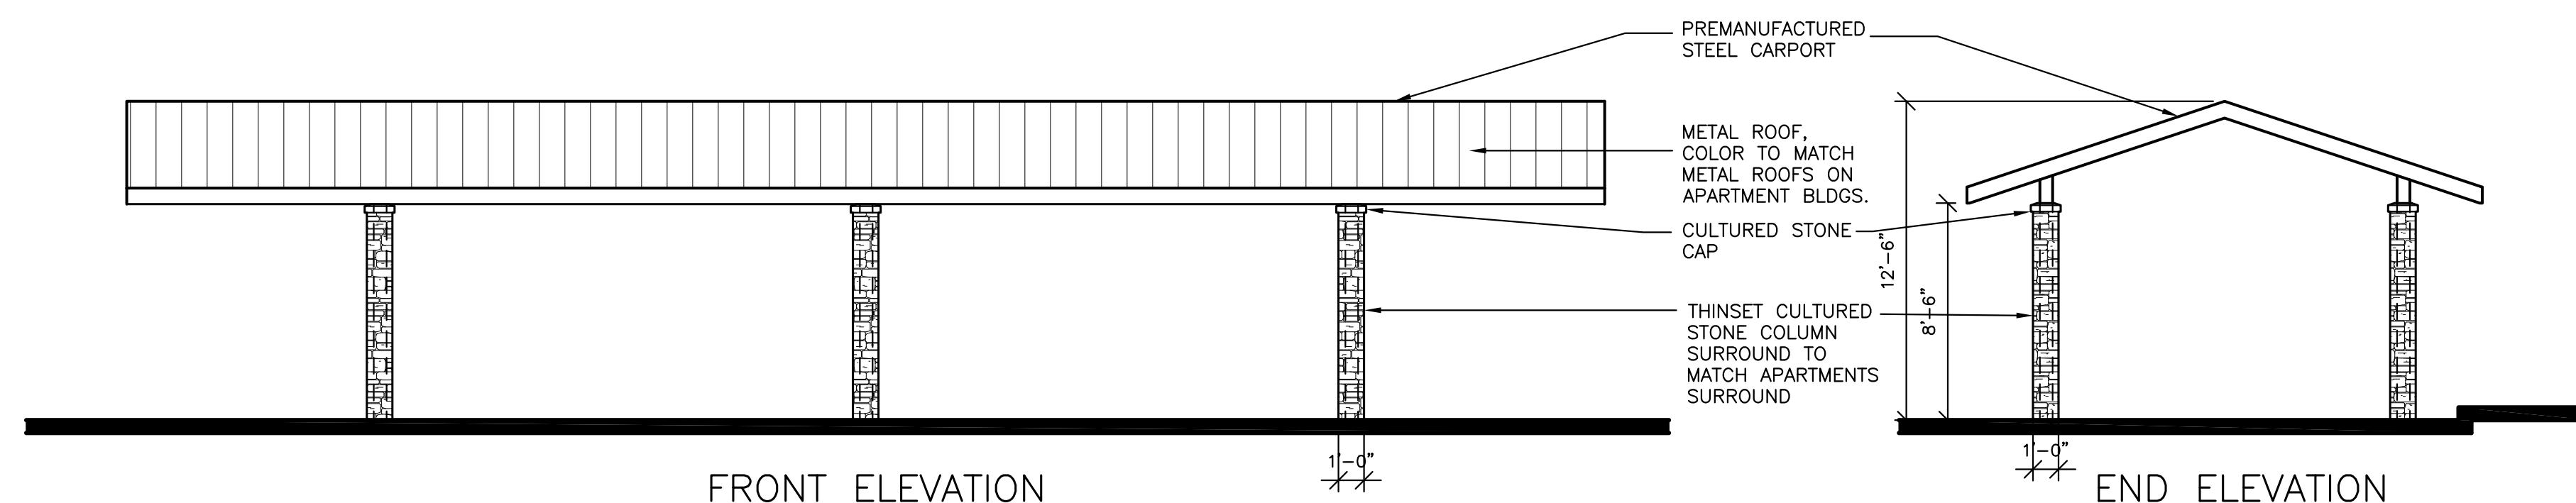

1 TYPICAL SINGLE BAY CARPORT ELEVATION
 $\frac{3}{16}'' = 1'-0''$

Aventura at Wild Horse Creek
 Chesterfield, Missouri

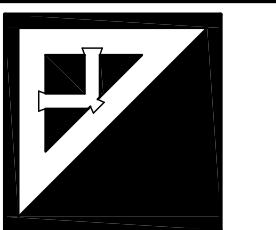

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JOB NUMBER: 218011
 DRAWN BY: SL.HA
 DATE: 4/5/18

CARPORT ELEVATION

SHEET NUMBER SD4 OF 4



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Architect's Statement of Design

10/24/18

Project: Aventura at Wild Horse Creek Apartment Project

Location: Northwest Quadrant of the Wild Horse Creek Road and Old Chesterfield Road Intersection, Chesterfield, MO.

Project Overview:

The project contains two apartment buildings containing a total of 176 units. Site amenities will include the following: Clubhouse that is integral with apartment Building 2, pool, pool cabana, maintenance building with carwash, trash compactor with recycle center, and carport structures.

Site Access:

The site has one point of access off Wild Horse Creek Road. The boulevard entry drive aligns with an existing curb cut across from Burkhardt Place. The parking is generally centralized in the interior of the site and loops around Building 2 which allows for improved traffic flow. Apartment buildings and landscape berms screen the majority of the parking from the adjacent public right of ways. The parking area located at the northwest part of the site will be screened from off-site traffic by a substantial existing tree line. There is a public sidewalk along both public roads. The sidewalk at Wild Horse Creek ties to the interior sidewalks of the site. There is an accessible route that connects all buildings and amenities throughout the site.

Topography:

The existing topography is extensive with over 70' of change with the high point located near the center of the site. The proposal is to lower the grade at the center of the site creating a flattened area for the proposed structures. Even so, there will be the need for retaining walls at the perimeter of the site. The mosaic block retaining wall shown at Building 1 along Wild Horse Creek Road has a maximum height of 5'. The triple tiered mosaic block retaining wall along Old Chesterfield Road has an overall height of 21.5' height (maximum height of each tier is 7'). The standard versa-lok retaining wall at the NW corner of the site and along the bio-retention basin on the west are a maximum of 19' and 12.5' high respectively and are located along the tree preservation area and are screened from the public view. The retaining walls will be constructed of modular block and with a stone type finish that will complement the stone on the Buildings. The retaining walls will be required to be engineered with sealed drawings provided by the supplier.

Building Design:**Scale:**

The proposed apartment buildings are 4-story in height with pitched roofs. The maximum height of Building 1 and 2 is 58' (tower element at building corners). The facades employ horizontal banding and material changes to break up the building height and length which help achieve a sense of human scale. Balcony elements and other building offsets occur at each unit which provides visual breaks and shadow lines along building elevations.

Design:

The buildings incorporate a number of design elements that lend a residential feel to the project. The exterior materials include stone, cementitious stucco board and cementitious horizontal siding. Elements including window shutters, cornice brackets and pitched roofs also give a residential feel. All buildings will be constructed of the same materials. Siding and stucco board areas will employ complementary color schemes including accent colors to visually break up the building scale and to provide interest.

Materials and Colors:

The exterior materials will include thin set manufactured stone, cementitious stucco board, cementitious horizontal siding and stucco which accentuate the club. Colors and sample board will be submitted by the Owner separate from this document.

Landscape Design and Screening:

A landscape design meeting the City standards is submitted separately from this document. Tree and shrubs are planned at the site perimeters as well as around each structure. Heat pump condensers located around the perimeter of the apartment buildings will be screened with shrubbery.

Lighting:

A site lighting plan is submitted separately from this document. The general parking lighting will be provided by LED fixtures that have zero up-light. The clubhouse will have 10 wall mounted decorative fixtures to accentuate the club entry. All site lighting will meet the Lighting Standards as provided for in the Unified Development Code.

Sincerely,



Bryan E. Hulst, AIA
Member



Color Scheme
Aventura at Wild Horse Creek
Above All Development
Revised 10/25/2018

ROOF: CERTAINTEED - DRIFTWOOD

STONE: STONECRAFT - HAMILTON HARITAGE

FASCIAS/GUTTERS: ROLLEX - SHELL

SOFFITS: PROVIA WOODHAVEN - LINEN

BALCONY RAILINGS: PRE-FINISHED WHITE

SHUTTERS: PROVIA SHUTTERS - 018 TUXEDO GREY NS / ANTIQUE WHITE

POOL DECK: H&C ACRYLA - DECK - HC141 CEMENTED DEAL

STAIRS & RAILINGS, METAL CANOPIES

PPG 1007-7 BARK

High Gloss

MAIN ENTRY DOORS

PPG 1081-5 FIRE DUST

High Gloss Latex Finish

TRIM

All Trim, Ceilings, Balcony Doors

PPG 1111-1 PRAIRIE WINDS

Satin Finish

BUILDING 1

SHUTTERS - ANTIQUE WHITE

B1 - SHARKSKIN PPG 1025-4

B2 - KNIGHTS ARMOUR PPG 1001-6

B3 - PRARIE WINDS PPG 1111-1

B4 - ANTELOPE PPG 15-09

Building 2

SHUTTERS - ANTIQUE WHITE/TUXEDO GRAY

B1 - PLUNGE POOL PPG 11-25

B2 - SYLVAN PPG 1032-4

B3 - PRARIE WINDS PPG 1111-1

B4 - KNIGHTS ARMOUR PPG 1001-6

B5 - ANTELOPE PPG 15-09

Pool House/Trash

B1 - SYLVAN PPG 1032-4

B2 - PRARIE WINDS PPG 1111-1

B3 - KNIGHTS ARMOUR PPG 1001-6

Aerial



Surrounding Properties

Wild Horse Creek & Old Chesterfield Rd



Sachs Property



Mobile Home Park



MONTAGE PLUS




ORNAMENTAL STEEL FENCE

Montage Plus ornamental steel fence has the versatility to fit many different project applications. With its ability to traverse varying grades, variety of distinct product styles and unmatched coating performance, Montage Plus is the preferred choice for ornamental fence.



PRIMARY APPLICATIONS

- Commercial Developments
- Self Storage
- Apartments (Multi-Family)
- Parks & Recreation
- Schools & Universities

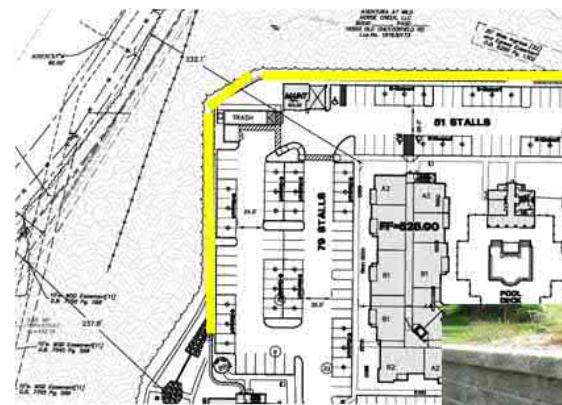

FENCE PRODUCTS

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PROFESSIONAL ENGINEER
NUMBER E-38288
12/23/18
LEONARD J. MEERS
PROFESSIONAL ENGINEER
E-38288

Civil Engineering & Surveying Services
GRIMES CONSULTING, INC.
12200 OLD TESON ROAD
SUITE 200
MO 63128
PH: (314) 849-6100
FAX: (314) 849-6101
www.grimesconsulting.com

A SITE PLAN FOR AVVENTURA AT WILD HORSE CREEK

SITE PLAN


JOB NUMBER: 3044
DRAWN BY: JLW
DATE: 10/10/18
CHECKED BY: LJM
DATE: 10/10/18

SHEET TITLE:
MSD P-TBD
M.S.D. BASE MAP 18T
LOC. NO. 18T630173
ZIP CODE 63005


SHEET:

C3.0

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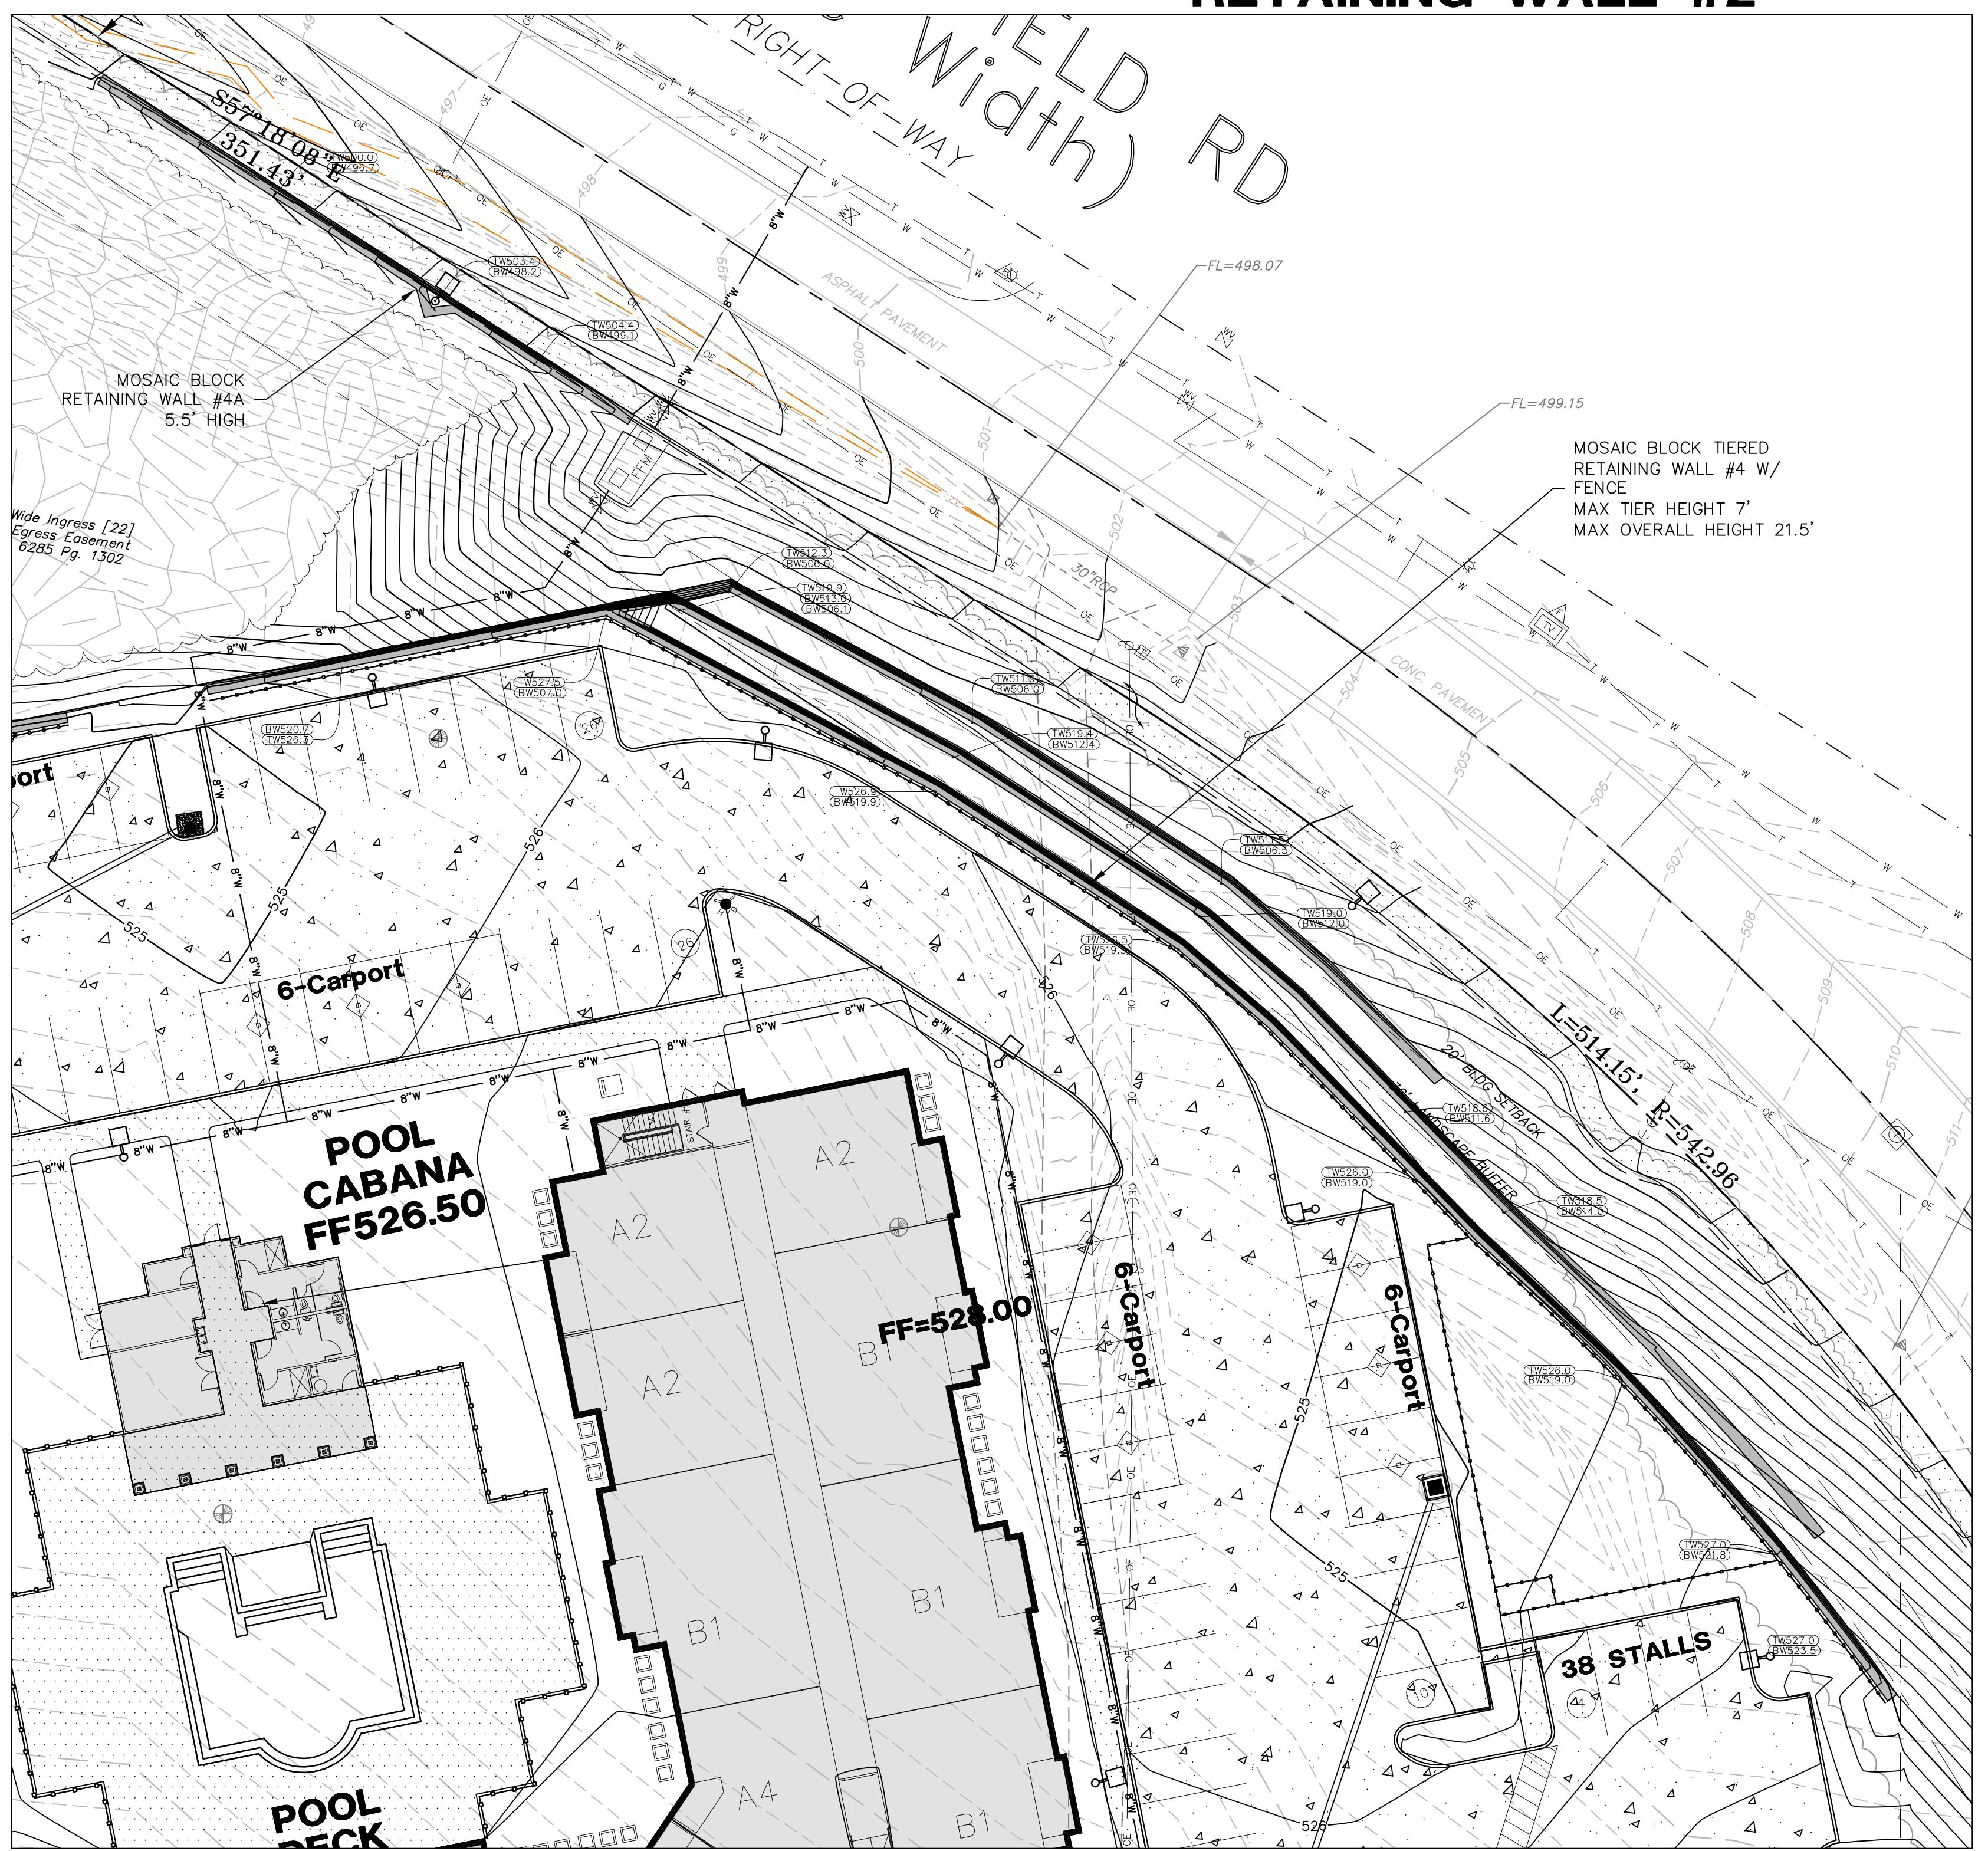
RETAINING WALL #1

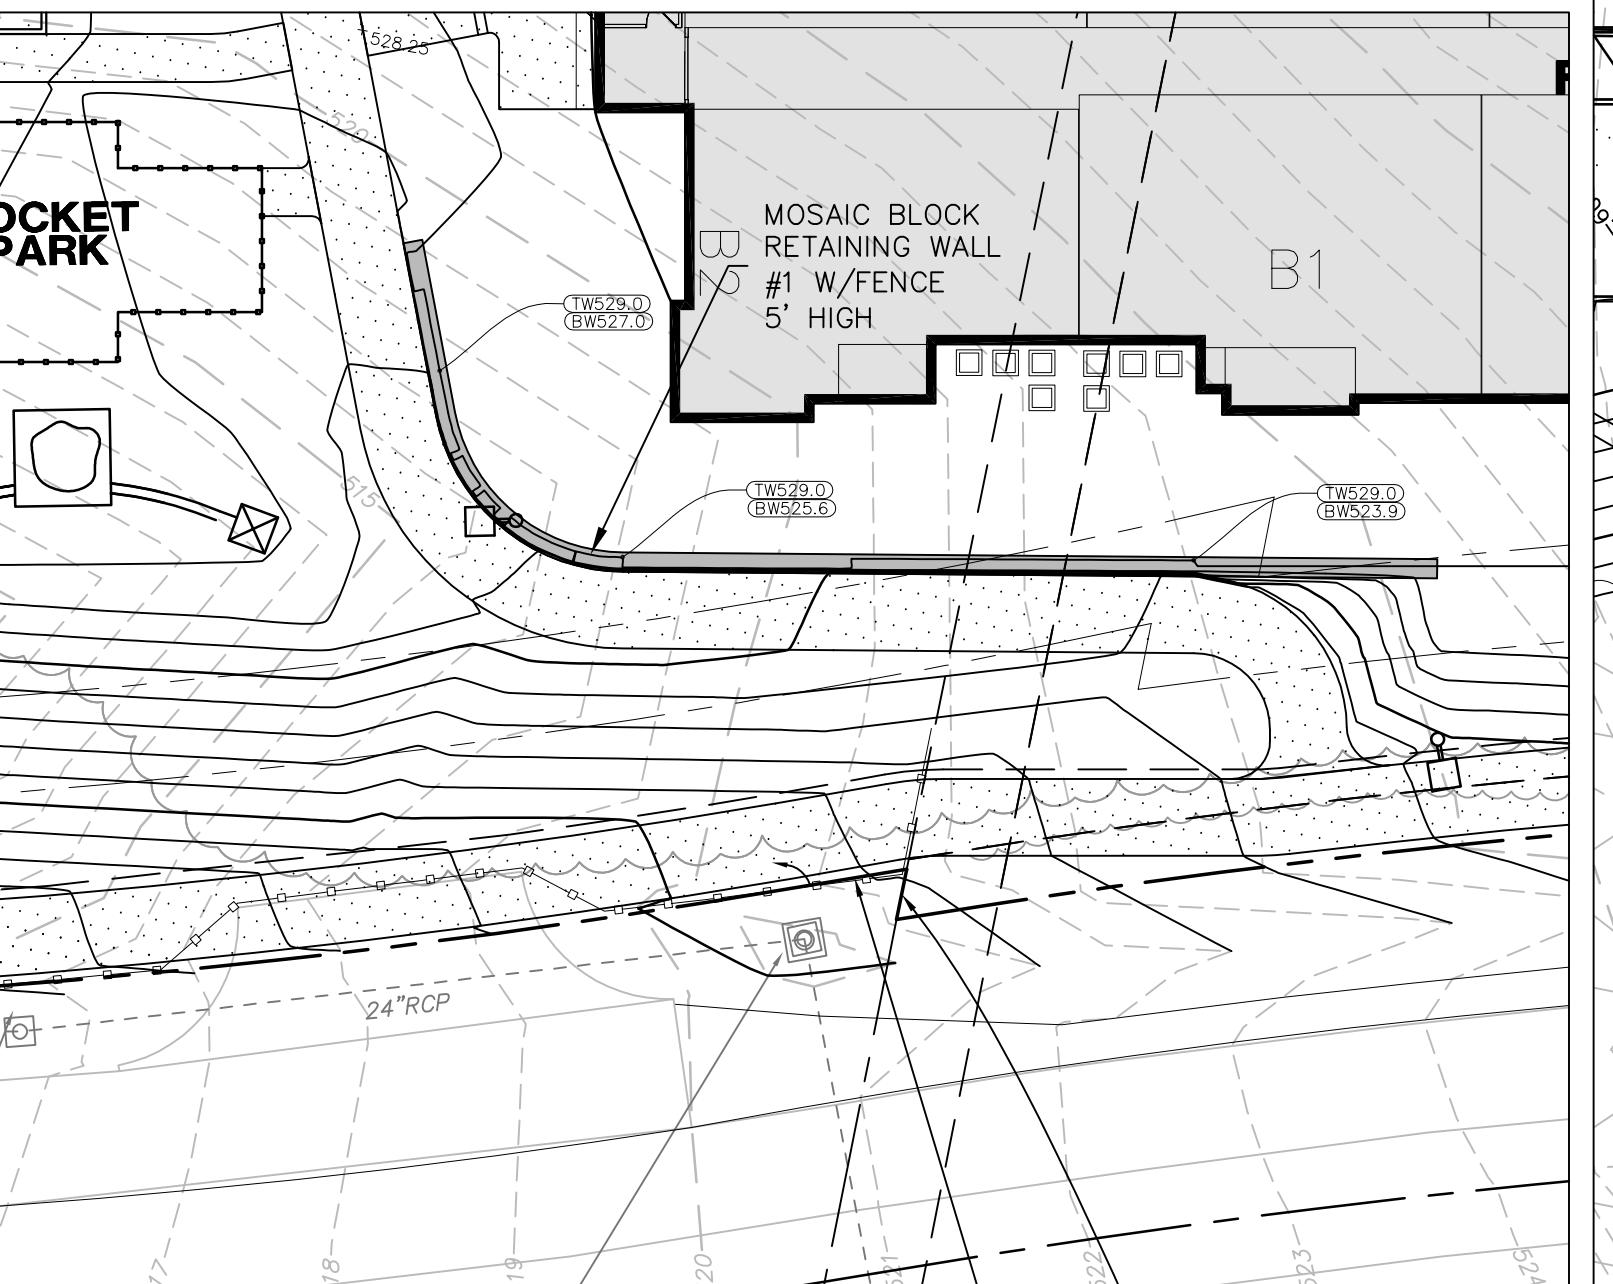

RETAINING WALL #2

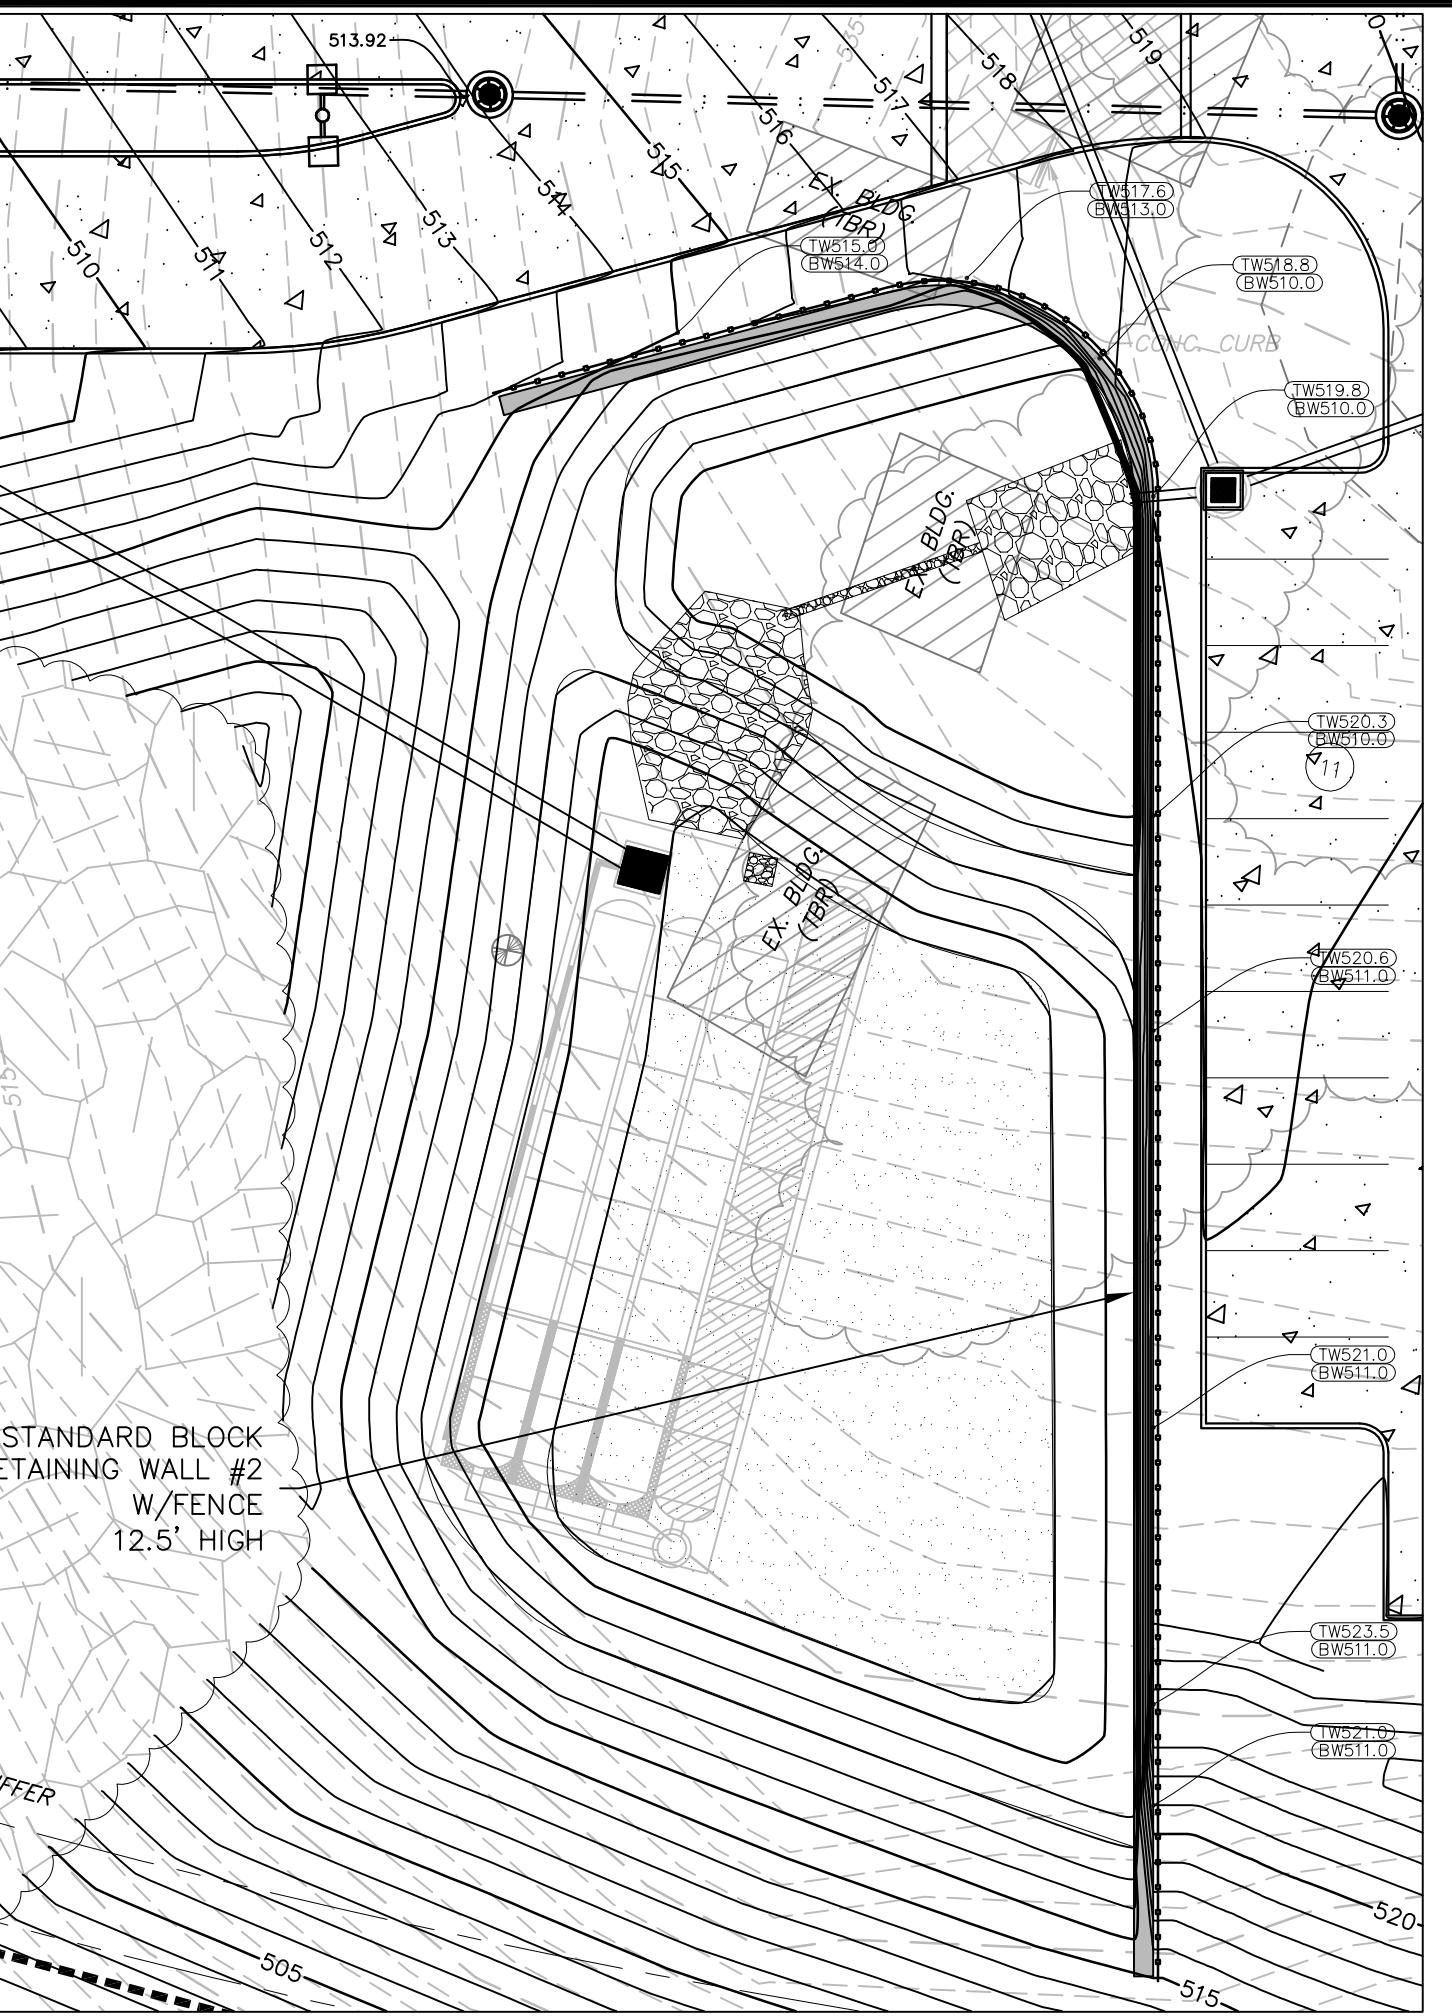

RETAINING WALL #3



RETAINING WALL #4


J:\3044\3044\Drawing\Engineering\Construction Plans\3044 Site.dwg 10/23/2018 10:04 AM James White

PREPARED FOR:
ABOVE ALL DEVELOPMENT
CONTACT: BRYAN ASTON
10411 CLAYTON ROAD, SUITE 308
FRONTENAC, MO 63131
PH: (314) 363-9693



MODULAR BLOCK RETAINING WALL

(SEE RETAINING WALL PLANS BY OTHERS)

5
C2.0

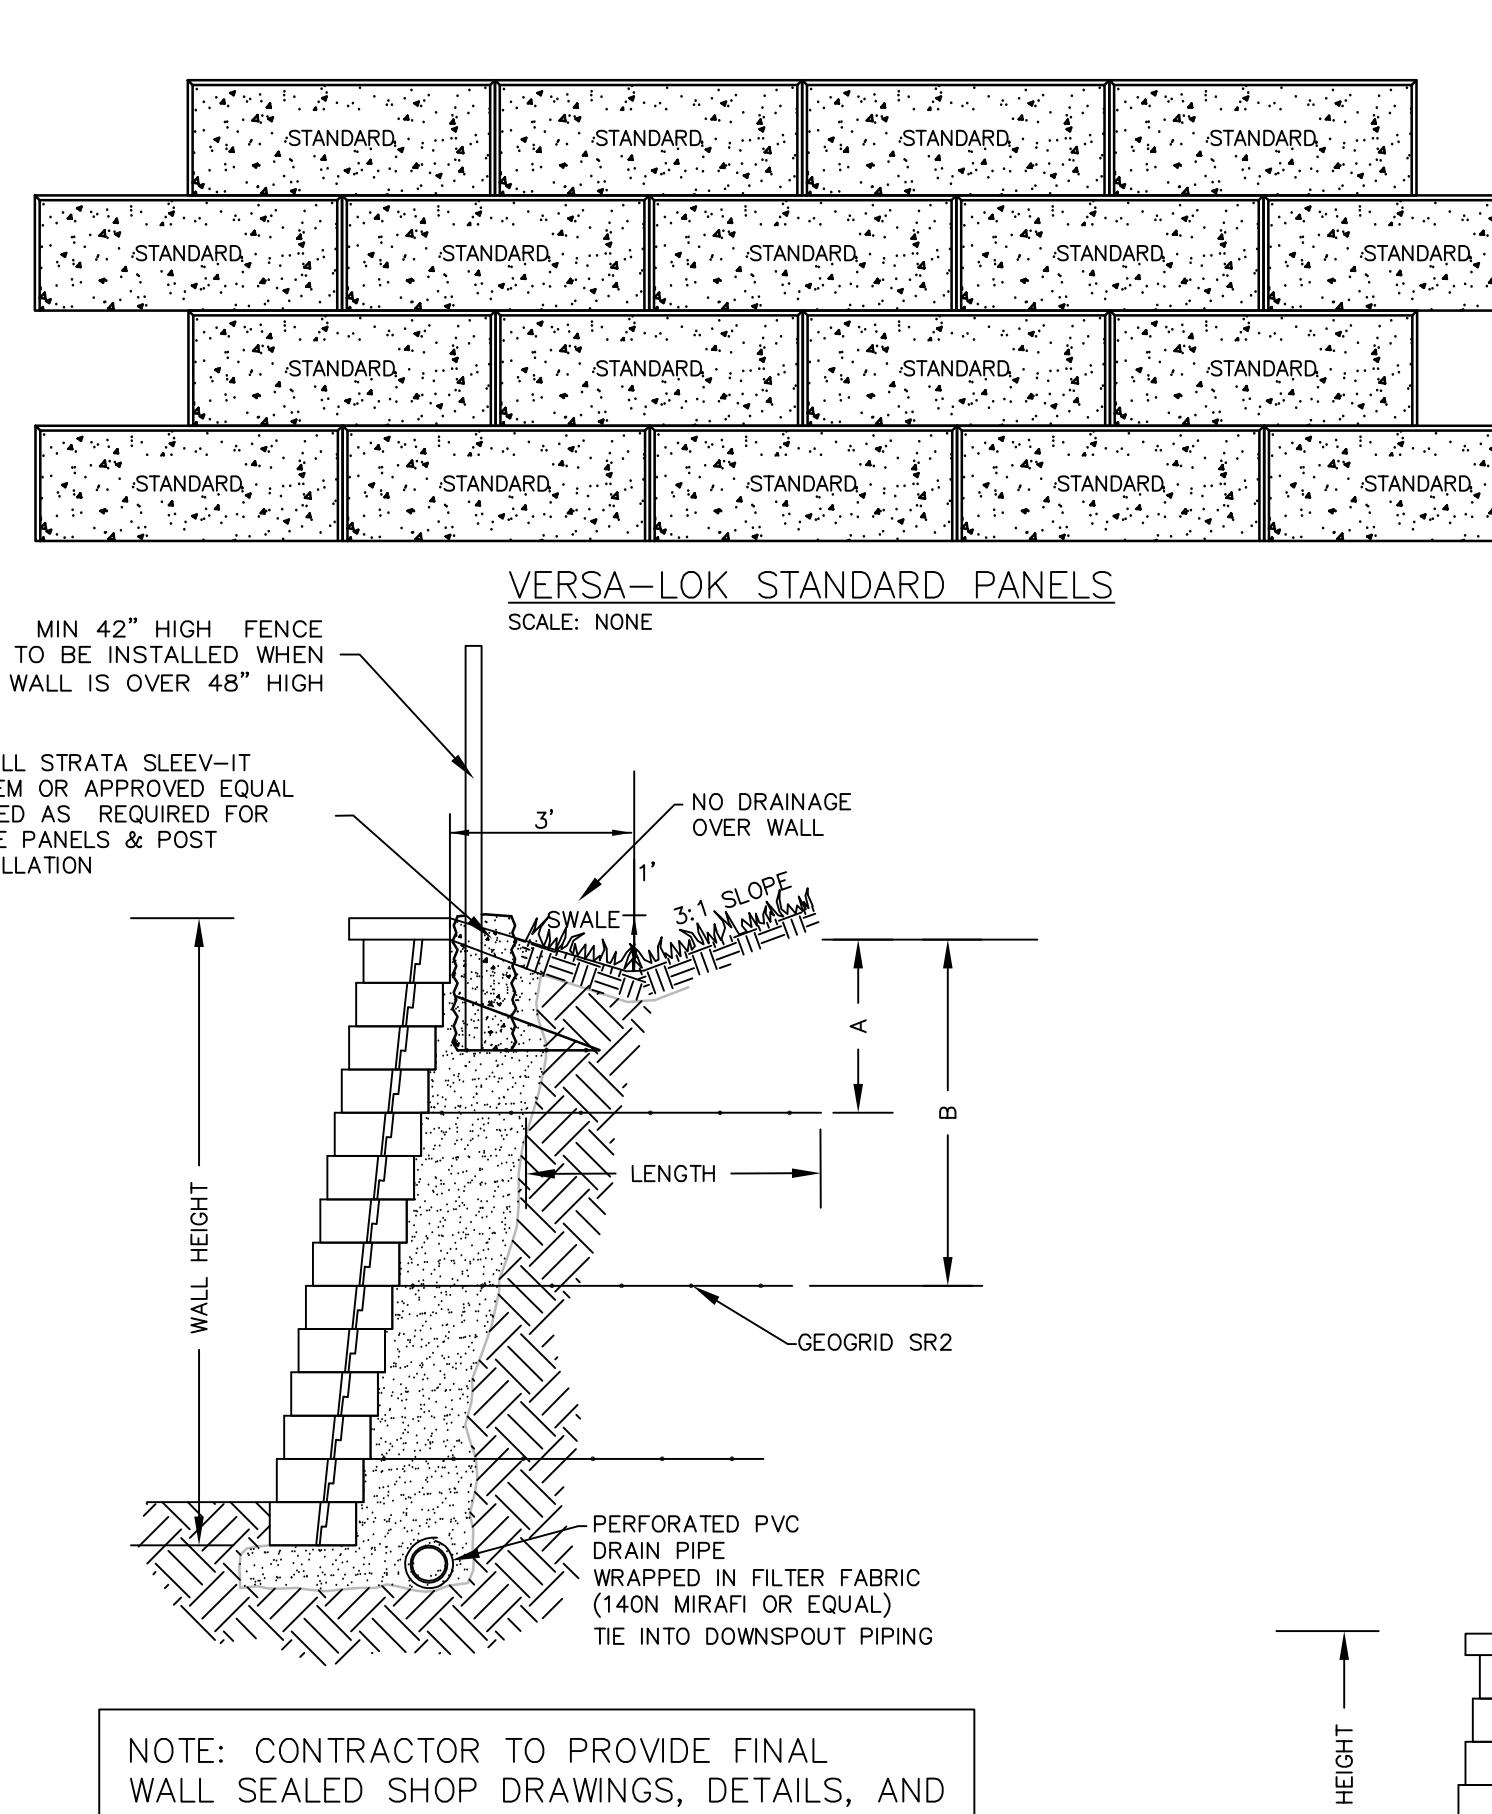


NOTE: CONTRACTOR TO PROVIDE FINAL WALL SEALED SHOP DRAWINGS, DETAILS, AND CALCULATIONS FOR APPROVAL.

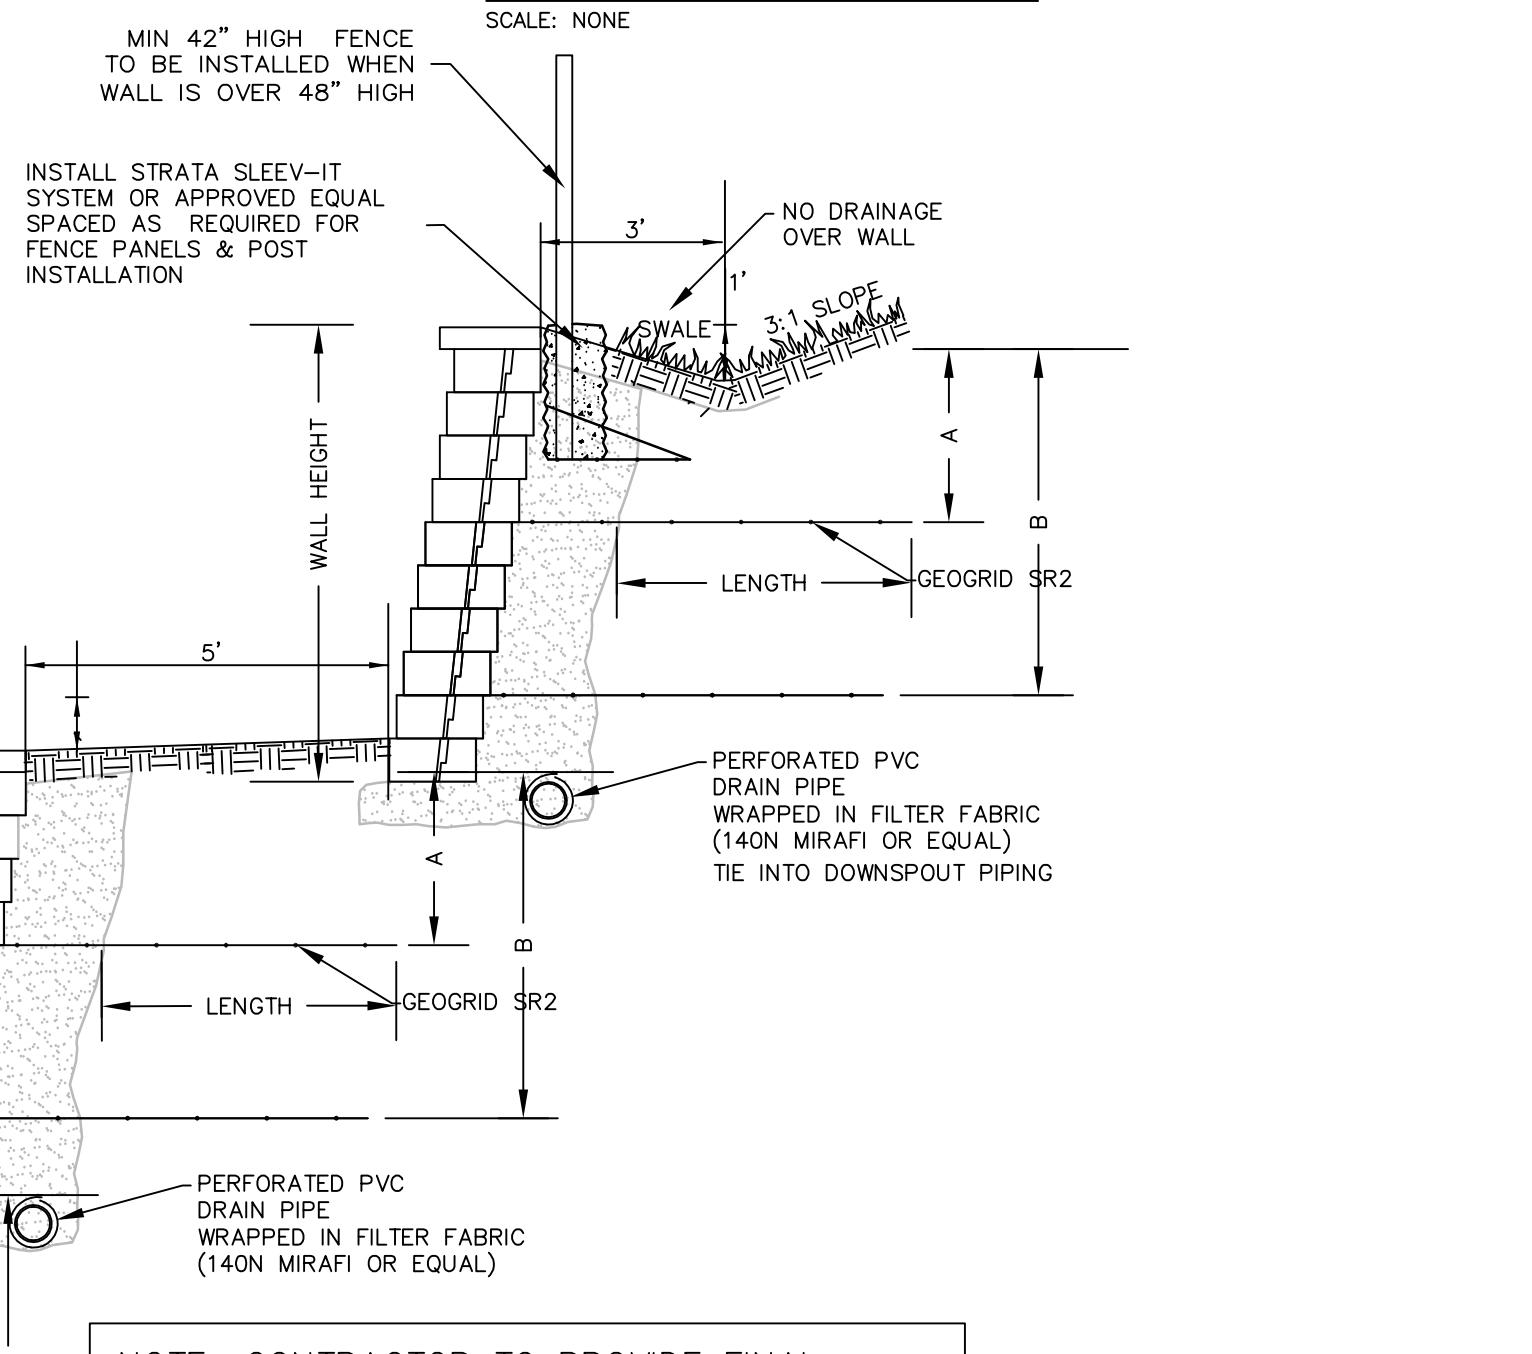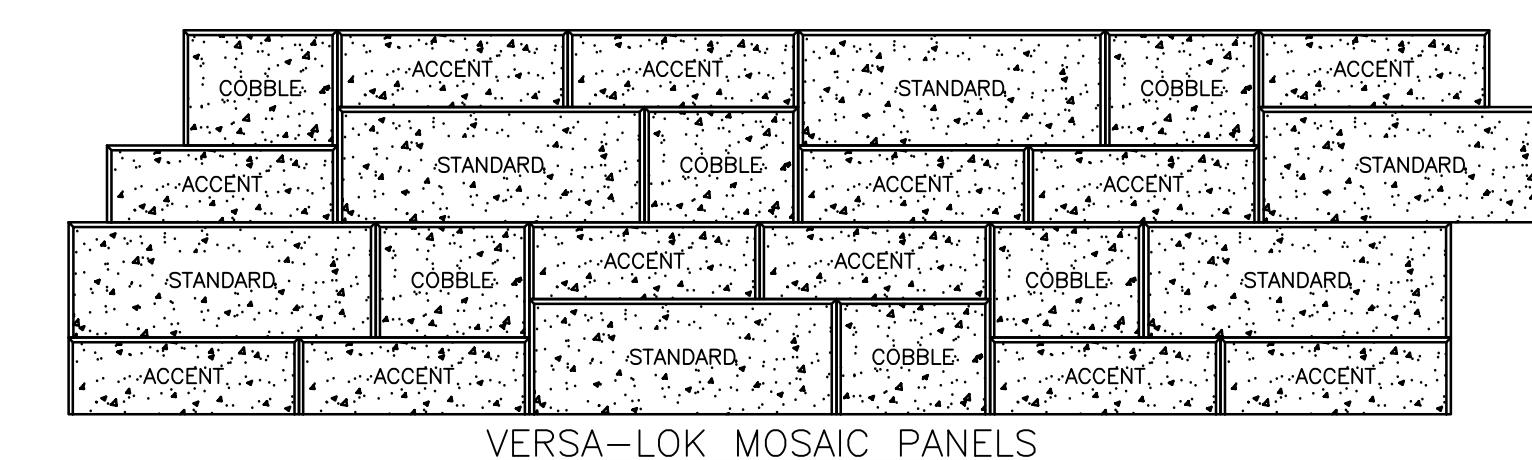

NOTE: CONTRACTOR TO PROVIDE FINAL WALL SEALED SHOP DRAWINGS, DETAILS, AND CALCULATIONS FOR APPROVAL.

MSD P-TBD
M.S.D. BASE MAP 18T
LOC. NO. 18T630173
ZIP CODE 63005

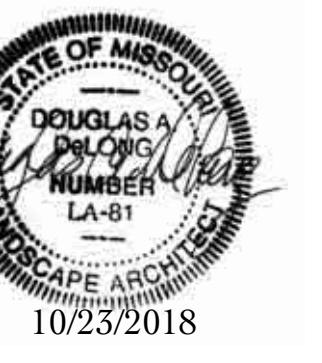

Douglas A. DeLong
NUMBER LA-81
10/23/2018


Douglas A. DeLong, Landscape Architect LA-81


Consultants:



Aventura At Wild Horse Creek Chesterfield, Missouri

Above All Development

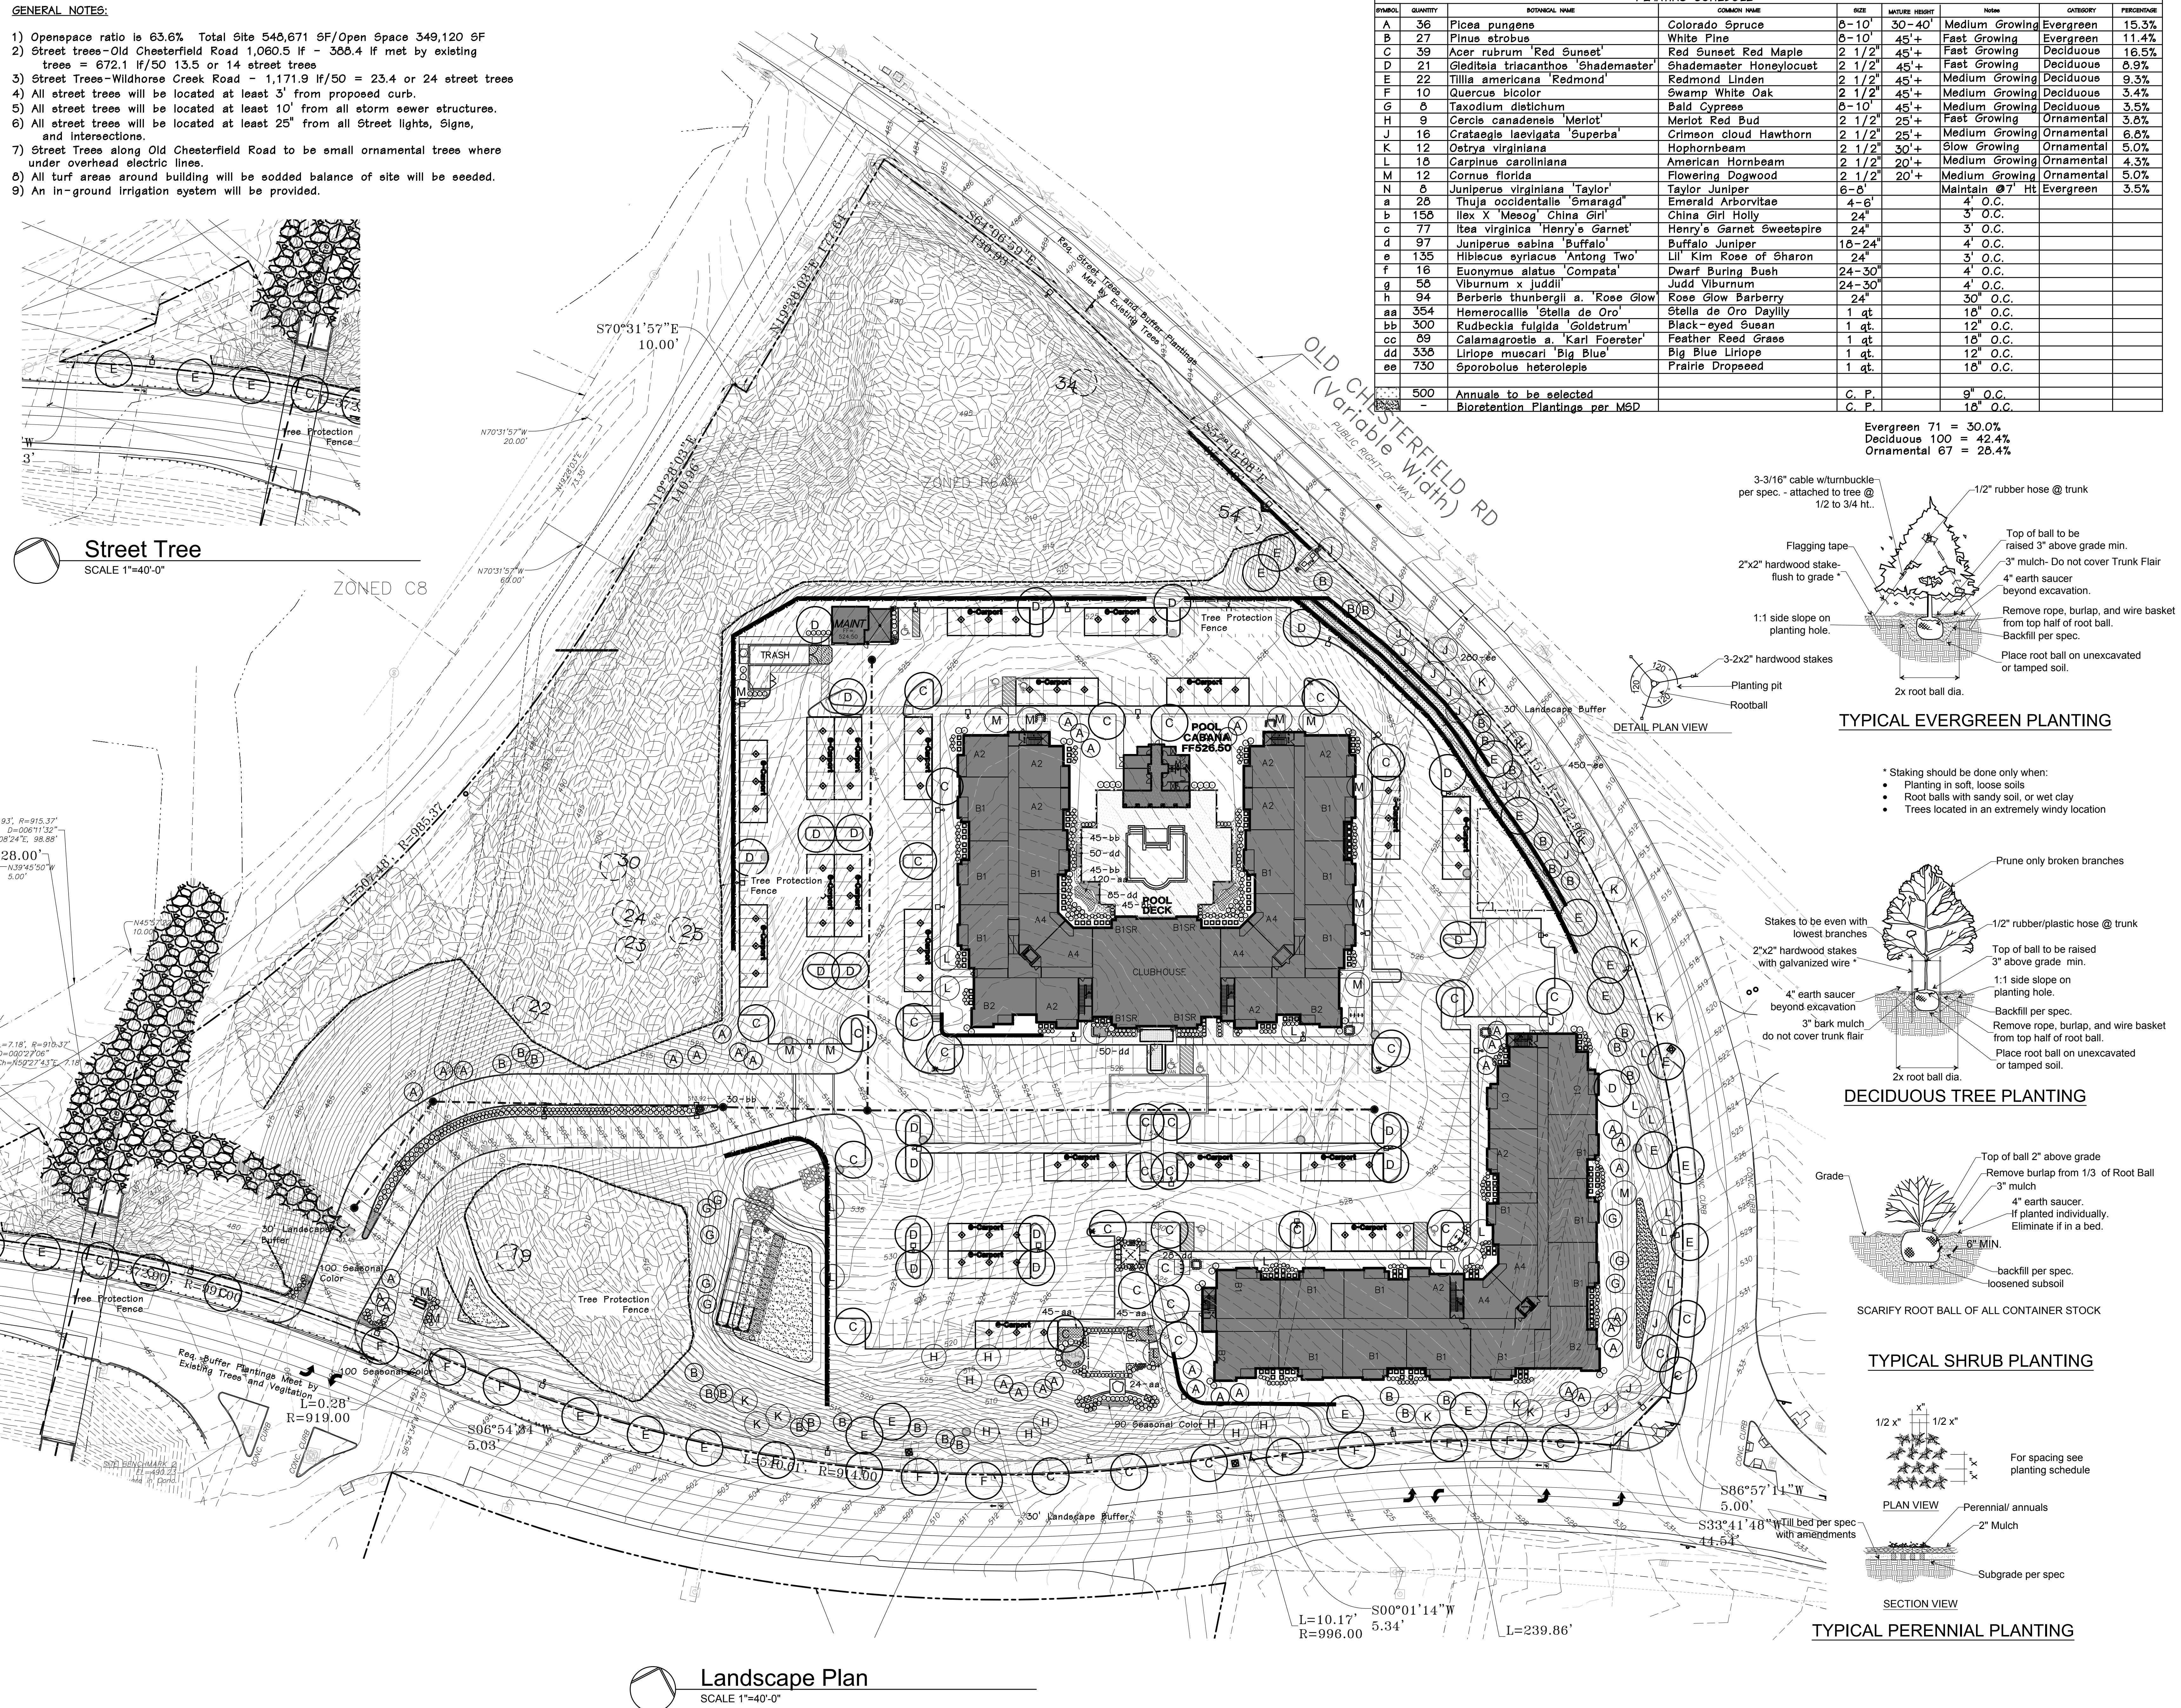

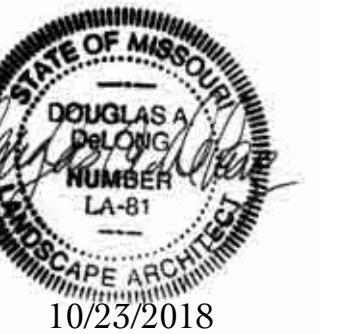


Douglas A. DeLong, Landscape Architect LA-81

Consultants:




Aventura At Wild Horse Creek Chesterfield, Missouri


Above All Development

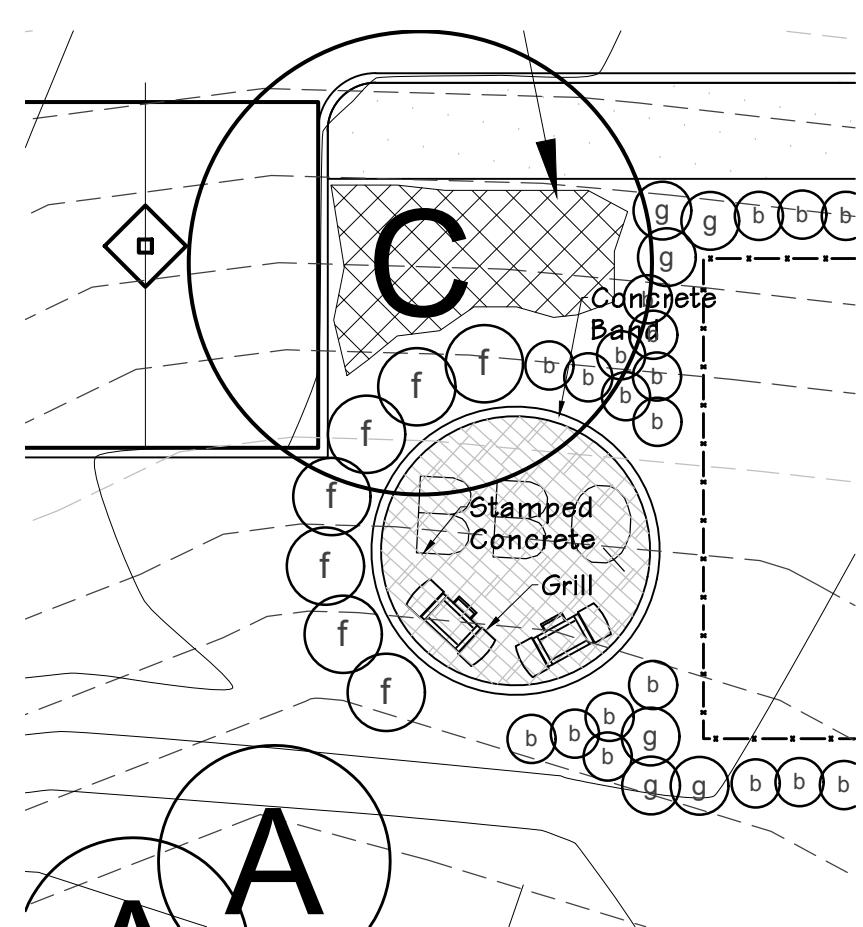


BBQ Patio
SCALE 1"=10'-0"

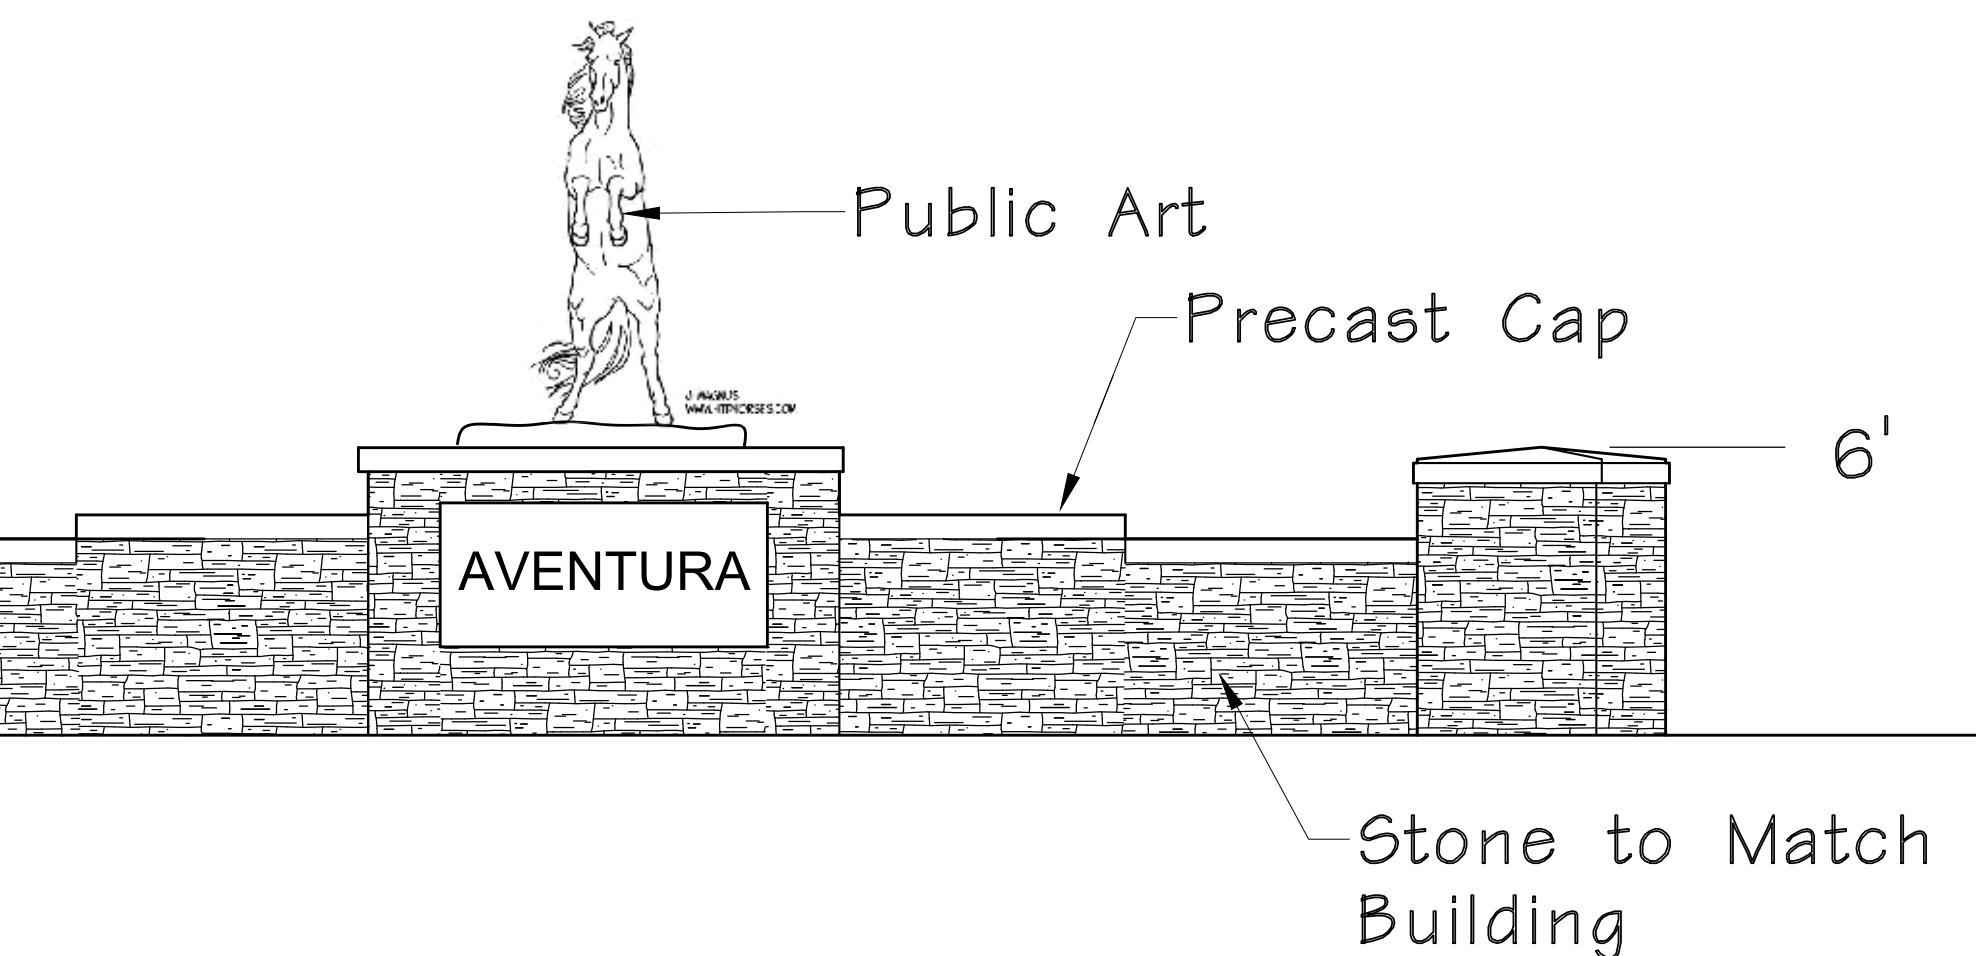


Entry Monument-Public Art
SCALE 1/4"=1'-0"

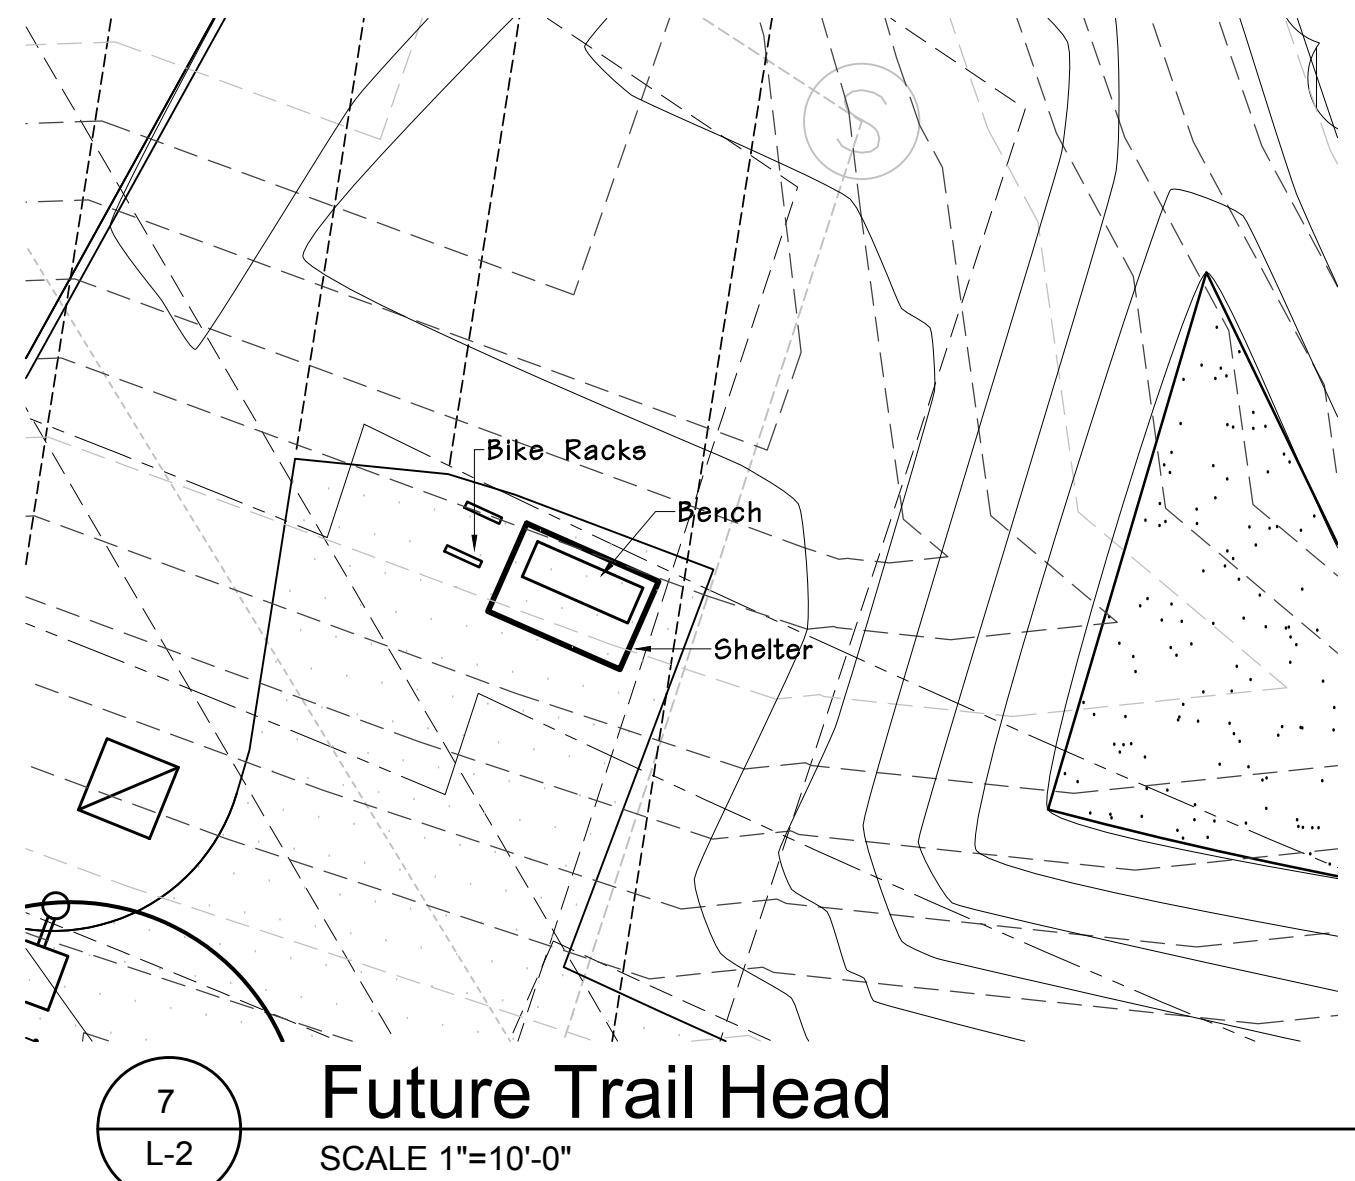


Future Trail Head
SCALE 1"=10'-0"

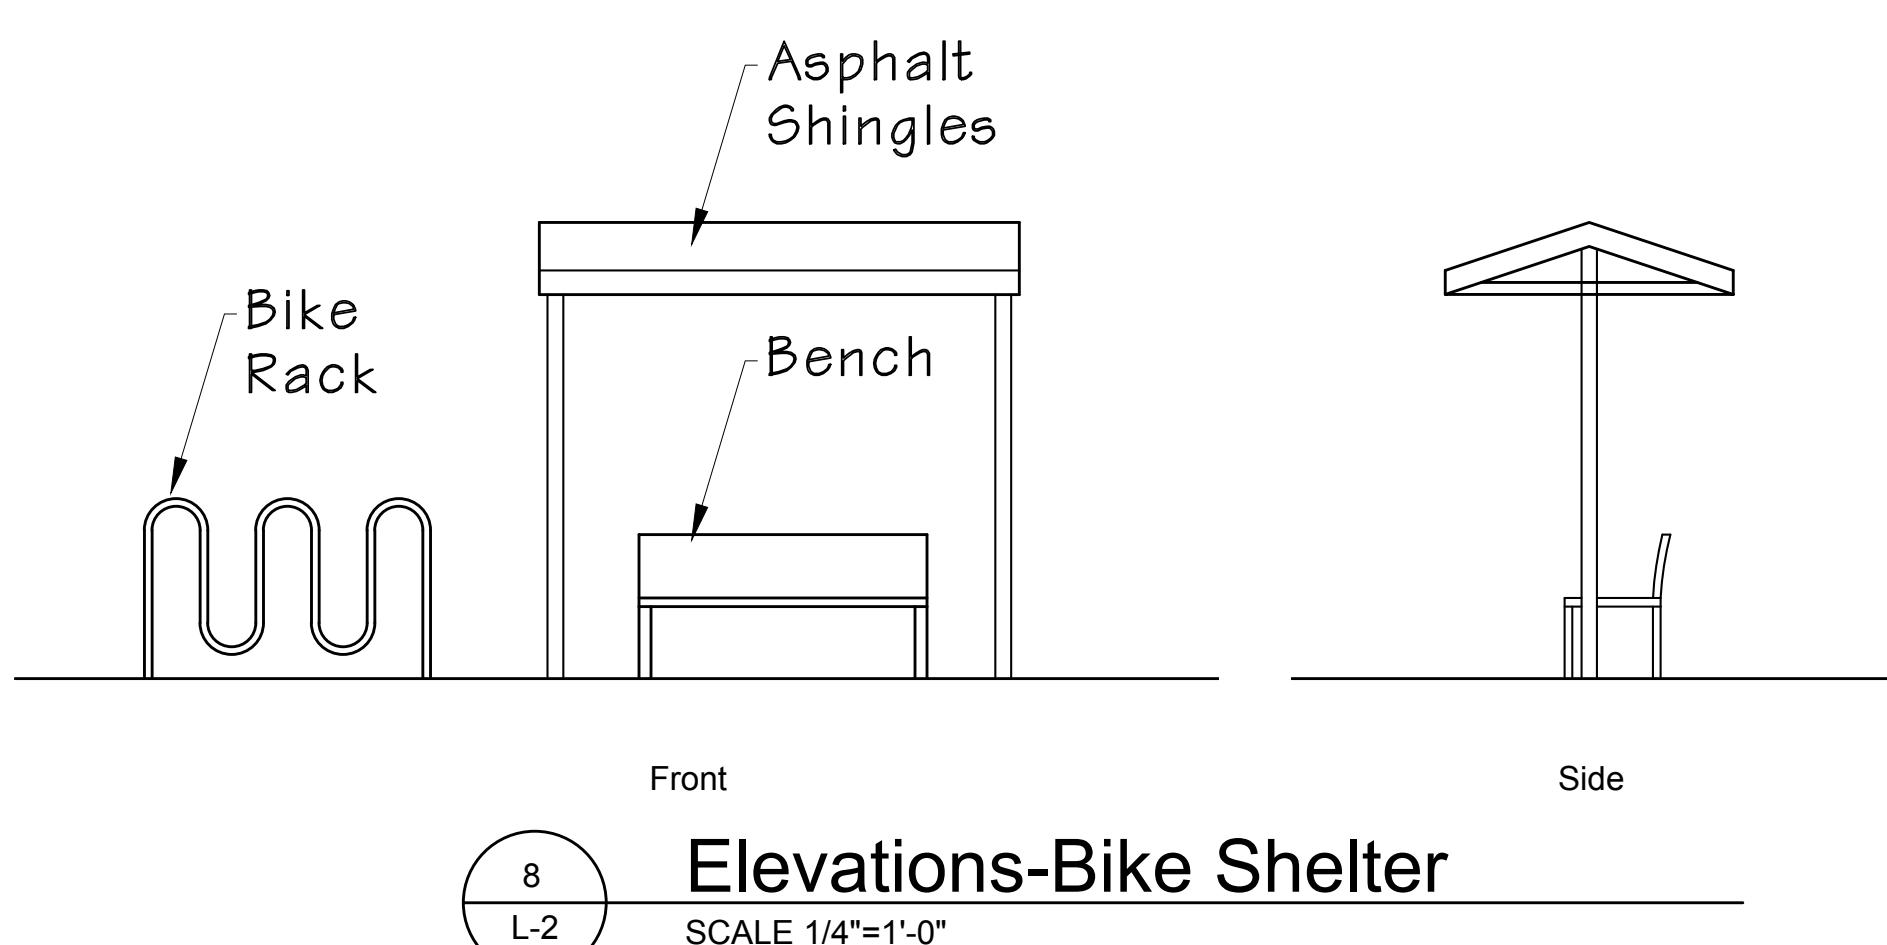


Elevations-Bike Shelter
SCALE 1/4"=1'-0"

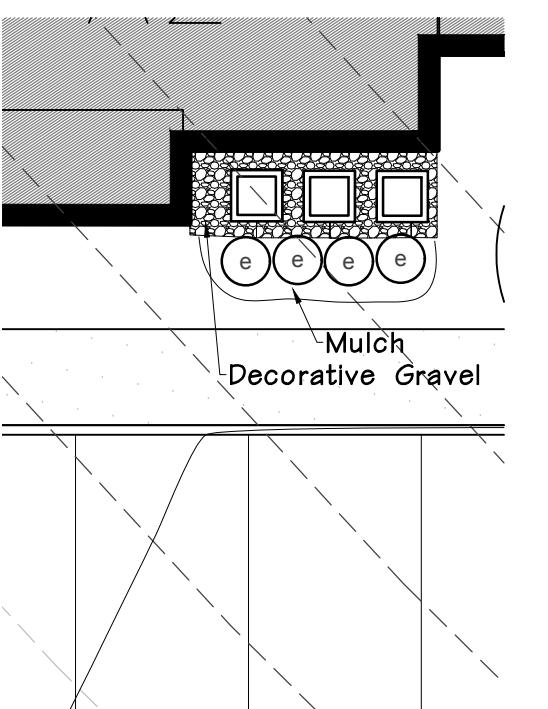


3 AC Unit Screening
SCALE 1"=10'-0"

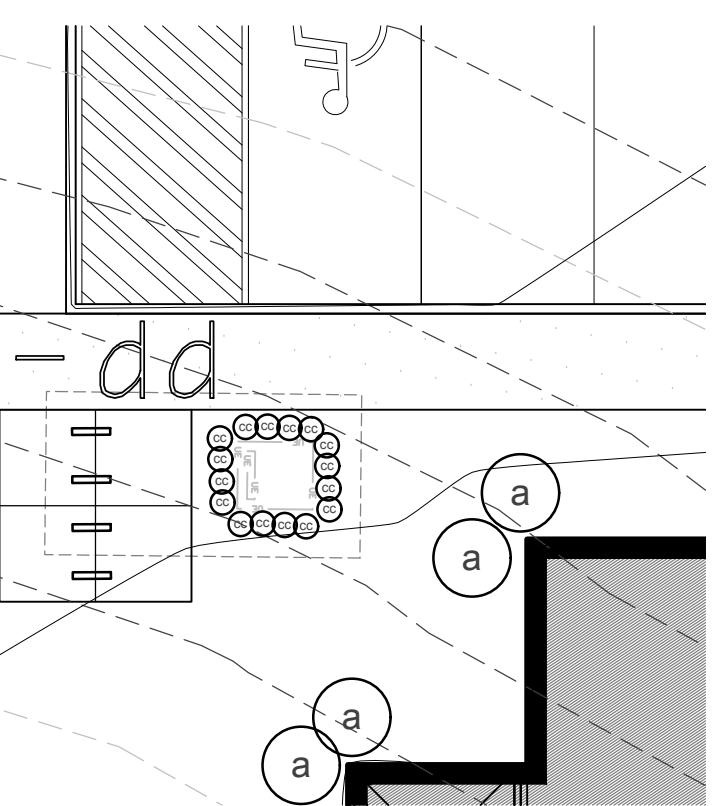


Typical Transformer Screening
SCALE 1"=10'-0"

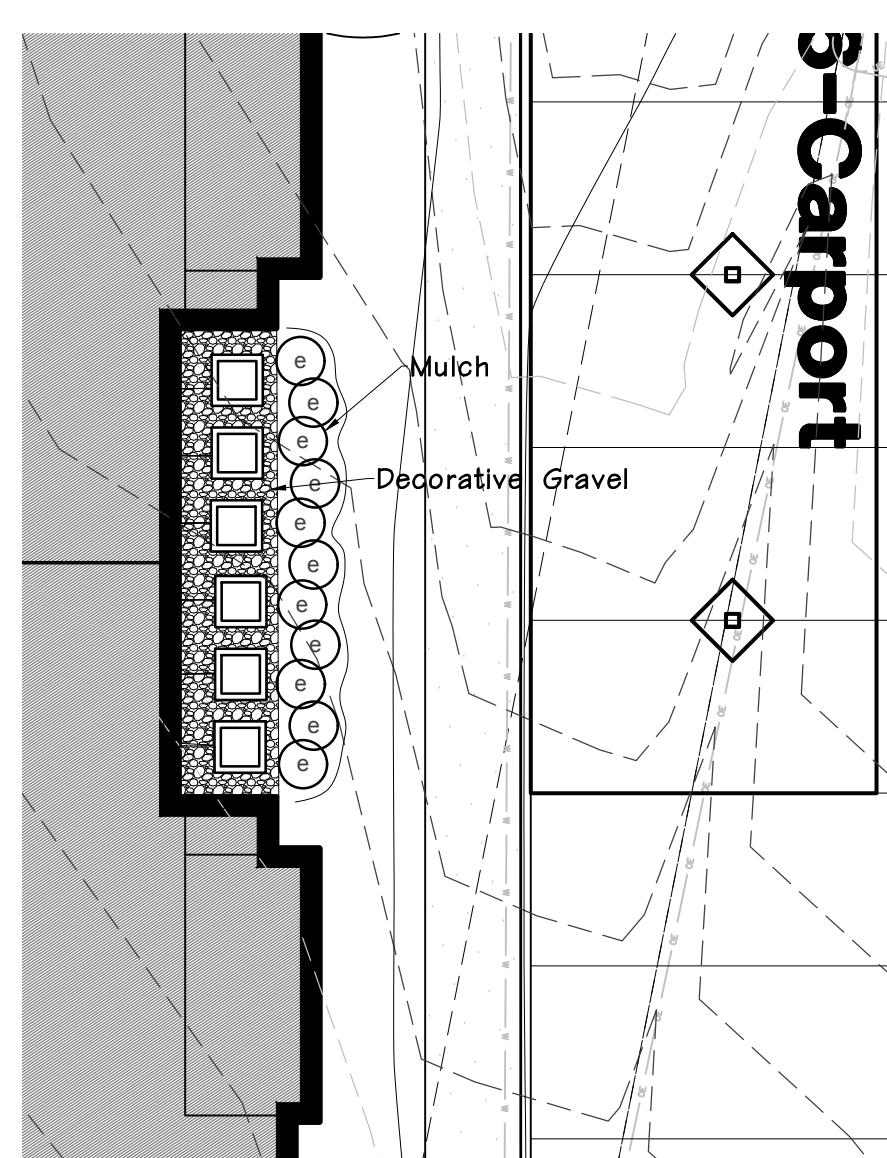


6 AC Unit Screening
SCALE 1"=10'-0"

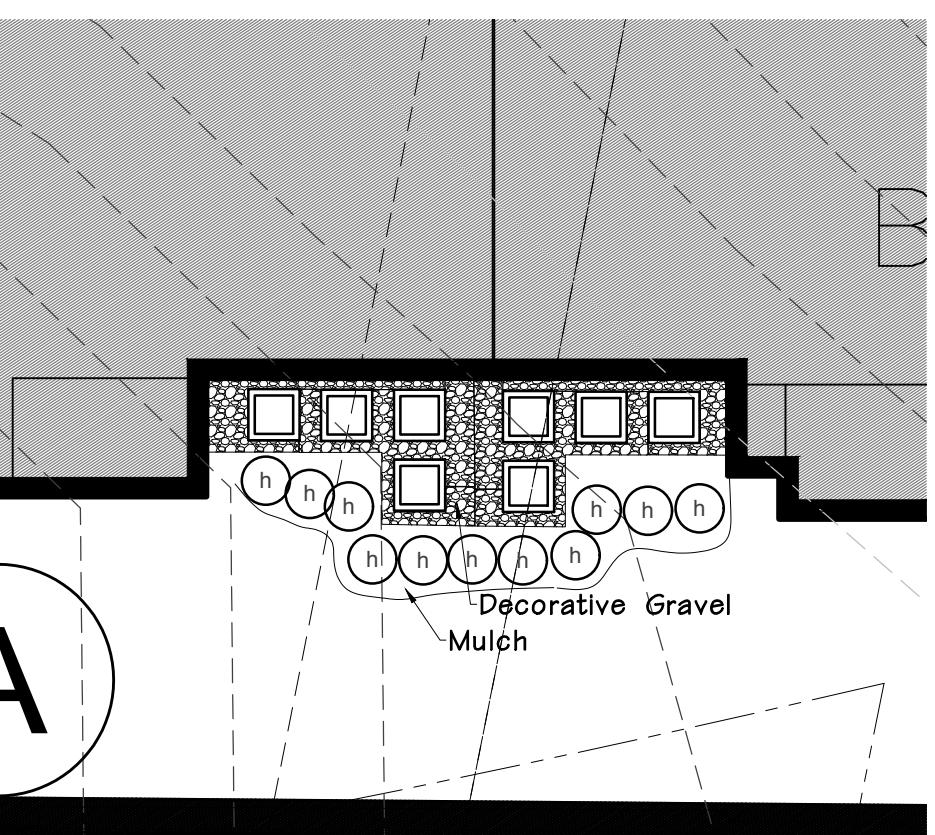

8 AC Unit Screening
SCALE 1"=10'-0"

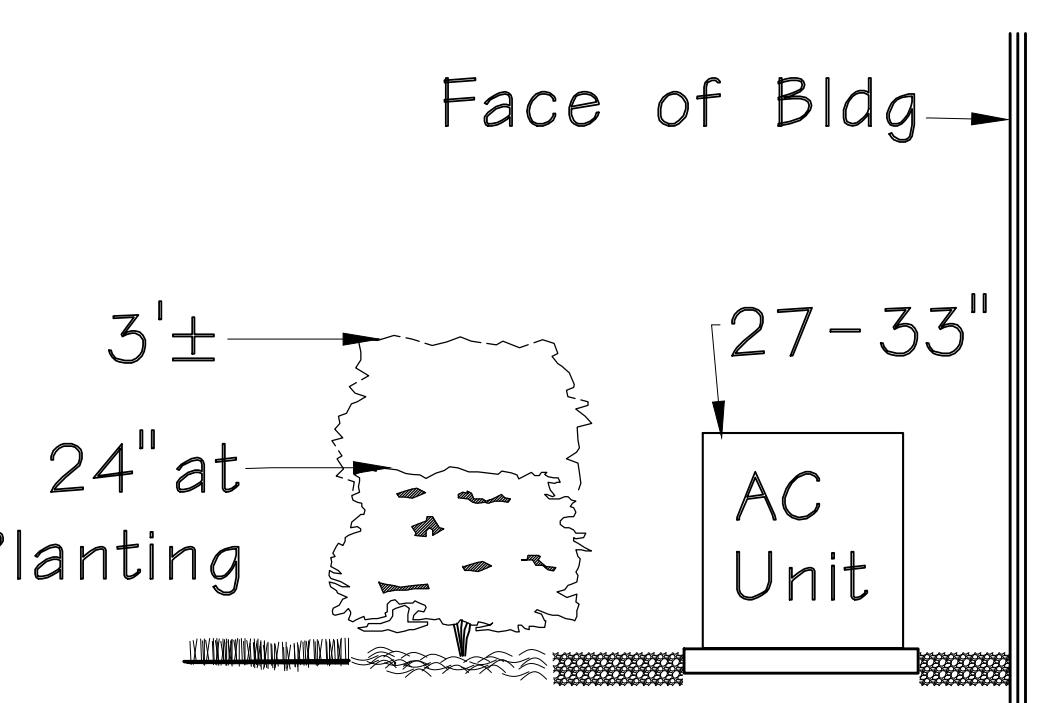

Section AC Unit Screening
SCALE 1/2"=1'-0"

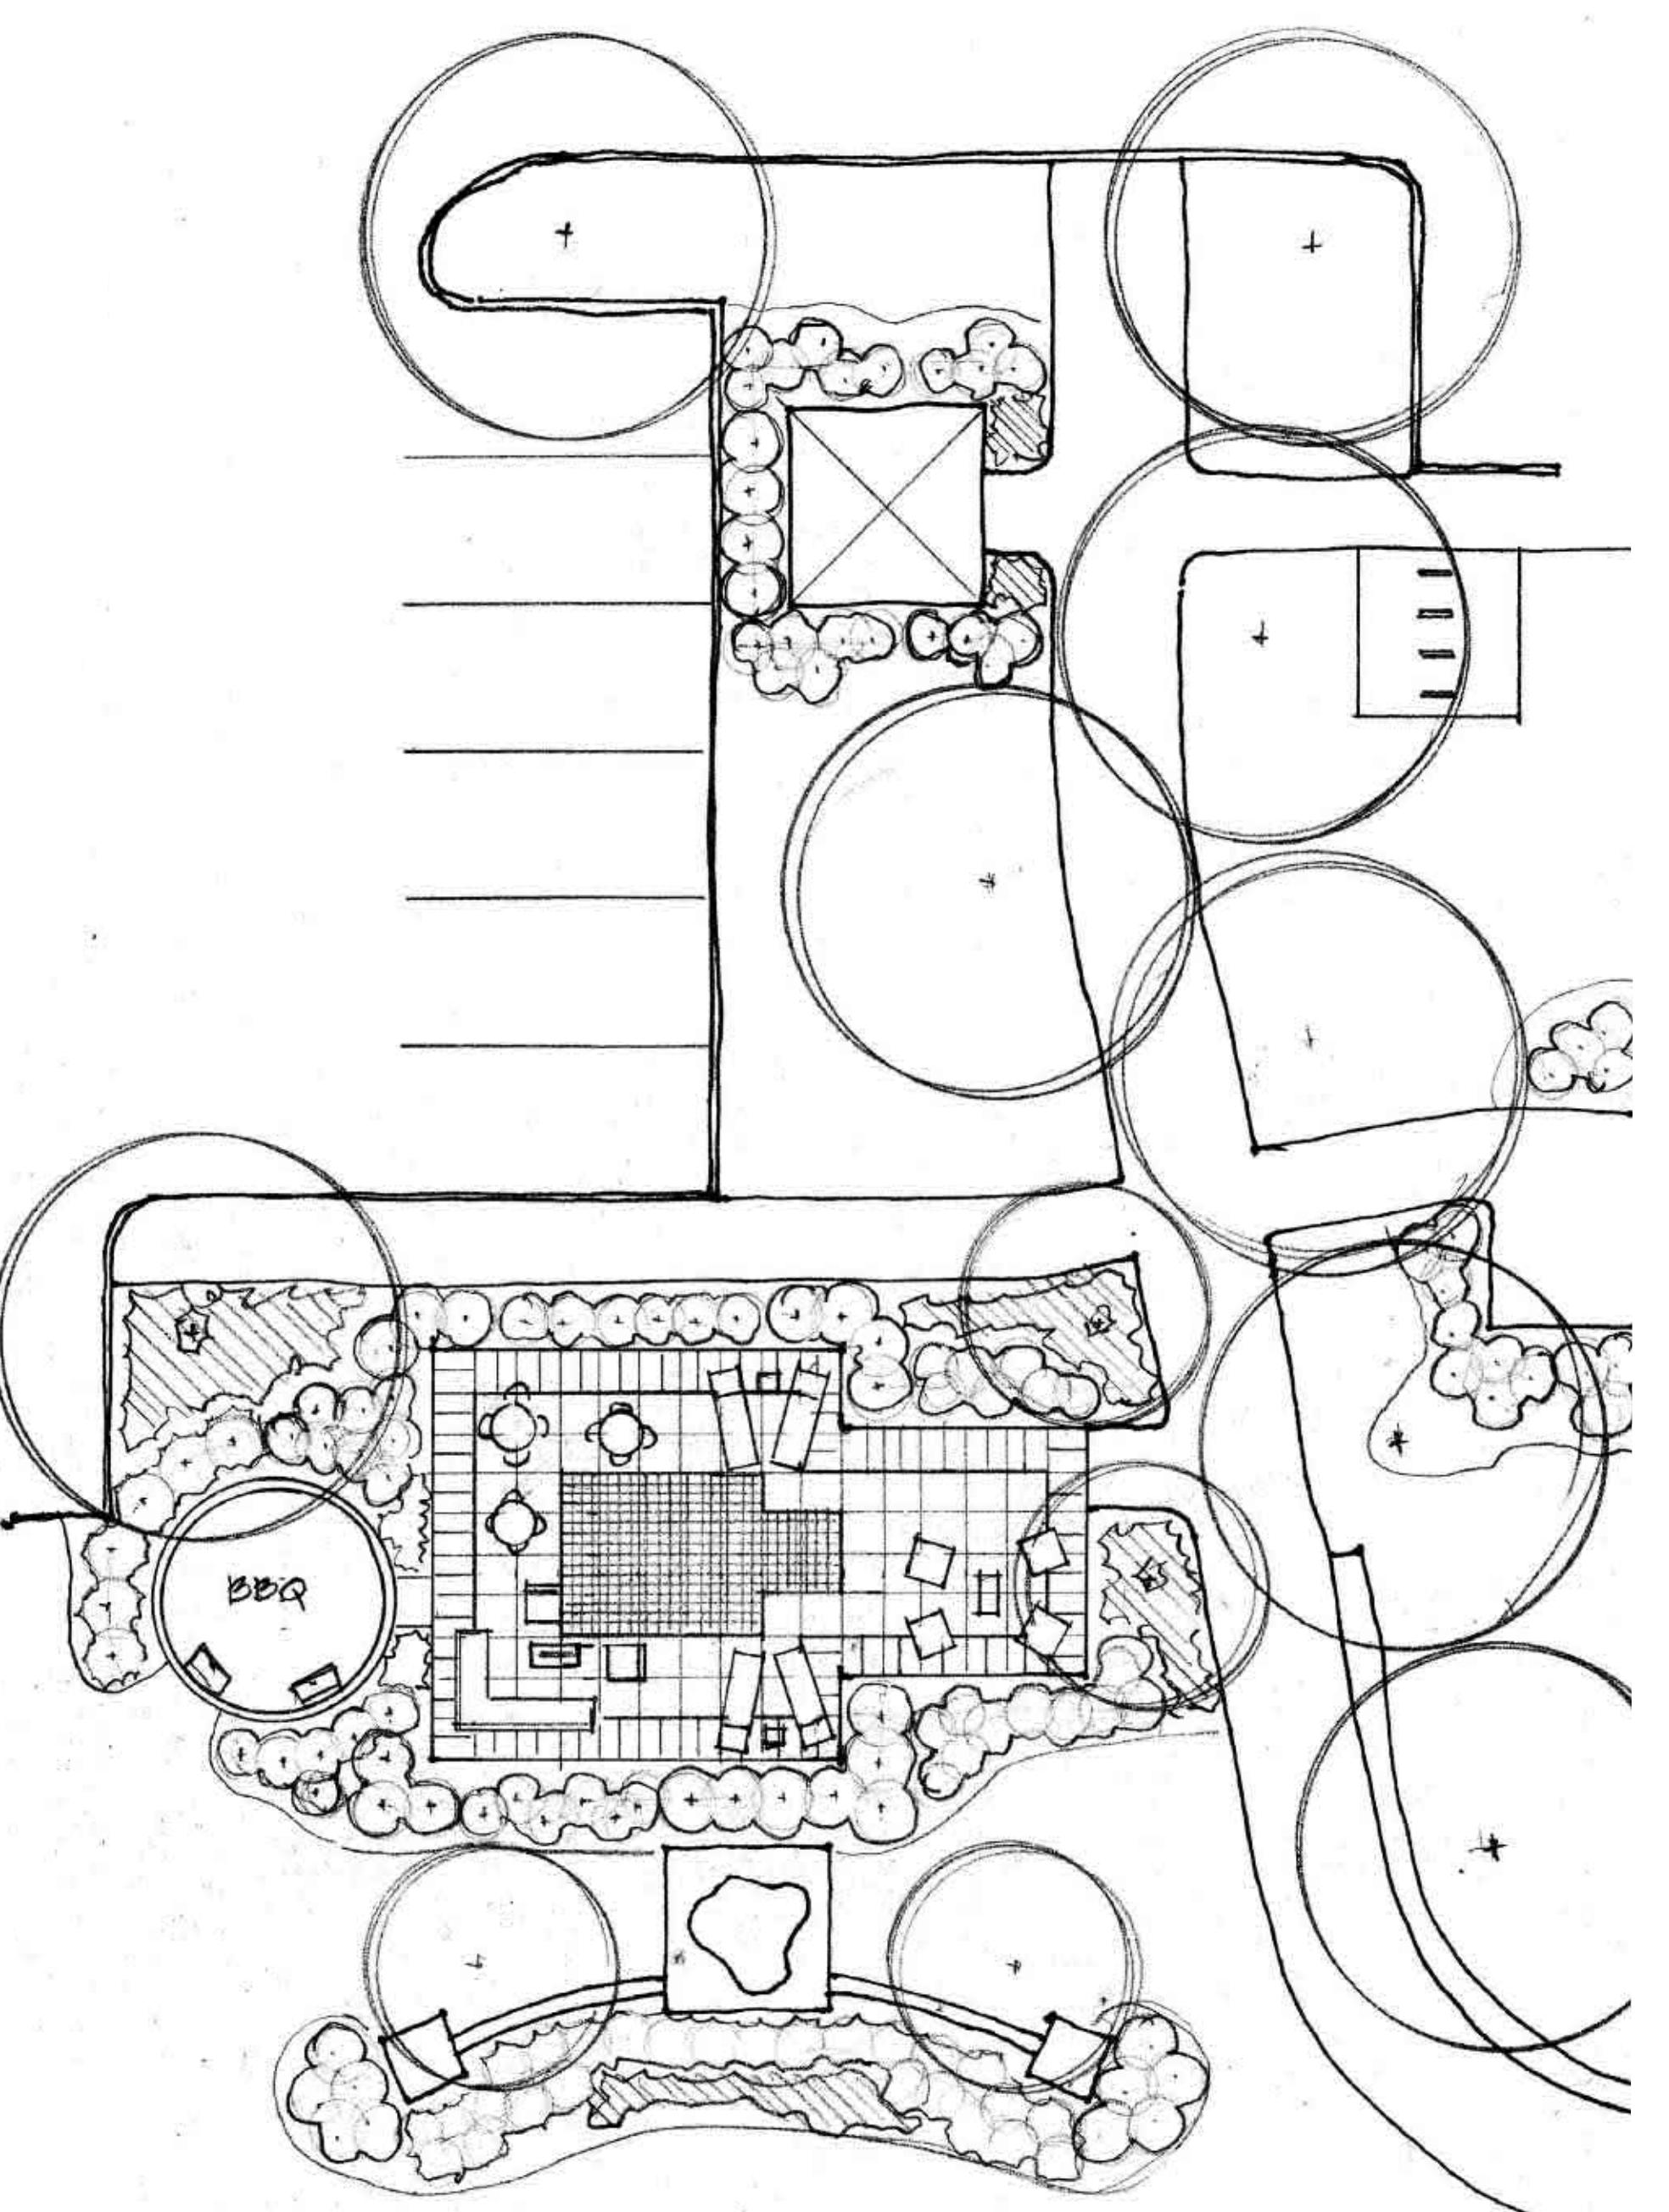

Pocket Park
SCALE 1"=10'-0"

Revisions:		
Date	Description	No.
6/11/18	City Comments	1
7/23/18	City Comments	2
8/28/18	Added Details	3
9/19/18	City Comments	4
10/11/18	City Comments	5
10/23/18	Site Plan	6

Drawn: **BAD**
Checked: **DAD**

Delong Architecture, LLC
7620 West Bruno Ave
St. Louis, MO 63117
(314) 346-4856
delong.la@gmail.com
Missouri State Certificate of Authority #2010000145

Sheet No:	Landscape Details
L - 2	

Date: 7/19/2018
Job #: 127.006

TREE PROTECTION NOTES:


- 1) Preserved woodland canopy is delineated with shading.
- 2) Pre-construction meeting to be held on-site to include a presentation of tree protection measures to operators; construction supervisors; developer's representative; and city zoning inspector.
- 3) Clearing limits to be rough staked in order to facilitate location for installation of protection fencing. No early maintenance schedule is required. Where noted on plan, contractor to trench and root prune prior to any grading activity. Required siltation devices to be installed along limit of disturbance line.
- 4) No clearing or grading shall begin in areas where the treatment and preservation measures have not been completed including the installation of tree protection fencing along all "Limit of Disturbance" lines shown on the plan.

5) Tree Protection Fencing shall be 4-foot high temporary plastic construction fence. No equipment traffic/parking, concrete washout, material storage or other such construction activity shall be permitted to penetrate the protection fencing or disrupt the Protected Woodland Area except for the removal of dead or invasive plant material. Any proposed plantings shall be subject to the review and approval of the City Arborist. All ground plane shall be mulched with hardwood bark mulch. Tree Protection Signage will be placed along the Protection Fencing as shown as the dashed line on the plan.

6) Tree protection measures to be maintained throughout construction sequence.


TREE PROTECTION ACTION KEY SEQUENCE:

- 1) Survey limit of disturbance.
- 2) Install tree protection fencing.
- 3) Post tree protection signage on fence (No signs will be posted on trees).
- 4) Maintain tree protection area as an off-limits zone.

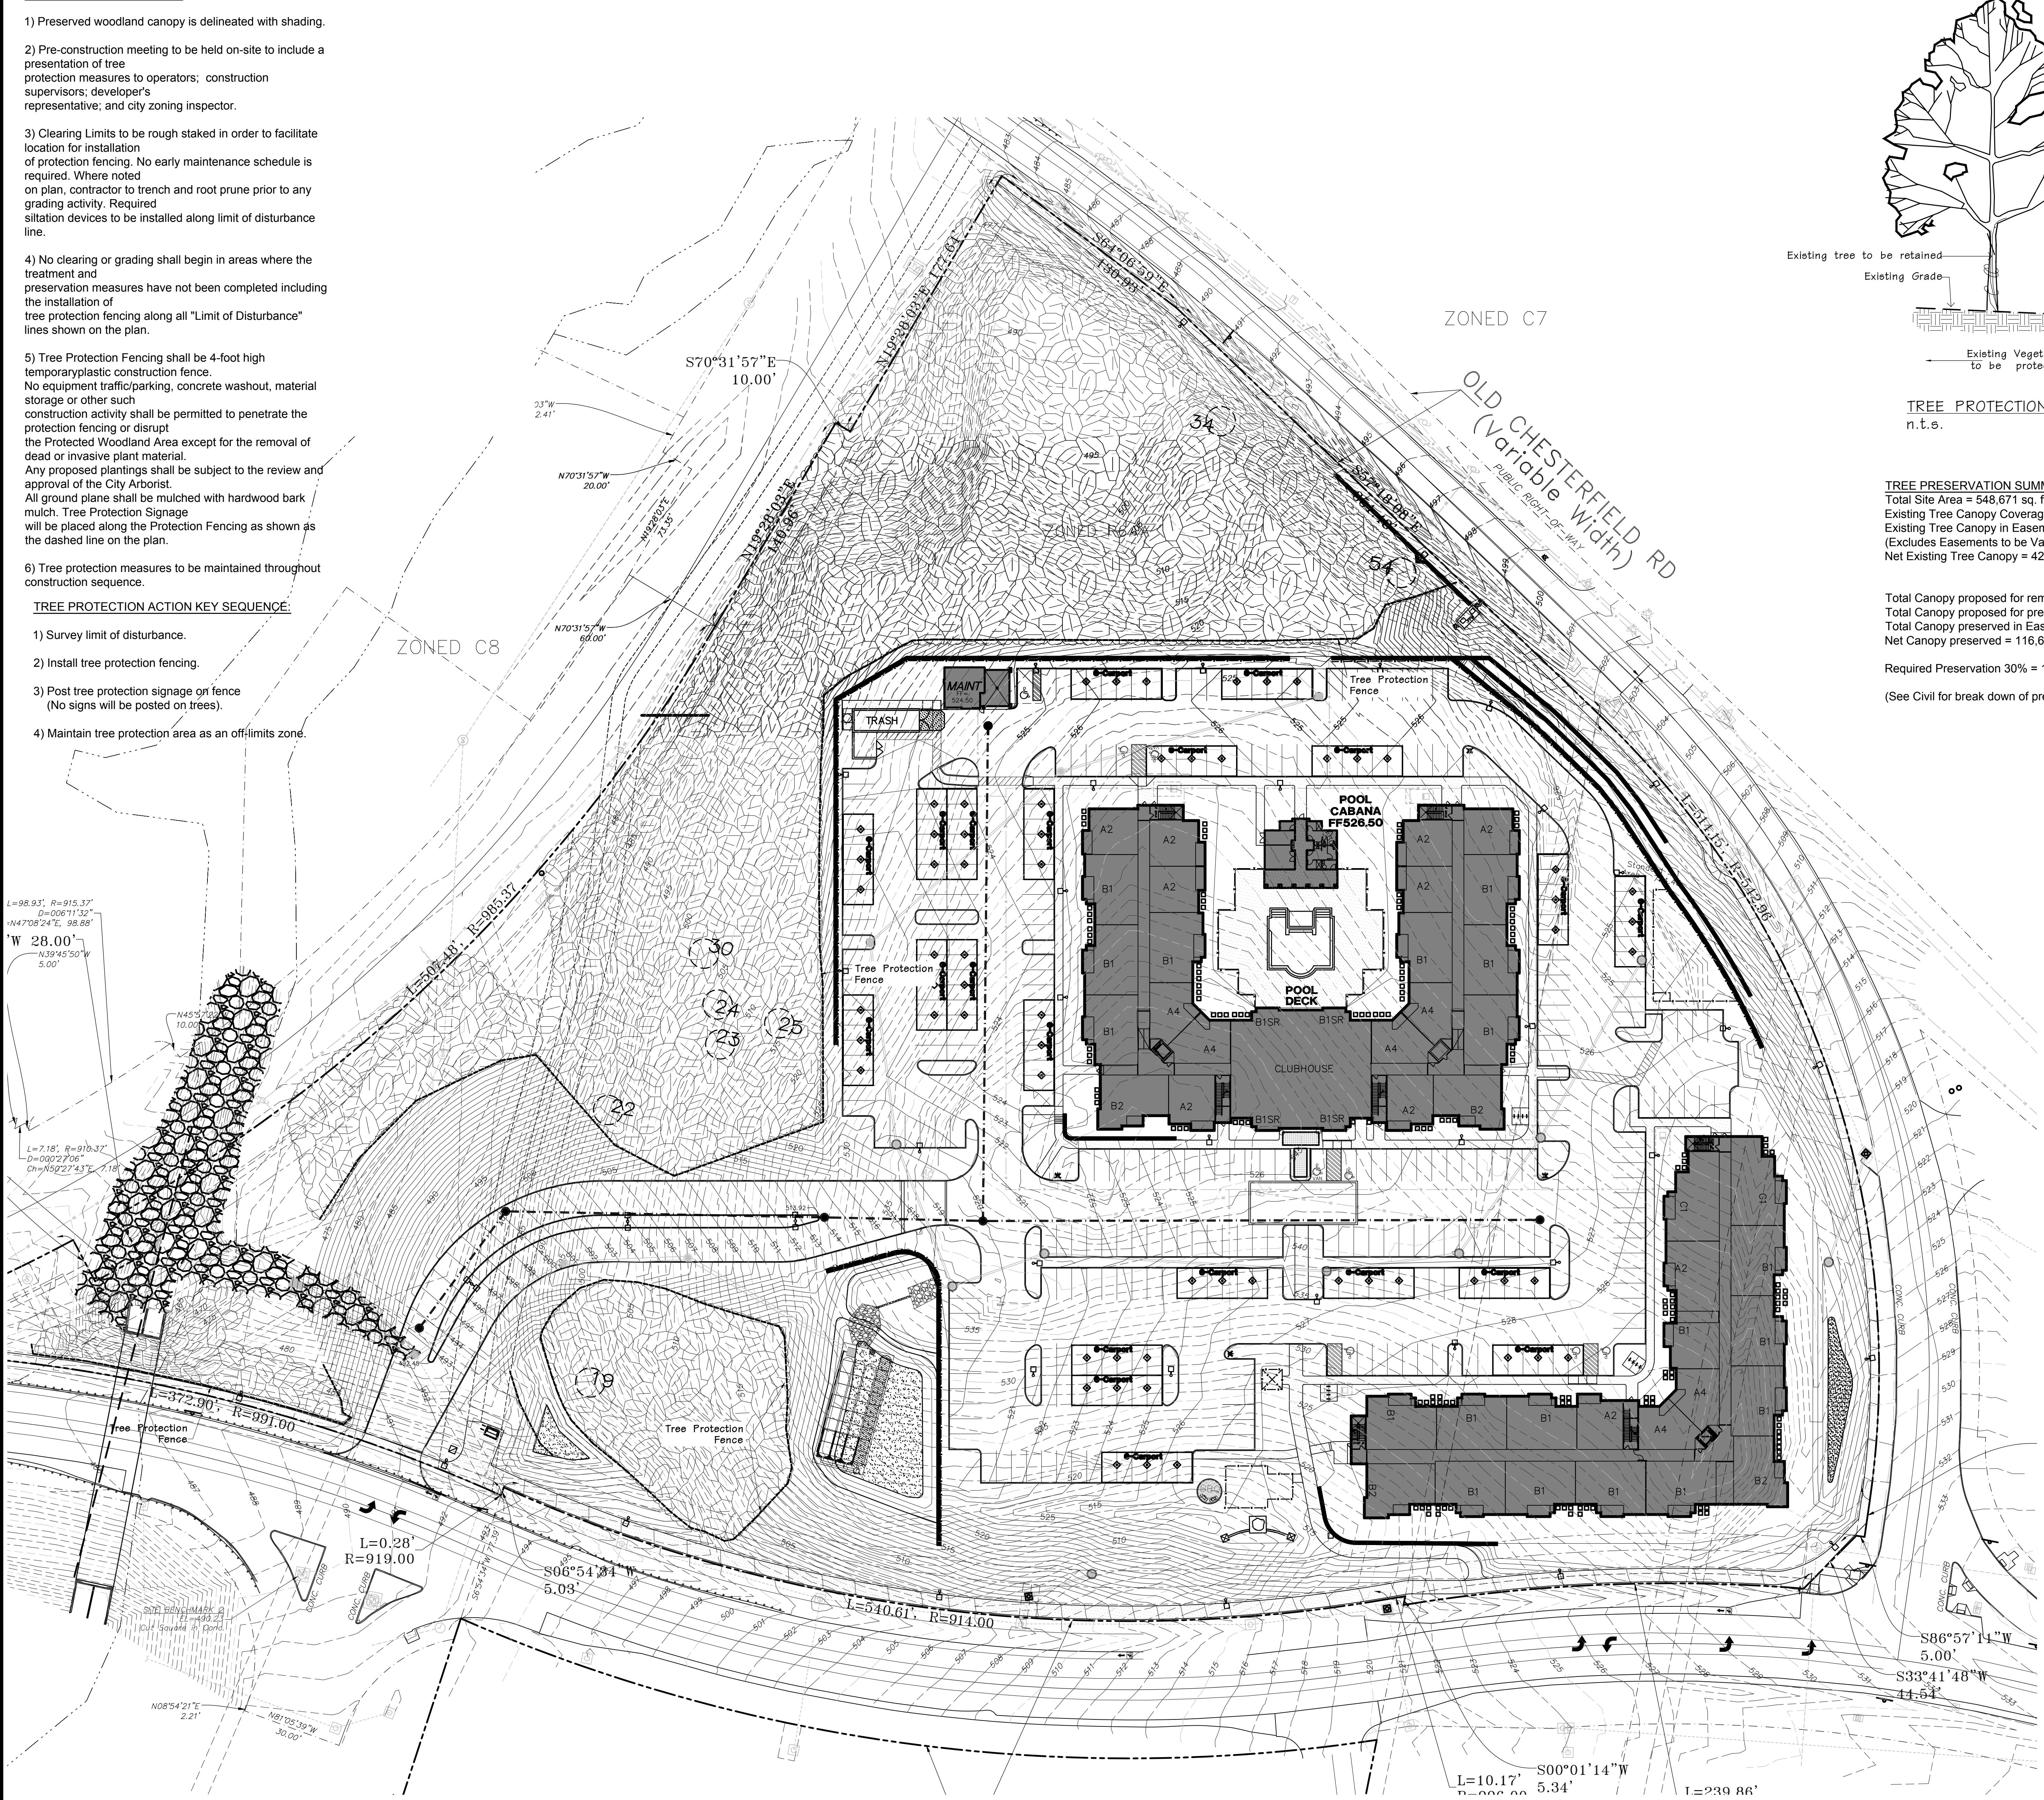

Tree Preservation Plan

SCALE 1"=40'-0"

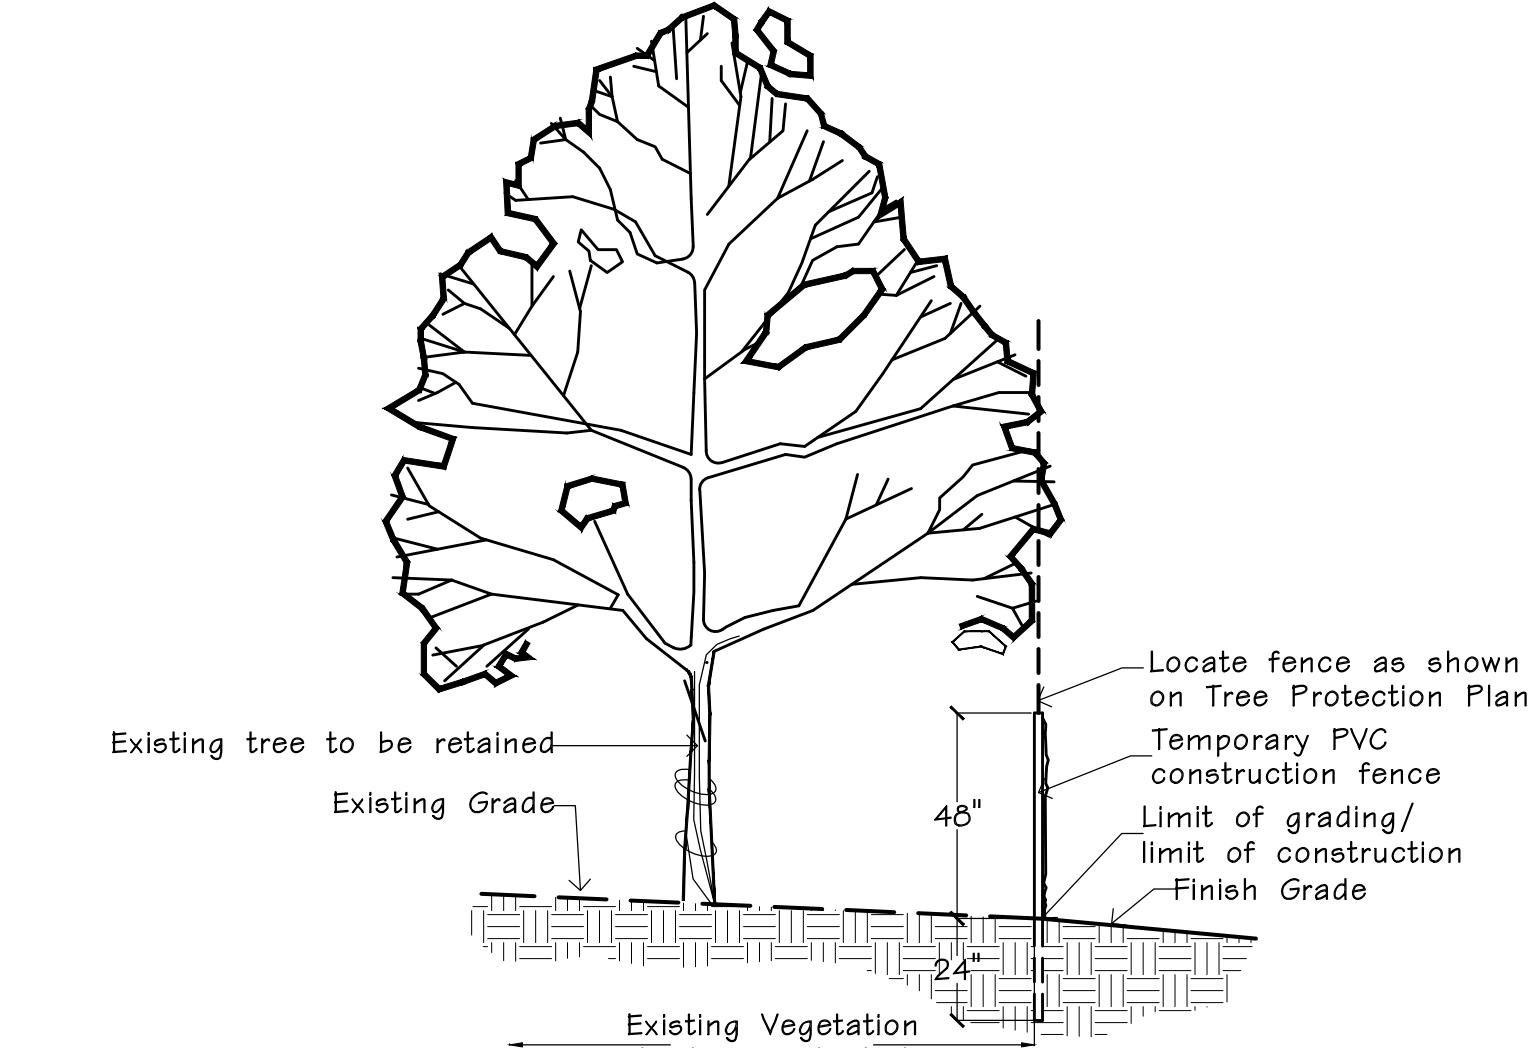

TREE PROTECTION DETAIL
n.t.s.

TREE PRESERVATION SUMMARY:
Total Site Area = 548,671 sq. ft. or 12.59 Ac.
Existing Tree Canopy Coverage = 465,016 sq. ft. or 10.7 Ac.
Existing Tree Canopy in Easements = 35,580.0 sq. ft.
(Excludes Easements to be Vacated)
Net Existing Tree Canopy = 429,436.0 sq. ft.

Total Canopy proposed for removal = 327,544.0 sq. ft. (70.4%)
Total Canopy proposed for preservation = 137,472 sq. ft. (29.6%)
Total Canopy preserved in Easements = 20,846.0 sq. ft.
Net Canopy preserved = 116,626.0 sq. ft. (30.1%)

Required Preservation 30% = 128,830.8 sq. ft.

(See Civil for break down of preserved trees in each easement)

TREE NUMBER	SPECIES_O1	DBH_EXACT	CROWN_CLAS	CONDITION
1	oak northern red	26	31-40	Fair (60-69)
2	sycamore American	28	31-40	Good (70-79)
3	oak northern red	20	31-40	Fair (60-69)
4	sycamore American	20	31-40	Fair (60-69)
5	hackberry	20	31-40	Fair (60-69)
6	pink eastern white	28	41-50	Fair (60-69)
7	maple silver	26	31-40	Fair (60-69)
8	sycamore American	42	51-60	Good (70-79)
9	maple silver	32	41-50	Fair (60-69)
10	maple silver	20	31-40	Fair (60-69)
11	hackberry	20	31-40	Fair (60-69)
12	ash green	20	31-40	Fair (60-69)
13	maple silver	24	31-40	Fair (60-69)
14	hackberry	24	31-40	Fair (60-69)
15	walnut black	20	41-50	Fair (60-69)
16	Basswood spp	22	31-40	Fair (60-69)
17	oak northern red	20	31-40	Good (70-79)
18	hackberry	24	31-40	Fair (60-69)
19	maple silver	20	31-40	Fair (60-69)
20	oak shingle	24	41-50	Good (70-79)
21	oak northern red	22	41-50	Good (70-79)
22	oak chinquapin	24	41-50	Fair (60-69)
23	oak white	22	31-40	Good (70-79)
24	oak shingle	26	41-50	Good (70-79)
25	maple sugar	26	41-50	Good (70-79)
26	oak black	28	41-50	Fair (60-69)
27	oak black	20	31-40	Fair (60-69)
28	oak black	24	31-40	Fair (60-69)
29	oak black	24	31-40	Fair (60-69)
30	oak shingle	20	31-40	Fair (60-69)
31	ash green	20	31-40	Fair (60-69)
32	cherry black	22	31-40	Fair (60-69)
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35	sycamore American	24	41-50	Good (70-79)
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37	sycamore American	24	41-50	Fair (60-69)
38	maple sugar	24	41-50	Good (70-79)
39	maple sugar	20	31-40	Good (70-79)
40	maple silver	24	41-50	Good (70-79)
41	maple sugar	38	41-50	Fair (60-69)
42	oak black	38	51-60	Fair (60-69)
43	ash green	20	31-40	Fair (60-69)
44	maple silver	24	41-50	Fair (60-69)
45	maple sugar	40	41-50	Fair (60-69)
46	maple sugar	24	41-50	Fair (60-69)
47	maple sugar	24	41-50	Fair (60-69)
48	cherry black	20	31-40	Fair (60-69)
49	oak black	30	41-50	Good (70-79)
50	oak black	22	31-40	Fair (60-69)
51	maple sugar	20	31-40	Fair (60-69)
52	maple sugar	22	31-40	Fair (60-69)
53	sycamore American	26	41-50	Dead (0)
54	maple silver	28	41-50	Fair (60-69)
55	cherry black	30	41-50	Fair (60-69)
56	oak white	28	41-50	Fair (60-69)
57	oak black	24	41-50	Fair (60-69)

NOTE: These larger trees were located and identified. However, it was determined that none of these met two or more of the criteria to be classified as Monarch trees.

Revisions:

Date	Description	No.
6/11/18	City Comments	1
9/19/18	City Comments	4
10/11/18	City Comments	5
10/24/18	Site Plan	6

Drawn:

BAD

Checked:

DAD

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(314) 346-4856
delong.la@gmail.com
Missouri State Certificate of Authorization #2010000145

Sheet Title:	Tree Preservation Plan
Sheet No:	TPP
Date:	6/11/2018
Job #:	127.006

Skip Kincaid
Tree Protection Plan Prepared under direction of Skip Kincaid of Hansen's Tree Service Certified Arborist MW-0155BW

Base Map Provided by: Grimes Consulting



Hansen's
O'Fallon, MO Branson, MO
Phone: 636-779-1339
www.hansens-tree.com

Aventura At Wild Horse Creek
Chesterfield, Missouri
Above All Development

Aventura at Wild Horse Creek Chesterfield, MO


Douglas A. DeLong, Landscape Architect LA-81

Consultants:





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55	cherry black	30	41-50 Fair (60-69)
56	oak white	28	41-50 Fair (60-69)
57	oak black	24	41-50 Fair (60-69)

NOTE: These larger trees were located and identified. However, it was determined that none of these met two or more of the criteria to be classified as Monarch trees.

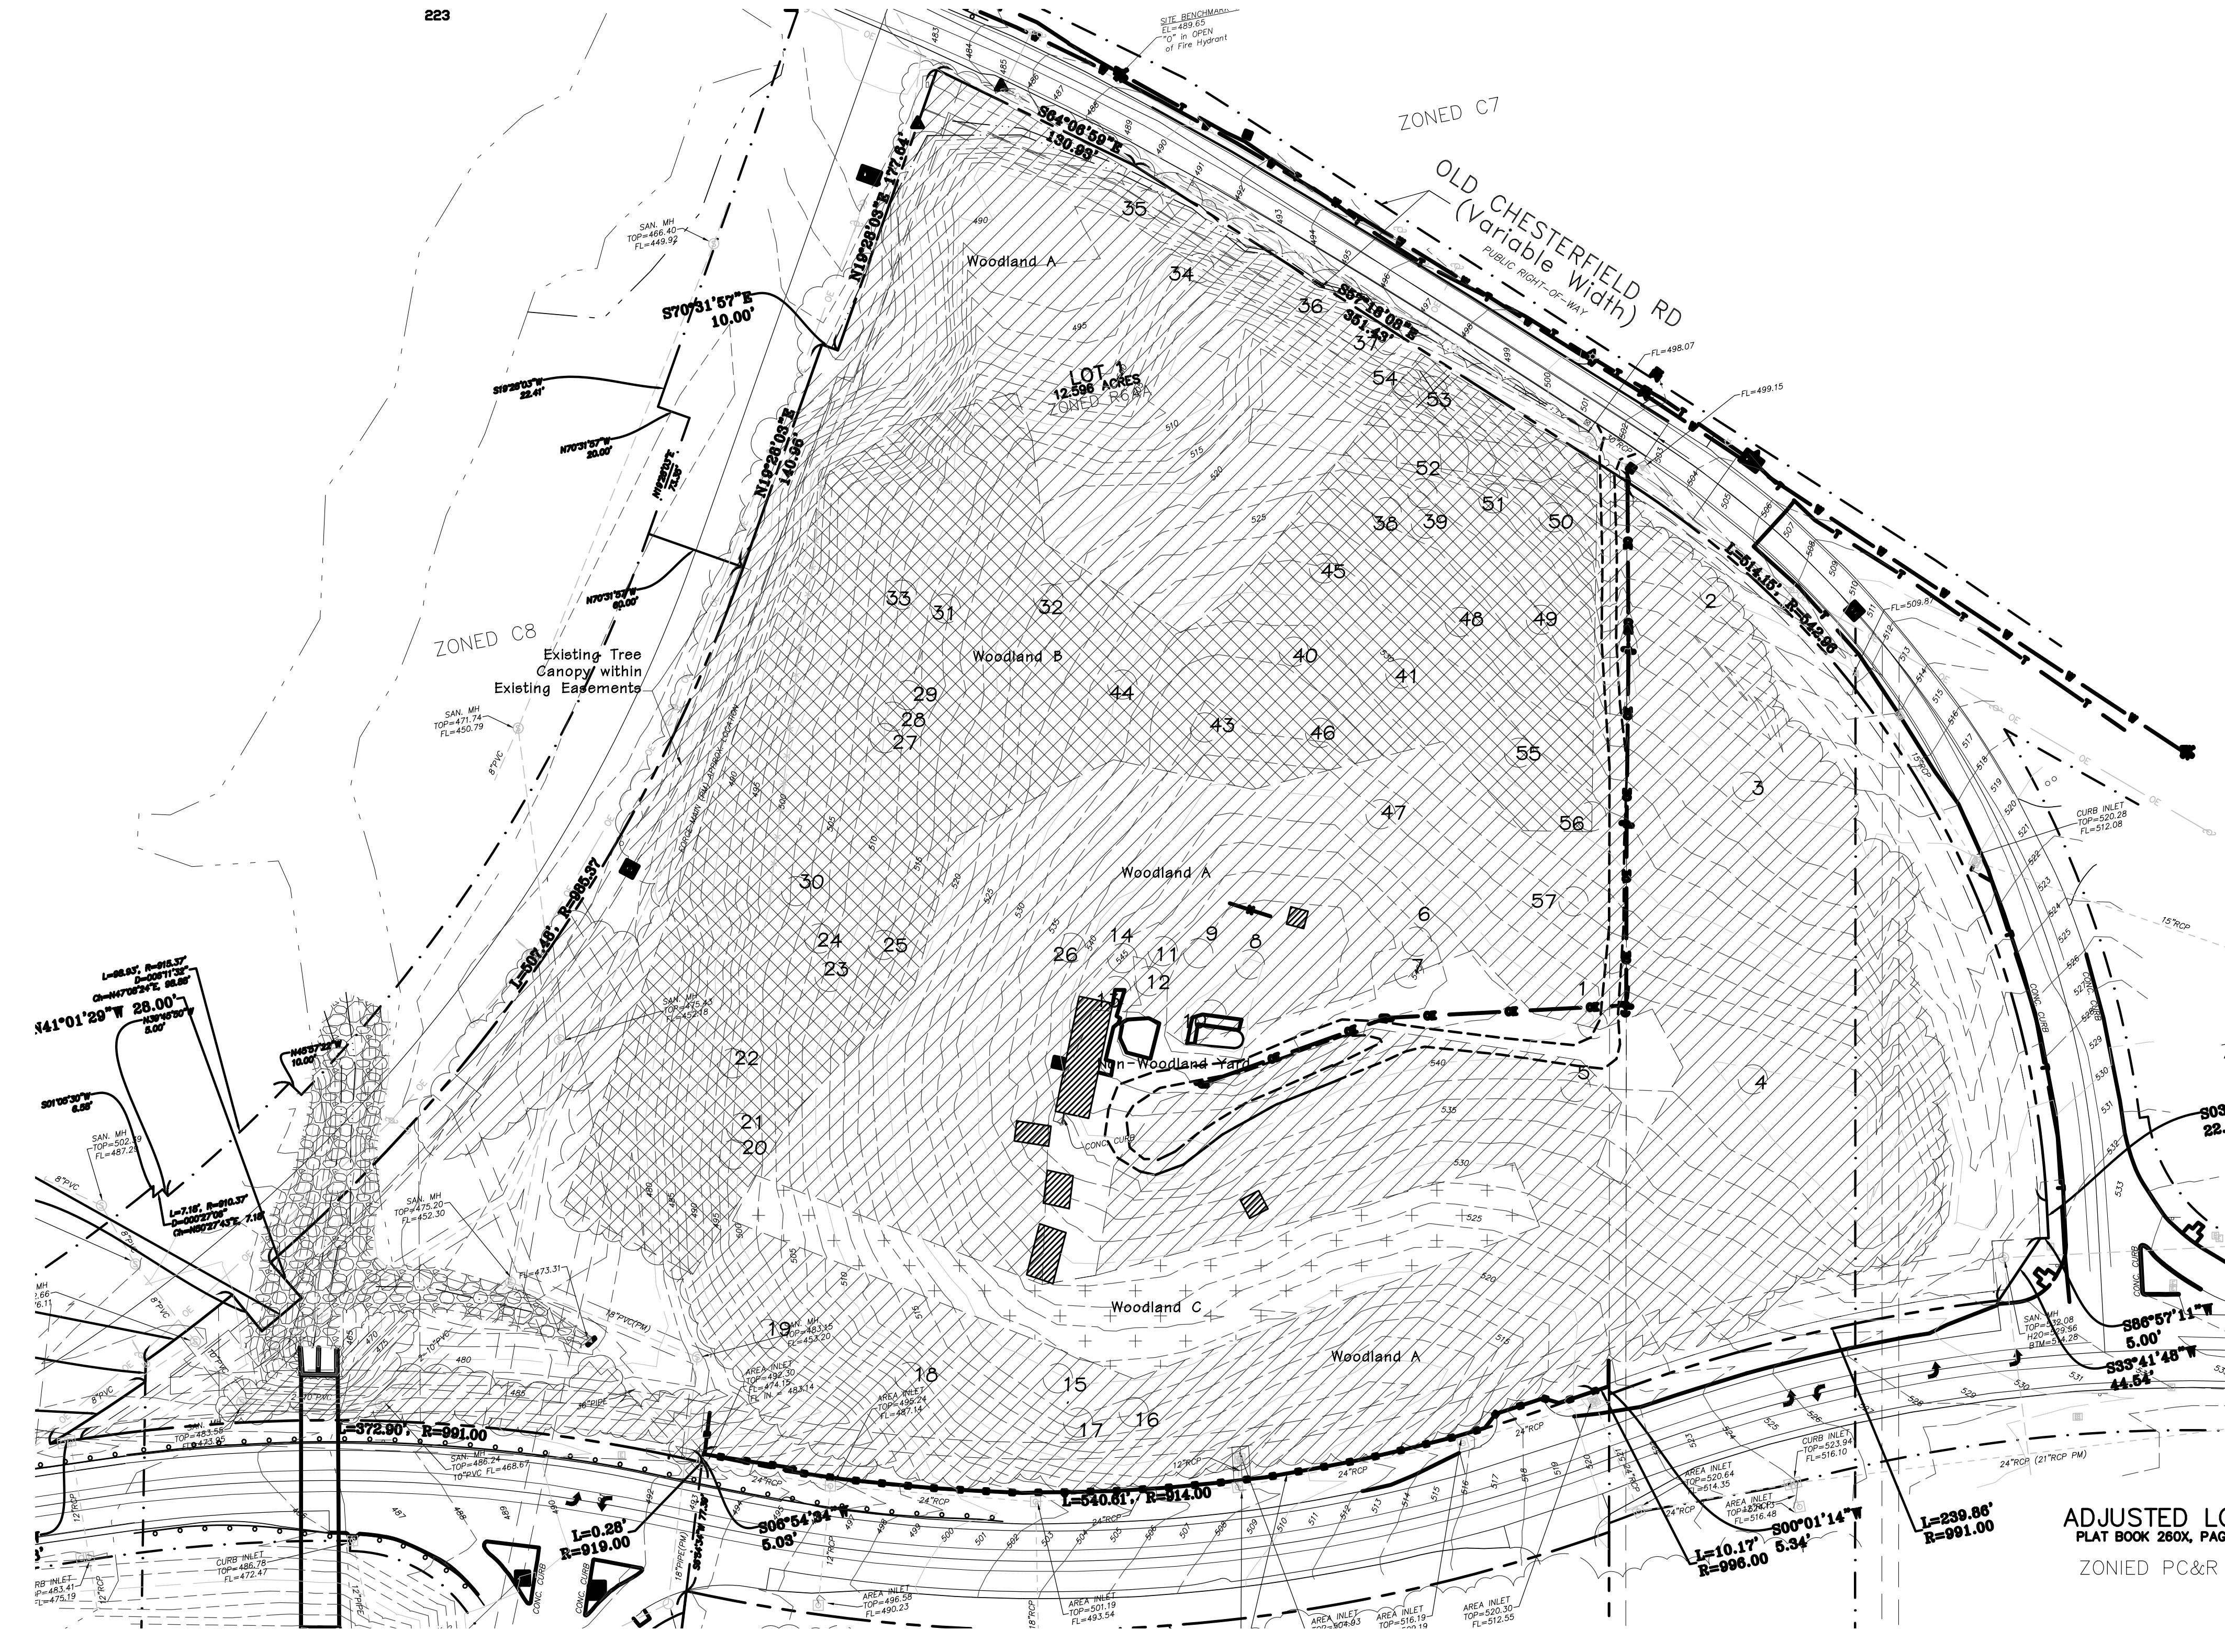

Tree Stand Delineation

Scale: 1"=60'

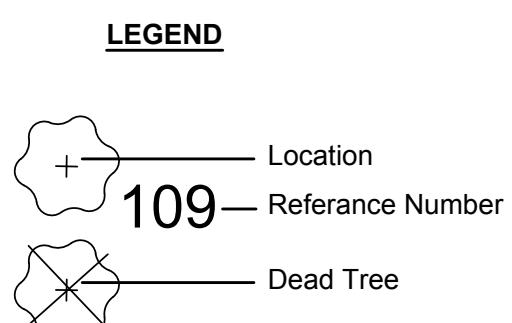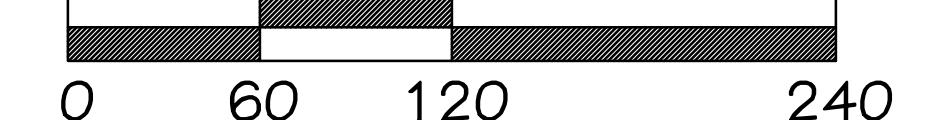

Tree Stand Delineation Narrative

September 13, 2017

The overall Lot comprises a total of 12.6 Ac and has a total of 10.4 AC of Woodlands. The attached detailed Tree Stand Delineation map was completed by field inspection.

Woodland A: A majority of the site is young woodland that has signs of past disturbance. Overstory is a mix of oak species, sugar maple, silver maple, hackberry, and a few of the planted white pine. Understory varies from thick honeysuckle to elm and maple. This woodland covers acreage north of Wild Horse Creek Road. Part of it encompasses an area of old field near the gazebo that now is grown up in to young woodland. Average stand diameter is 12" DBH.

Woodland B: A high-quality hardwood stand with scattered large diameter oaks and sugar maple. While some exceed 20" DBH they do not meet criteria to be classified as Monarch trees. Overstory is white oak, red oak, black oak, sugar maple, and sugar maple. Understory was sparse due to dense canopy with very little honeysuckle intrusion. Average overstory diameter is 16" DBH.

Woodland C: Pine Plantings. Remnants of a double row of white pines are still present. Most have declined and have received no maintenance. Crown dieback and branch death is extensive. Some still have decent health and might add to the project. The remainder are in poor condition. Average diameter is 12" DBH.

Non-Woodland Yard Area: An abandoned yard area with no salvageable trees. The area is thick with small diameter volunteer saplings and is comprised of impervious surfaces such as the house, outbuildings, roadway, and pool.

WOODLAND A = 7.2 Ac. (315,560.3 sq. ft.)
WOODLAND B = 2.9 Ac. (128,016.7 sq. ft.)
WOODLAND C = 0.6 Ac. (21,439.0 sq. ft.)

Total Existing Canopy 10.7 Ac (465,016.0 sq. ft.)

Existing Canopy in Existing Easements: (35,580.0 sq. ft.)

Net Canopy: (429,436.0 sq. ft.)

Tree Stand Delineation Prepared under direction of Skip Kincaid of Hansen's Tree Service Certified Arborist MW-0155BW

Base Map Provided by: Grimes Consulting

Date	Description	No.
11/12/17	City Comments	1
9/20/18	Amended	2

Drawn: BAD
Checked: DAD

DeLong Landscape Architecture, LLC
7620 West Bruno Ave
St. Louis, MO 63117
(314) 346-4856
delong.la@gmail.com

Missouri State Certificate of Authority #2013000145

Sheet No.	Amended Tree Stand Delineation
TSD-1	

Date: 9/13/2017
Job #: 127.006

N/F
UNION ELECTRIC COMPANY
BOOK: 9515, PAGE: 312
16618 OLD CHESTERFIELD RD
Parcel #17T310467

N/F
ST LOUIS COUNTY CATHOLIC
CHURCH REAL ESTATE
BOOK: 17765, PAGE: 4123
16579 WILD HORSE CREEK RD
Parcel #18T630162

N/F
ST LOUIS COUNTY CATHOLIC CHURCH REAL
ESTATE
BOOK: 17765, PAGE: 4123
16575 WILD HORSE CREEK RD
Parcel #187630052 /



Statistics					
Description	Symbol	Avg	Max	Min	Max/Min
Bike Rack	+	0.7 fc	2.9 fc	0.1 fc	29:0.1
Parking Lot	-	1.8 fc	5.1 fc	0.2 fc	25:5.1
Roadway	◇	0.4 fc	2.8 fc	0.0 fc	N/A
Sidewalk 1	+	1.4 fc	3.8 fc	0.2 fc	18:0.1
Sidewalk 2	+	1.0 fc	3.2 fc	0.0 fc	N/A

LIGHT FIXTURE SCHEDULE

LIGHT FIXTURE SCHEDULE								
FIXT. TYPE	MANUFACTURER	CATALOG NO.	QTY	VOLTS	WATTS	#	LAMP(S)	FINISH
A	KICHLER	49550BKTLED	2	120	8	-	LED, 3000'K	TEXTURED BLACK
CP	MAXIM LIGHTING	57714	42	120	20	-	LED, 3000'K	WHITE
EE	KICHLER	49624BKTLED	19	120	17	-	LED, 3000'K	TEXTURED BLACK
R2	EATON PREVAIL	PRV-A25-D-UNV -T2-SA-BK	7	120	87	-	LED, 4000'K	BLACK
R4	EATON PREVAIL	PRV-A25-D-UNV -T4-SA-BK	6	120	87	-	LED, 4000'K	BLACK
T1	EATON PREVAIL	PRV-A25-D-UNV -T4-SA-BK	4	120	87	-	LED, 4000'K	BLACK
T2	EATON PREVAIL	PRV-A25-D-UNV -T4-SA-BK	25	120	87	-	LED, 4000'K	BLACK
T3	EATON PREVAIL	(2)PRV-A25-D-U NV-T4-SA-BK	3	120	180	-	LED, 4000'K	BLACK
WP	EATON MCGRAW- EDISON	ISC-AF-55-LED -E1-T3-BK-CWB	9	120	20	-	LED, 4000'K	BLACK
								WALLPACK, BATTERY PACK


GENERAL NOTES

- 1 ALL ELECTRIC LIGHTING SHALL BE CONTROLLED AUTOMATICALLY BY PHOTOELECTRIC CELLS. STREET AND RESIDENTIAL LIGHTING SHALL BE ON FROM DUSK TO DAWN.
 - 2 THE SOURCE OF ILLUMINATION SHALL NOT BE LOWER THAN TEN (10) FEET ABOVE GRADE.
 - 3 MOUNTING HEIGHTS OF LIGHTING FIXTURES SHALL NOT EXCEED TWENTY (20) FEET.



Aventura at Wild Horse Creek

JIM E. PARKER - ARCHITECT OF RECORD
MISSOURI LICENSE # A-005136
Parker Associates Tulsa, LLC
2202 East 49th Street South,
Suite 200
Tulsa, OK 74105
(918) 749-2485

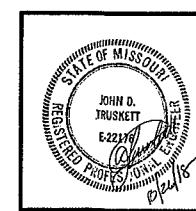

JOB NUMBER: 000000
DRAWN BY: JT/AC/RL/DM/DB/SN
DATE: 10/26/2018

Mechanical • Electrical • Energy SHEET NUMBER SL1 OF 3
OF

WAFER LED I SURFACE MOUNT

TYPE CP

57710 / 57712 / 57714

- Die Cast Aluminum
- Size options between 5", 7" and 10"
- Ultra thin 0.5" H
- Approved for use in closets and storage spaces
- Available in White (WT), Bronze (BZ), and Satin Nickel (SN)
- Triac Dimmable with Electronic Low Voltage Dimmers
- Easy to install: fits in 3.25" and 4" Outlet Box
- Edge-Lit LED Technology
- Suitable for Wet Location
- ETL/cETL IP65

Job Name : _____
 Job Type : _____
 Quantity : _____
 Comments : _____

PRODUCT DESCRIPTION

Wafer was designed for the discriminating consumer who wants the low profile look of recessed without the high cost. Manufactured of die cast aluminum, Wafer brings ultimate heat dissipation to its edge lit technology. Edge lighting gives very even light distribution while dispersing heat over a larger area. The result of this is longer LED life and better light diffusion.

FINISHES OPTIONS:

White (WT)
 Bronze (BZ)
 Satin Nickel (SN)

MEASUREMENTS

MODEL DIMENSION	
57710	5"D x 0.5"H
57712	7"D x 0.5"H
57714	10"D x 0.5"H

HANGING WEIGHT
0.88 lb
1.21 lb
1.75 lb

MATERIAL:

Die Cast Aluminum
 PMMA Acrylic Diffuser

AVAILABLE SIZES:

5" | 7" | 10"

RATINGS:

ETL/cETL IP65
 Wet Location
 Energy Star
 CA Title 24
 ADA

LAMPING

MODEL	BULB TYPE	CRI	LUMENS	COL. TEMP.	DIMMABLE	INPUT	
57710	10W PCB LED (Integrated)	90+	700	3000K	ELV	120V	
57712	15W PCB LED (Integrated)	90+	1050	900	3000K	ELV	120V
57714	20W PCB LED (Integrated)	90+	1400	1200	3000K	ELV	120V

ADDITIONAL:

RATED LIFE: 50,000 Hours
 OPERATING TEMP: -20° C (-4°), 40° C (104° F)
 PHOTOMETRIC Report Found On "re"

Always consult a qualified electrician before installing any lighting product

WESTERN DISTRIBUTION CENTER (HEADQUARTER)
 253 NORTH VINELAND AVE | CITY OF INDUSTRY, CA 91746

EASTERN DISTRIBUTION CENTER
 4200 SHIRLEY DR. | ATLANTA, GA 30336

P: 626.956.4200 | F: 626.956.4225 | maximlighting.com

Amber Valley Collection

Amber Valley Large LED Wall Lantern BKT

49624BKTLED (Textured Black)

TYPE EE



Dimensions

Height	17.25"
Width	8.75"

Project Name: _____

Location: _____

Type: _____

Qty: _____

Comments: _____

Ordering Information

Product ID	49624BKTLED
Finish	Textured Black
Collection	Amber Valley Collection

Dimensions

Extension	10.00"
Height from center of Wall opening	9.75"
Base Backplate	6.25 X 9.00
Weight	7.14 LBS

Photometrics

Kelvin Temperature	3000 K
Color Rendering Index	90

Specifications

Material	Aluminum
Diffuser Description	Etched Seeded

Electrical

Dimmable	Yes
Dimmable Notes: This LED is compatible with most standard incandescent dimmers, LED dimmers, and electronic low voltage dimmers. For more information, go to Kichler.com/dimming .	
Voltage	120 V
Input Voltage	Single(120)

Qualifications

Safety Rated	Wet
Title 24	Yes
Expected Life Span	40000 Hours
Warranty	www.kichler.com/warranty

Primary Lamp

Light Source	LED
Lamp Included	Integrated
# of Bulbs/LED Modules	1
Delivered Lumens	875
Initial Lumens	1400
Delivered Efficacy	51

Notes:

- 1) Information provided is subject to change without notice.
A. values are design or typical values when measured under laboratory conditions.
- 2) Incandescent Equivalent: The incandescent equivalent is presented as an approximate number and is for reference only.

Kichler
7701 East Pleasant Valley Road
Cleveland, Ohio 44131-8010
Tel free: 866.500.5701 or kichler.com

KICHLER

Amber Valley Collection

Amber Valley Large LED Wall Lantern BKT

49624BKTLED (Textured Black)

Project Name:	_____
Location:	_____
Type:	_____
Qty:	_____
Comments:	_____

Max or Nominal Watt	17W
Dimming	Yes

Kichler
7701 East Pleasant Valley Road
Cleveland, Ohio 44131-3010
Toll free: 800.568.5705 or Kichler.com

Notes:

- 1) Information provided is subject to change without notice.
All values are design or typical values when measured under laboratory conditions.
- 2) Incandescent Equivalent: The incandescent equivalent as presented is an approximate number and is for reference only.

KICHLER

page 3

PRV PREVAIL

LUMEN MAINTENANCE

Ambient Temperature	25,000 Hours ^a	50,000 Hours ^a	60,000 Hours ^a	Theoretical 100,000 Hours	Theoretical L ₇₀ (Hours) ^a
25°C	> 96%	> 93%	> 92%	> 87%	> 280,000
40°C	> 96%	> 93%	> 92%	> 87%	> 255,000
50°C	> 96%	> 92%	> 91%	> 86%	> 250,000

^a Per IESNA TM-2nd data.

LUMEN MULTIPLIER

Ambient Temperature	Lumen Multiplier
10°C	1.03
15°C	1.01
25°C	1.00
40°C	0.99

Hours (Thousands)	25°C (%)	40°C (%)	50°C (%)
0	100	100	100
10	98	96	94
20	96	93	90
30	94	91	88
40	92	89	86
50	90	87	84
60	88	85	82
70	86	83	80
80	84	81	78
90	82	79	76
100	80	77	74

ORDERING INFORMATION

Sample Number: PRV-A15-D-UNV-T3-SA-BZ

Product Family ^b	Light Engine ^c	Driver ^d	Voltage	Distribution	Mounting	Color ^e
PRV=Prevail	A11=(1 LED) 6,100 Nominal Lumens A22=(2 LEDs) 10,200 Nominal Lumens A40=(2 LEDs) 15,100 Nominal Lumens A80=(2 LEDs) 18,900 Nominal Lumens	D=Dimming (0-10V)	UNV=Universal (120-277V) 347=347V 480=480V ^f	T2=Type II T3=Type III T4=Type IV T5=Type V	SA=Standard Versatile Arm MA=Mount Arm WM=Wall Mount Arm	AP=Grey BZ=Bronze (Standard) BK=Black DP=Dark Platinum GM=Graphite Metallic WH=White
Options (Add as Suffix)						
7030=70 CRI / 3000K CCT ^g 7050=70 CRI / 5000K CCT ^g 13IG=10kV/10kA UL 1446 Fused Surge Protective Device LWR-LW=LumaWatt Pro Wireless Sensor, Wide Lens for 8' - 18' Mounting Height ^h LWR-LN=LumaWatt Pro Wireless Sensor, Narrow Lens for 18' - 40' Mounting Height ^h MSP/DIM-L12=Integrated Sensor for Dimming Operation, 8' - 12' Mounting Height MSP/DIM-L20=Integrated Sensor for Dimming Operation, 12' - 30' Mounting Height MSP-L12=Integrated Sensor for ON/OFF Operation, 8' - 12' Mounting Height MSP-L30=Integrated Sensor for ON/OFF Operation, 12' - 30' Mounting Height PER-NEMA 3-PIN Twistlock Photocontrol Receptacle ⁱ PER7-NEMA 7-PIN Twistlock Photocontrol Receptacle ⁱ HSS=House Side Suffix HA=50°C High Ambient Temperature L90=Optics Rotated 90° Left R90=Optics Rotated 90° Right						
Accessories (Order Separately)^j						
PRVWYM-XX=Wall Mount Kit PRVMA-XX=Mount Arm Mounting Kit PRVSA-XX=Standard Arm Mounting Kit HS/VERD=House Side Shield MA1010-XX=Single Tenon Adapter for 3-1/2" O.D. Tenon MA1011-XX=2 3/8" 80° Tenon Adapter for 3-1/2" O.D. Tenon MA1012-XX=2 3/8" 20° Tenon Adapter for 3-1/2" O.D. Tenon MA1013-XX=2 3/8" 80° Tenon Adapter for 3-1/2" O.D. Tenon MA1014-XX=2 3/8" 80° Tenon Adapter for 3-1/2" O.D. Tenon MA1015-XX=2 3/8" 20° Tenon Adapter for 3-1/2" O.D. Tenon MA1016-XX=2 3/8" 80° Tenon Adapter for 3-1/2" O.D. Tenon MA1017-XX=Single Tenon Adapter for 2-3/8" O.D. Tenon MA1018-XX=2 3/8" 80° Tenon Adapter for 2-3/8" O.D. Tenon MA1019-XX=2 3/8" 20° Tenon Adapter for 2-3/8" O.D. Tenon MA1048-XX=2 3/8" 80° Tenon Adapter for 2-3/8" O.D. Tenon MA1049-XX=2 3/8" 80° Tenon Adapter for 2-3/8" O.D. Tenon MA1049-XX=2 3/8" 80° Tenon Adapter for 2-3/8" O.D. Tenon MA1131-XX=2 3/8" 20° Tenon Adapter for 2-3/8" O.D. Tenon CA/RA1013=Photocontrol Shunting Cap CA/RA1014=NEMA Photocontrol - 120V CA/RA1024=NEMA Photocontrol - Multi-Tap 105-280V CA/RA1027=NEMA Photocontrol - 480V CA/RA1291=NEMA Photocontrol - 347V ISHH-01=Integrated Sensor Programming Remote						

NOTES

1. Customer is responsible for engineering analysis to confirm pole and fixture compatibility for all applications. Refer to Installation Instructions: IS0000284 and pole white paper WP01265 EN for additional support information.

2. DesignLights Consortium® Qualified and classified for DLC Standard, refer to www.designlights.org for details.

3. Standard 3000K CCT and 70 CRI.

4. Consult factory for driver surge protection values.

5. Only for use with 480V Wye systems. Per NEC, not for use with ungrounded systems, impedance grounded systems or corner grounded systems (commonly known as Three Phase Three Wire Delta, Three Phase High Leg Delta and Three Phase Corner Grounded Delta systems).

6. Extended housing color in past lumen output. IES files for the non-standard colors are available upon request.

7. Extended lead times apply. Use dedicated IES files for 3000K and 5000K when performing layouts. These files are published on the Prevail luminaire product page on the website.

8. LumaWatt Pro wireless sensors are factory installed and require network components (WF-204-1, WF-40W-1, and WF-40S-1) in appropriate quantities. See website for LumaWatt Pro application information.

9. LumaWatt Pro wireless system is not available with photocontrol receptacles (Not needed).

10. Not available in conjunction with A80 lumen package at HA (High Ambient).

11. Not available with MSP or LWR options.

12. Review XX with paint color.

STOCK ORDERING INFORMATION

Stock Sample Number: PRV8-A25-UNV-T3

Product Family	Light Engine	Voltage	Distribution	Options (Add as Suffix)
PRV8=Prevail	A11=(1 LED) 6,100 Nominal Lumens A22=(2 LEDs) 10,200 Nominal Lumens A40=(2 LEDs) 15,100 Nominal Lumens A80=(2 LEDs) 18,900 Nominal Lumens	UNV=Universal (120-277V) 347=347V 480=480V	T3=Type III T4=Type IV	MSP/DIM-L20=Integrated Sensor for Dimming Operation, Maximum 30' Mounting Height

NOTE: Bronze or 1/2" 4000K CCT, 120-277V, 347V, standard mounting arm, standard non fused 10kV MCV and 3-10V dimming.

Eaton
1121 Highway 74 South
Peachtree City, GA 30269
P: 770-468-4800
www.eaton.com/lighting

Specifications and dimensions subject to change without notice.

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PRV PREVAL

VERBATEL MOUNT SYSTEM

POLE MOUNT ARM

WALL MOUNT

MAST ARM MOUNT

MOUNTING CONFIGURATIONS AND EPAs

Wall Mount

Arm Mount Single
EPA 0.75

Arm Mount 2 @ 180°
EPA 1.60

Arm Mount 2 @ 90°
EPA 1.60

Arm Mount 3 @ 90°
EPA 2.25

Arm Mount 4 @ 90°
EPA 3.00

OPTICAL CONFIGURATIONS

A15 (6,100 Nominal Lumens)

A25/A45/A60 (10,200/15,100/18,000 Nominal Lumens)

POWER AND LUMENS

Light Engine	A15	A25	A40	A60
Nominal Power (Watts)	57W	87W	143W	163W
Input Current @ 120V (A)	0.48	0.76	1.23	1.34
Input Current @ 277V (A)	0.22	0.36	0.54	0.60
Input Current @ 347V (A)	0.18	0.28	0.48	0.49
Input Current @ 480V (A)	0.13	0.21	0.33	0.38
Type II	Lumens: 6,139 BUG Rating: B1-U0-G1	Lumens: 10,204 BUG Rating: B2-L0-G2	Lumens: 15,373 BUG Rating: B3-U0-G3	Lumens: 18,880 BUG Rating: B3-U0-G3
Type III	Lumens: 8,192 BUG Rating: B1-U0-G2	Lumens: 10,292 BUG Rating: B2-L0-G3	Lumens: 15,203 BUG Rating: B3-U0-G4	Lumens: 18,982 BUG Rating: B3-U0-G4
Type IV	Lumens: 8,173 BUG Rating: B1-U0-G3	Lumens: 10,281 BUG Rating: B2-L0-G3	Lumens: 15,187 BUG Rating: B2-U0-G4	Lumens: 18,936 BUG Rating: B2-U0-G4
Type V	Lumens: 8,323 BUG Rating: B3-U0-G2	Lumens: 10,327 BUG Rating: B4-L0-G3	Lumens: 15,087 BUG Rating: B4-U0-G4	Lumens: 18,810 BUG Rating: B4-U0-G4

Note: Lumen output for standard bronze fixture color. Different housing colors impact lumen output.
IES files for the non-standard colors are available upon request.

EATON
Power Business Worldwide

121 Highway 74 South
Results City, GA 30236
P: 770.488.4800
www.eaton.com/lighting

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TYPE T1,T2,R1,R2

Lumark

DESCRIPTION

The Prevail LED area, site luminaire combines optical performance, energy efficiency and long term reliability in an advanced, patent pending modern design. Utilizing the latest LED technology, the Prevail luminaire delivers unparalleled uniformity resulting in greater pole spacing. A versatile mount standard arm facilitates ease of installation for both retrofit and new installations. With energy savings greater than 62%, the Prevail fixture replaces 150-480W metal halide fixtures in general area lighting applications such as parking lots, walkways, roadways and building areas.

SPECIFICATION FEATURES

Construction

Construction is comprised of a heavy-duty, single-piece die-cast aluminum housing. The LED drivers are mounted in direct contact with the casting to promote low operating temperature and long life. The die-cast aluminum door is tethered to provide easy access to the driver if replacement is required. A one-piece silicone gasket seals the door to the fixture housing. The optics is mounted on a versatile, aluminum plate that dissipates heat from the LEDs resulting in longer life of the fixture. The fixture is IP68 and 3G vibration rated (ANSI C136.31) to insure strength of construction and longevity in the selected application.

Optics

Precision molded, high efficiency optics are precisely designed to shape the distribution, maximizing efficiency and application spacing. Available in Type II, III, IV and V distributions with lumen packages ranging from 6,100 to 18,800 nominal lumens. Light engine configurations consist of 1 or 2 high-efficacy LEDs mounted to metal-core circuit boards to maximize heat dissipation and promote long life (up to L82/60,000 hours at 25°C) per IESNA TM-21. For the ultimate level of spill light control, an optional house side shield accessory can be field or factory installed.

Electrical

LED drivers are mounted to the fixture for optimal heat sinking and ease of maintenance. Thermal management incorporates both conduction and convection to transfer heat rapidly away from the LED source for optimal efficiency and light output. Class 1 electronic drivers have a power factor >90%, THD <20%, and an expected life of 100,000 hours with <1% failure rate. Available in 120-277V 50/60Hz, 347V 60Hz or 480V 60Hz operation. 480V is compatible for use with 480V Wye systems only. 10kV/10 kA surge protection standard. 0-10V dimming driver is standard with leads external to the fixture to accommodate controls capability such as dimming and occupancy. Suitable for ambient temperatures from -40°C to 40°C. Optional 50°C HA (high ambient) available. Standard NEMA 3-PIN twistlock photocell receptacle and NEMA 7-PIN twistlock photocell receptacles are available as options.

Controls

The Prevail LED luminaire control options are designed to be simple and cost-effective ASHRAE and California Title 24 compliant solutions. The ANSI C136.41 compliant NEMA 7-PIN receptacle enables wireless dimming when used with compatible photocell. An integrated dimming and occupancy sensor is a standalone control option available in on/off (MSP) and bi-level dimming

Catalog #	Type
Project	
Comments	Date
Prepared by	

(MSP/DIM) operation. The optional LumaWatt Pro system is best described as a peer-to-peer wireless network of luminaire-integral sensors that operate in accordance with programmable profiles. Each sensor is capable of motion and photo sensing, metering power consumption and wireless communication.

Mounting

Standard pole mount arm is bolted directly to the pole and the fixture slides onto the arm and locks in place with a bolt facilitating quick and easy installation. The versatile, patented, standard mount arm accommodates multiple drill patterns ranging from 1-1/2" to 4-7/8". Removal of the door on the standard mounting arm enables wiring of the fixture without having to access the driver compartment. A knock-out on the standard mounting arm enables round pole mounting. Wall mount and mast arm mounting options are available. Mast arm adapter fits 2-3/8" O.D. tenon.

Finish

Housing and cast parts finished in five-stage super TGIC polyester powder coat paint, 2.5 mil nominal thickness for superior protection against fade and wear. Standard color is bronze. Additional colors available in white, gray, black, dark platinum and graphite metallic.

Warranty

Five-year warranty.

PRV PREVAIL

LED

AREA / SITE / ROADWAY
LUMINAIRE

CERTIFICATION DATA

UL and cUL Wet Location Listed
IP68-Rated
3G Vibration Rated
ISO 9001
DesignLights Consortium® Qualified

ENERGY DATA

Electronic LED Driver
0.8 Power Factor
<20% Total Harmonic Distortion
120-277V/50 and 60 Hz,
347V/60Hz, 480V/60-Hz
-40°C Min. Ambient Temperature Rating
+40°C Ambient Temperature Rating

EPA

Effective Projected Area (Sq. Ft.): 0.75

SHIPPING DATA


Approximate Net Weight:
23 lbs. (10.06 kgs.)

DIMENSIONS

EATON
Power Business Worldwide

*www.design-lights.org

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May 18, 2018 11:58 AM
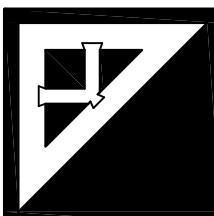
<h1>Aventura at Wild Horse Creek</h1> <hr/> <p>Chesterfield, Missouri</p>									
									
<p>JIM E. PARKER – ARCHITECT OF RECORD MISSOURI LICENSE # A-005136</p> <p>Parker Associates Tulsa, LLC 2202 East 49th Street South, Suite 200 Tulsa, OK 74105 (918)-742-2485</p>									
 <p>2202 East 49th, Suite #100 Tulsa, Oklahoma 74105 Phone (918) 743-4419 Fax (918) 743-4469</p> <p>Consulting Engineering Mechanical • Electrical • Energy</p>	<p>JOB NUMBER: 000000 DRAWN BY: JT/AC/RL/DM/DB/SN DATE: 06/14/2018</p> <table border="1" style="width: 100%; border-collapse: collapse;"> <tr><td style="height: 20px;"></td><td style="height: 20px;"></td></tr> </table> <p>SHEET NUMBER SL2 OF 2 OF</p>								

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ISC/ISS/IST/ISW IMPACT ELITE _LED

ORDERING INFORMATION

Sample Number: ISC-AF-1200-LED-E1-T3-32

Product Family ¹	Light Engine	Drive Current	Lamp Type	Voltage	Distribution	Color
ISC=Impact Elite LED Small Cylinder ISS=Impact Elite LED Small Quarter Sphere IST=Impact Elite LED Small Trapezoid ISW=Impact Elite LED Small Wedge	AF-(1) Light Square	300=Drive Current Factory Set to 300mA 450=Drive Current Factory Set to 450mA 600=Drive Current Factory Set to 600mA 800=Drive Current Factory Set to 800mA 1000=Drive Current Factory Set to 1000mA 1200=Drive Current Factory Set to 1200mA ²	LED=Solid State Light Emitting Diode	E1=Electronic (120-277V) 347=347V ³ 480=480V ⁴	T2=Type II T3=Type III T4FT=Type IV Forward Throw T4W=Type IV Wide SL2=Type I w/Spill Control SL3=Type III w/Spill Control SL4=Type IV w/Epi I Control SL5=90° Spill Light EL=Eliminator Left SLR=90° Spill Light EL=Eliminator Right RW=Rectangular Wedge Type I	AP=Grey BZ=Bronze BK=Black DP=Dark Platinum GM=Graphite Metallic WH=White
Options (Add as Suffix)						Accessories (Order Separately) ⁵
7030=70 CR / 3000K CCT ⁶ 7060=70 CR / 5000K CCT ⁶ 7080=70 CR / 5730K CCT ⁶ 8030=80 CR / 5000K CCT ⁶ PER7=NEMA 7-PIN "Twistlock Photocontrol Receptacle" ⁷ P=Button Type Photocontrol (Available in 120, 208, 240 or 277V. Must Specify Voltage) ⁸ HA=50°C High Ambient ⁹ AHD145=After Hours Dim, 5 Hours, 50% ¹⁰ AHD245=After Hours Dim, 8 Hours, 50% ¹⁰ AHD255=After Hours Dim, 7 Hours, 50% ¹⁰ AHD355=After Hours Dim, 8 Hours, 50% ¹⁰ MB/DIM-LXX=Motion Sensor for Dimming Operation ¹¹ LWR-LW=LumaWatt Pro Wireless Sensor, Wide Angle for 8'-16' Mounting Height ¹² LWR-LN=LumaWatt Pro Wireless Sensor, Narrow Lens for 18'-40' Mounting Height ¹² BBB=Battery Pack with Back Box (Specify 120V or 277V) ¹³ CWB=Cold Weather Battery Pack with Back Box (Specify 120V or 277V) ¹⁴ LCP=LightSquar Trim Plate Matches Housing Finish HSS=Factory Installed House Side Shield ¹⁵ ULG=Uplight Blow ¹⁶ TR=Temper Resistant Hardware X=Driver Surge Protection (6kV) On y ¹⁷						

NOTES:

1. Standard 4000K CCT and greater than 70 CRI.
2. Not available with ULG option.
3. Only for use with 480V Wye systems. Per NEC, not for use with ungrounded systems, impedance grounded systems or active grounded systems (commonly known as Three Phase Three Wire Delta, Three Phase -Lightning Delta or Three Phase Grounded Delta systems).
4. Specified lead time is apply.
5. Not available with 120V or 24W.
6. Not available with LWR-XX or MB/DIM-LXX.
7. Available for 90°C provided no more than two screws are included and driver current is set to 1.0 or less.
8. Requires the use of P protocol or the PEP protocol control message with photocontrol accessory. Not available with 350mA drive current. See After Hours Dim Supplemental guide for additional information.
9. Specify lens in place of XX. Round to next highest option based on mounting height. Available options are 08, 20 and 40%.
10. The PWL-100 configuration tool is required to adjust parameters including high and low modes, sensitivity, time delay, cutoff and more. Contact your lighting representative at Eaton for more information.
11. Includes integral photocell.
12. LumaWatt Pro wireless sensor is factory tested and requiring network com coverage in appropriate quantities. See www.eaton.com/lighting for LumaWatt Pro application information.
13. LBC aware. Integral battery pack is rated for minimum operating temperature 32°F (-16°C). Operate above 50°F (10°C) for 90-minutes.
14. LBC cold weather integral battery pack is rated for minimum operating temperature -4°F (-20°C). Operate below 32°F (0°C) for 90-minutes.
15. Only for use with SL2, SL3 and SL4 distributions. The LightSquare trim plate is painted black w/ an RBS option is selected.
16. Removes additional surge module.
17. Specify color in place of XX.

Eaton
 121 Highway 74 South
 反射 City, GA 30268
 P: 770.488.4800
www.eaton.com/lighting

Specifications and
 dimensions subject to
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ISC/ISS/IST/ISW IMPACT™ ELITE LED

POWER AND LUMENS

1 LightSquare (AF)			Cylinder (IBC) and Quarter Sphere (ISB)						Trapezoid (IST) and Wedge (ISW)					
Drive Current (mA)			350	450	600	800	1000	1200	350	450	600	800	1000	1200
Power (Watts)	120-277V		20.3	26.5	38.4	43.6	56.1	68.2	20.3	26.5	38.4	43.6	56.1	68.2
Current (A)	120V		0.17	0.22	0.28	0.38	0.48	0.58	0.17	0.22	0.28	0.38	0.48	0.58
	277V		0.08	0.10	0.13	0.17	0.21	0.25	0.09	0.10	0.13	0.17	0.21	0.25
Power (Watts)	247V ± 480V		23.3	28.7	38.8	48.8	60.7	70.1	23.3	28.7	38.8	48.8	60.7	70.1
Current (A)	347V		0.07	0.08	0.11	0.16	0.19	0.21	0.07	0.08	0.11	0.16	0.18	0.21
	480V		0.06	0.06	0.08	0.11	0.13	0.16	0.06	0.06	0.11	0.13	0.16	0.18
Options														
T2	Lumens		3,338	3,934	3,827	4,791	5,863	6,444	2,488	3,138	4,091	5,123	6,054	6,989
	BUG Rating		B1-U0-G1	B1-U0-G1	B1-U0-G1	B1-U0-G1	B1-U0-G1	B1-U0-G1	B1-U1-G2	B1-U1-G2	B1-U1-G2	B1-U1-G2	B1-U1-G2	B1-U1-G2
T3	Lumens		2,385	2,994	3,006	4,899	5,779	6,577	2,504	3,144	4,107	5,133	6,058	6,906
	BUG Rating		B1-U0-G1	B1-U0-G1	B1-U0-G1	B1-U0-G1	B1-U0-G1	B1-U0-G1	B1-U1-Q2	B1-U1-Q2	B1-U1-Q2	B1-U1-Q2	B1-U1-Q2	B1-U1-Q2
T4/T	Lumens		3,330	3,933	3,888	4,838	5,720	6,509	2,530	3,177	4,145	5,188	6,133	6,979
	BUG Rating		B1-U0-G1	B1-U0-G1	B1-U0-G1	B1-U0-G1	B1-U0-G1	B1-U0-G1	B1-U1-Q2	B1-U1-Q2	B1-U1-Q2	B1-U1-Q2	B1-U1-Q2	B1-U1-Q2
T4W	Lumens		2,388	2,988	3,008	4,882	5,783	6,581	2,500	3,138	4,068	5,128	6,068	6,900
	BUG Rating		B1-U0-G1	B1-U0-G1	B1-U0-G1	B1-U0-G1	B1-U0-G1	B1-U0-G1	B1-U1-Q2	B1-U1-Q2	B1-U1-Q2	B1-U1-Q2	B1-U1-Q2	B1-U1-Q2
SL2	Lumens		2,267	2,834	3,897	4,898	5,470	6,225	2,413	3,030	3,963	4,948	5,845	6,656
	BUG Rating		B1-U0-G1	B1-U0-G1	B1-U0-G1	B1-U0-G1	B1-U0-G1	B1-U0-G1	B1-U1-Q2	B1-U1-Q2	B1-U1-Q2	B1-U1-Q2	B1-U1-Q2	B1-U1-Q2
SL3	Lumens		3,220	3,787	3,838	4,882	5,386	6,122	2,368	2,870	3,874	4,849	5,732	6,523
	BUG Rating		B1-U0-G1	B1-U0-G1	B1-U0-G1	B1-U0-G1	B1-U0-G1	B1-U0-G1	B1-U1-Q2	B1-U1-Q2	B1-U1-Q2	B1-U1-Q2	B1-U1-Q2	B1-U1-Q2
SL4	Lumens		2,110	2,848	3,458	4,328	5,113	5,815	2,234	2,835	3,800	4,881	5,415	6,162
	BUG Rating		B0-U0-G1	B0-U0-G1	B0-U0-G1	B0-U0-G1	B0-U0-G1	B0-U0-G1	B1-U1-Q2	B1-U1-Q2	B1-U1-Q2	B1-U1-Q2	B1-U1-Q2	B1-U1-Q2
SL5/SLR	Lumens		1,980	2,498	3,269	4,080	4,823	5,488	2,184	2,735	3,828	4,418	5,222	5,942
	BUG Rating		B1-U0-G1	B1-U0-G1	B1-U0-G1	B1-U0-G1	B1-U0-G1	B1-U0-G1	B1-U1-Q2	B1-U1-Q2	B1-U1-Q2	B1-U1-Q2	B1-U1-Q2	B1-U1-Q2
RW	Lumens		2,380	2,988	3,898	4,880	5,738	6,564	2,488	3,098	4,037	5,084	5,974	6,798
	BUG Rating		B2-U0-G0	B2-U0-G0	B2-U0-G0	B2-U0-G0	B2-U0-G0	B2-U0-G0	B3-U1-Q1	B3-U1-Q1	B3-U1-Q1	B3-U1-Q1	B3-U1-Q1	B3-U1-Q1

LUMEN MAINTENANCE

Current	Ambient Temperature	25000 Hours*	30000 Hours*	35000 Hours*	40000 Hours*	Theoretical L70 (Hours)*
Up to 1.2A	Up to 40°C	>95%	>91%	>80%	>63%	20,430

*Calculated based on TIR-21 calculator

LUMEN MULTIPLIER

Ambient Temperature	Lumen Multiplier
10°C	1.02
18°C	1.01
28°C	1.00
40°C	0.99

THRUWAY BACK BOX

EATON
Powering Business Worldwide

1121 Highway 74 South
Peachtree City, GA 30269
P: 770.468.4200
www.eaton.com/lighting

Specifications and dimensions are subject to change without notice.

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TYPE WPEM

McGraw-Edison

DESCRIPTION

The Impact Elite family of wall luminaires is the ideal complement to site design. Incorporating modular LightSquares technology, the Impact Elite luminaire provides outstanding uniformity and energy-conscious illumination. Combined with a rugged construction, the Impact Elite luminaire is the ideal facade and security luminaire for zones surrounding schools, office complexes, apartments and recreational facilities. UL/cUL listed for wet locations.

Catalog #	Type
Project	Date
Comments	
Prepared by:	

SPECIFICATION FEATURES

Construction

Heavy-wall, die-cast aluminum housing and removable hinged door frame for precise tolerance control and repeatability. Hinged door inset for clean mating with housing surface and secured via two captive fasteners. Optional tamper-resistant Torx™ head fasteners offer vandal resistant access to the electrical chamber.

Optics

Choice of 10 patented, high-efficiency AccuLED Optics™ distributions. Optics are precisely designed to shape the light output, maximizing efficiency and application spacing. AccuLED Optics technology creates consistent distributions with the scalability to meet customized application requirements. Offered Standard in 4000K (+/- 275K) CCT and minimum 70 CRI. Optional 3000K, 5000K and 5700K CCT.

Electrical

LED drivers mount to die-cast aluminum back housing for optimal heat sinking, operation efficacy, and prolonged life. Standard drivers feature electronic universal voltage (120-277V 50/60Hz), 347V 60Hz or 480V 60Hz operation, greater than 0.9 power factor, less than 20% harmonic distortion, and are suitable for operation in -40°C to 40°C ambient environments. All fixtures are shipped standard with 10kV/10kA common – and differential – mode surge protection. LightSquares feature an IP66 enclosure rating and maintain greater than 80% lumen maintenance at 50,000 hours per IESNA TM-21. Emergency egress options for -20°C ambient environments and occupancy sensor available.

Mounting

Gasketed and zinc plated rigid steel mounting attachment fits directly to 4" J-box or wall with the Impact Elite "Hook-N-Lock" mechanism for quick installation. Secured with two captive corrosion resistant black oxide coated allen head set screws concealed but accessible from bottom of fixture.

Finish

Cast components finished in a five-stage super TGIC polyester powder coat paint, 2.6 mil nominal thickness for superior protection against fade and wear. Standard colors include black, bronze, grey, white, dark platinum and graphite metallic, RAL and custom color matches available. Consult the McGraw-Edison Architectural Colors brochure for the complete selection.

Warranty

Five-year warranty.

ISC/ISS/IST/ISW IMPACT ELITE LED

1 LightSquare
Solid State LED

WALL MOUNT LUMINAIRE

CERTIFICATION DATA

UL/cUL Listed
LM79 / LM80 Compliant
IP66 LightSquare
DesignLights Consortium® Qualified®
ISO 9001

ENERGY DATA

Electronic LED Driver
≥0.9 Power Factor
≤20% Total Harmonic Distortion
120-277V/50 & 60Hz, 347V/60Hz,
480V/60Hz
-40°C Minimum Temperature
40°C Ambient Temperature Rating

SHIPPING DATA

Approximate Net Weight:
18 lbs. (8 kgs.)

www.designlights.org

TD614C30EN

January 18, 2018 3:54 PM

DIMENSIONS


Cylinder

Quarter Sphere

Trapezoid

Wedge

HOOK-N-LOCK MOUNTING
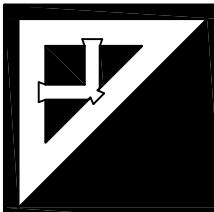
<h1>Aventura at Wild Horse Creek</h1> <hr/> <p>Chesterfield, Missouri</p>	
	
<p>JIM E. PARKER – ARCHITECT OF RECORD MISSOURI LICENSE # A-005136</p> <p>Parker Associates Tulsa, LLC 2202 East 49th Street South, Suite 200 Tulsa, OK 74105 (918)–742–2485</p>	
 <p>2202 East 49th, Suite #100 Tulsa, Oklahoma 74105 Phone (918) 743-4419 Fax (918) 743-4469</p> <p>Consulting Engineering Mechanical • Electrical • Energy</p>	<p>JOB NUMBER: 000000</p> <p>DRAWN BY: JT/AC/RL/DM/DB/SN</p> <p>DATE: 06/14/2018</p> <p>SL3 OF 3</p>

Walden Collection

Walden 1 Light LED Outdoor Wall Light BKT

49550BKTLED (Textured Black)

TYPE A

Dimensions

Height	7.25"
Width	5.00"

Kichler
7741 East Pleasant Valley Road
Cleveland, Ohio 44131-8010
Toll free: 866.568.5705 or kichler.com

Notes:

- 1) Information provided is subject to change without notice.
All values are design or typical values taken measured under laboratory conditions.
- 2) Incandescent Equivalent: The Incandescent equivalent as presented is an approximate number and is for reference only.

Project Name: _____
Location: _____
Type: _____
Qty: _____
Comments: _____

Ordering Information

Product ID	49550BKTLED
Finish	Textured Black
Available Finishes	AZ, BKT
Collection	Walden Collection

Dimensions

Extension	3.75"
Height from center of Wall opening	3.75"
Base Backplate	7.25 X 4.75
Weight	3.00 LBS

Photometrics

Kelvin Temperature	3000 K
Color Rendering Index	90

Specifications

Material	Aluminum
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Electrical

Dimmable	Yes
Dimmable Notes	This LED is compatible with most standard Incandescent dimmers, LED dimmers, and electronic low voltage dimmers. For more information, go to Kichler.com/dimming .
Voltage	120 V
Input Voltage	Single(120)

Qualifications

Safety Rated	Wet
ADA Compliant	Yes
Dark Sky	Yes
Expected Life Span	35000 Hours
Warranty	www.kichler.com/warranty

Primary Lighting

Light Source	LED
Lamp Included	Integrated
Light Source Equivalent	80(1) Incandescent
# of Bulbs/LED Modules	1
Delivered Lumens	780

KICHLER

Walden Collection
Walden 1 Light LED Outdoor Wall Light BKT
49550BKTLED (Textured Black)

Project Name:	<input type="text"/>
Location:	<input type="text"/>
Type:	<input type="text"/>
Qty:	<input type="text"/>
Comments:	<input type="text"/>

Initial Lumens	720
Delivered Efficacy	99
Max or Nominal Watt	8W
Dimming	Yes

Kichler
7701 East Pleasant Valley Road
Cleveland, OH 44136-5010
Toll free: 866.568.5709 or kichler.com

Notes:
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All values are design or typical values when tested under laboratory conditions.
2) Incandescent Equivalent: The incandescent equivalent as presented is an approximate number and is for reference only.

KICHLER