

nternationally Accredit

Memorandum Planning & Development Services Division

To: Planning and Public Works Committee

From: John Boyer, Senior Planner

Date: October 8, 2015

RE: T.S.P. 52-2015 Sprint (18614 Olive Street Rd): A request to amend an existing

Telecommunications Siting Permit to accommodate six (6) new antennas and additional related equipment for an existing telecommunication site within the "PI" Planned Industrial District located south of the intersection of Olive Street Road and

Premium Way.



Russell Been of Cellective Solutions LLC, on behalf of Sprint Wireless, has submitted a request for an amended Telecommunications Siting Permit (TSP) for the above referenced property also known as the location of Chesterfield Fence and Deck. The proposed TSP is to accommodate six (6) new antennas and associated equipment on an existing 101 foot tall tower. The antennas are planned to be placed on a new antenna array at a height of 66 feet above ground level. All associated ground equipment will be placed within existing equipment shelters.



Figure 1: Aerial Photo



Figure 2: Photo of Tower

History

The existing tower was originally approved administratively by the City of Chesterfield on March 25, 1992 via a Municipal Zoning Approval prior to the adoption of any telecommunication ordinance for the City of Chesterfield. Subsequent amendments to this tower occurred with the following applications (along with description of work);

- TSP 15-2009
 - Add new antennas to the existing tower.
- TSP 32-2011
 - Add additional antennas to the existing tower.

Discussion

The Unified Development Code (UDC) states that any new equipment or updates to a telecommunication facility exceeding the current TSP approval requires an amendment to the TSP. The current proposal, specifically to add a new antenna array, would be considered a Material Modification which is defined by the UDC as an essential or significant change to an existing wireless telecommunication facility. Generally, Material Modifications require a public hearing for approval; however, Article 6 of the UDC which governs telecommunication devices, allows for Material Modifications to be reviewed and approved by the City without a public hearing if the modification does not add more than five (5) feet in height to the existing facility. The intent of this exception in the code is to provide incentives to collocate on existing facilities and not to develop additional tower sites.

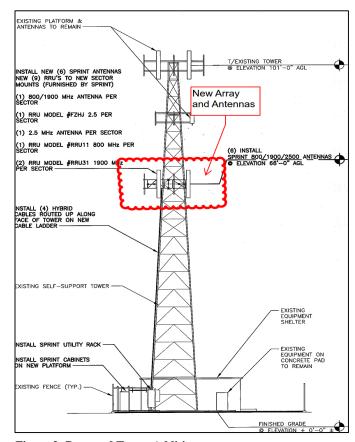


Figure 3: Proposed Tower Addition

In this application, the six (6) additional antennas and the new array would be located at 66 feet above ground level which would not add height to the existing 101 foot facility, see figure 3 to the left highlighting the proposed addition to the existing tower.

Recommendation

This site is compliant with the previous approvals and the City has not received any complaints relative to this facility. Staff has reviewed the request by Sprint against the UDC and has determined that the proposal is compliant with all code requirements. Staff recommends approval of a TSP for Sprint as proposed. After receiving a recommendation from the Planning and Public Works Committee, this request may be forwarded to the City Council for review. Attached please find a copy of the construction plans.

Respectfully submitted,

John Boyer

Senior Planner

Aimee Nassif, Planning and Development Services Director cc.



SITE INFORMATION

CHESTERFIELD FENCE & DOCK CO. INC.

BUILDING OWNER:

LATITUDE (NAD83):

LONGITUDE (NAD83);

ST. LOUIS COUNTY, MO

CITY OF CHESTERFIELD

ZONING DISTRICT:

POWER COMPANY:

AMEREN PHONE: 800-552-7583

PHONE: 800-222-0400

NAME: LONNIE HAGEDORN

PHONE: (417) 777-0918

EQUIPMENT SUPPLIER:

PHONE: (972) 583-0000

AAV PROVIDER:

SPRINT CM:

ERICSSON 6300 LEGACY DR. PLANO, TX 75024

CONTACT: T.B.D.

ZONING JURISDICTION:

P1 - PLANNED INOUSTRIAL DISTRICT

18614 OLIVE ST. CHESTERFIELD, MO 63006 PHONE: 636-532-4054

38° 40' 13.97" N

90° 39' 46.87" W

-90,663019*

COUNTY:

38.67055*

PROJECT:

SPRINT OCEAN PROJECT

SITE NAME:

ATC GUMBO

City of Chesterfield

DRAWING INDEX

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D/C SUB PANEL DETAIL

ELECTRICAL DETAILS TOWER GROUNDING

ELECTRICAL PLAN

GROUNDING PLAN

ELECTRICAL DETAILS

ELECTRICAL DETAILS

SEP 2 9 2015

RECEIVED

Department of Public Service

REV ENGINEER

0 W. THOMPSON

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SHIVEHATTERY ARCHITECTURE + ENGINEERING 025 Highland Pkwy Suite 140 | Downers Grove, Illinois 60515 30 390,7444 | (ax 630,437,5800 | shive-haltery com

Overland Park, Kansas 66251

S/H PROJ # 8155100-19

DRAWING NOTICE

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ATC GUMBO

ST51XC070

- SITE ADDRESS:

18614 OLIVE STREET ROAD CHESTERFIELD, MO 63005

- SHEET DESCRIPTION.

TITLE SHEET & PROJECT DATA

T-1

MLA NUMBER: ST51XC070 SITE ADDRESS: 18614 OLIVE STREET ROAD CHESTERFIELD, MO 63005 101'-SELF SUPPORT SITE TYPE: AMERICAN TOWER CORPORATION #: 305973 - GUMBO

SHEET NO:

SP-1

SP-2

SURVEY

A-2

A-3

A-4

A-5A

A-5B

A-6

A-7

A-8A

A-8B

A-8C

A-8D

S-1

S-2

E-1A

E-1B

E-2

E-3

E-4

E-5

E-6

E-7

SPRINT CASCADE: ST51XC070

AREA MAP M J S S O U R I Towers Rd Weldon Spring Jacobs Weldon Spring Heights ST CHARLES Weldon Bonhomme Island Howell Island ellefontaine Chesterfield Centaur Monarch (109) Babler Wildwood Memorial State Park (BA)

INSTALL (1) ERICSSON BBS CABINET ON NEW PLATFORM INSTALL (1) ERICSSON RBS CABINET ON NEW PLATFORM INSTALL (1) UTILITY RACK ON NEW PLATFORM INSTALL (3) 800/1900 MHz PANEL ANTENNAS (1) PER SECTOR INSTALL (3) 2500 MHz PANEL ANTENNAS (1) PER SECTOR INSTALL (6) 1900 MHz RRU'S (2) PER SECTOR INSTALL (3) 800 MHz RRU'S (1) PER SECTOR INSTALL (4) 1.37"# HYBRID CABLES INSTALL (24) COAX JUMPERS AT TOP (8) PER SECTOR

PROJECT EQUIPMENT

WORK SHALL BE PERFORMED AND MATERIALS INSTALLED IN ACCORDANCE WITH THE CURRENT EDITIONS OF THE FOLLOWING CODES AS ADOPTED BY THE LOCAL GOVERNING AUTHORITIES. NOTHING IN THESE PLANS IS TO BE CONSTRUED TO PERMIT WORK NOT CONFORMING TO THESE CODES.

APPLICABLE CODES

- INTERNATIONAL BUILDING CODE (2009)
 NATIONAL ELECTRICAL CODE (2008)
 INTERNATIONAL RESIDENTIAL CODE (2009)
 INTERNATIONAL MECHANICAL CODE (2009)
- INTERNATIONAL PLUMBING CODE (2009) INTERNATIONAL

Know what's below Call before you dig.

LOCATION MAP Cheste

PROPERTY MAINTENANCE CODE (2009)
ANSI/TIA-222 STRUCTURAL STANDARD REV G

THESE OUTLINE SPECIFICATIONS IN CONJUNCTION WITH THE SPRINT STANDARD CONSTRUCTION SPECIFICATIONS, INCLUDING CONTRACT DOCUMENTS AND THE CONSTRUCTION DRAWINGS DESCRIBE THE WORK TO BE PERFORMED BY THE CONTRACTOR. SECTION 01 100 - SCOPE OF WORK

THE WORK:

SHALL COMPLY WITH APPLICABLE NATIONAL CODES AND STANDARDS, LATEST EDITION, AND PORTIONS THEREOF.

PRECEDENCE:

SHOULD CONFLICTS OCCUR BETWEEN THE STANDARD CONSTRUCTION SPECIFICATIONS FOR WIRELESS SITES INCLUDING THE STANDARD CONSTRUCTION DETAILS FOR WIRELESS SITES AND THE CONSTRUCTION DRAWINGS, INFORMATION ON THE CONSTRUCTION DRAWINGS SHALL TAKE PRECEDENCE.

SITE FAMILIARITY:

CONTRACTOR SHALL BE RESPONSIBLE FOR FAMILIARIZING HIMSELF WITH CONTRACT DOCUMENTS, FIELD CONDITIONS AND DIMENSIONS PRIOR TO PROCEEDING WITH

ON-SITE SUPERVISION: THE CONTRACTOR SHALL SUPERVISE AND DIRECT THE WORK AND SHALL BE RESPONSIBLE FOR CONSTRUCTION MEANS, METHODS, TECHNIQUES, SEQUENCES, AND PROCEDURES IN ACCORDANCE WITH THE CONTRACT DOCUMENTS.

<u>DRAWINGS. SPECIFICATIONS AND DETAILS REQUIRED AT JOBSITE:</u>
THE CONSTRUCTION CONTRACTOR SHALL MAINTAIN A FULL SET OF THE CONSTRUCTION DRAWINGS AT THE JOBSITE FROM MOBILIZATION THROUGH CONSTRUCTION COMPLETION.

- DETAILS ARE INTENDED TO SHOW DESIGN INTENT, PROVIDE MATERIALS AND LABOR AS REQUIRED TO PROVIDE A COMPLETE AND FUNCTIONING SYSTEM, MODIFICATIONS MAY BE REQUIRED TO SUIT JOB DIMENSIONS OR CONDITIONS, AND SUCH MODIFICATIONS SHALL BE INCLUDED AS PART OF THE WORK.
- CONTRACTOR SHALL NOTIFY SPRINT CONSTRUCTION MANAGER OF VARIATIONS PRIOR TO PROCEEDING WITH THE WORK DIMENSIONS SHOWN ARE TO FINISH SURFACES UNLESS NOTED OTHERWISE. MODIFICATIONS MAY BE REQUIRED TO SUIT JOB DIMENSIONS OR CONDITIONS, AND SUCH MODIFICATIONS SHALL BE INCLUDED AS
- C. MARK THE FIELD SET OF DRAWINGS IN RED, DOCUMENTING CHANGES FROM THE CONSTRUCTION DOCUMENTS.

METHODS OF PROCEDURE (MOPS) FOR CONSTRUCTION: CONTRACTOR SHALL PERFORM WORK AS DESCRIBED IN

- A. COAX COLOR CODING SWEEPS AND FIBER TESTING TS-0200 AND EL-0568
- B. CABLE LABELING EN-2012-00
- C. APPLICABLE INSTALLATION MOPS IDENTIFIED ELSEWHERE IN THE CONTRACT DOCUMENTS

SECTION 01 200 - COMPANY FURNISHED MATERIAL AND EQUIPMENT

COMPANY FURNISHED MATERIAL AND EQUIPMENT IS IDENTIFIED ON THE RF DATA SHEET IN THE CONSTRUCTION DRAWINGS.

CONTRACTOR IS RESPONSIBLE FOR SPRINT PROVIDED MATERIAL AND EQUIPMENT TO ENSURE IT IS PROTECTED AND HANDLED PROPERLY THROUGHOUT THE CONSTRUCTION

CONTRACTOR RESPONSIBLE FOR RECEIPT OF SPRINT FURNISHED EQUIPMENT AT CELL SITE OR CONTRACTORS LOCATION. CONTRACTOR TO COMPLETE SHIPPING AND RECEIPT DOCUMENTATION IN ACCORDANCE WITH COMPANY PRACTICE.

SECTION 01 300 - CELL SITE CONSTRUCTION

NOTICE TO PROCEED:

NO WORK SHALL COMMENCE PRIOR TO COMPANY'S WRITTEN NOTICE TO PROCEED AND THE ISSUANCE OF WORK ORDER.

CONTRACTOR SHALL KEEP THE SITE FREE FROM ACCUMULATING WASTE MATERIAL, DEBRIS, AND TRASH. AT THE COMPLETION OF THE WORK, CONTRACTOR SHALL REMOVE FROM THE SITE REMAINING RUBBISH, IMPLEMENTS, TEMPORARY FACILITIES, AND SURPLUS MATERIALS.

SECTION 01 400 - SUBMITTALS & TESTS

ALTERNATES:

AT THE COMPANY'S REQUEST, ALTERNATIVES TO THE MATERIALS OR METHODS SPECIFIED SHALL BE SUBMITTED TO SPRINTS CONSTRUCTION MANAGER FOR APPROVAL. SPRINT WILL REVIEW AND APPROVE ONLY THOSE REQUESTS MADE IN WRITING. NO VERBAL APPROVALS WILL BE CONSIDERED.

TESTS AND INSPECTIONS:

- A. THE CONTRACTOR SHALL BE RESPONSIBLE FOR CONSTRUCTION TESTS, INSPECTIONS AND PROJECT DOCUMENTATION.
- B. CONTRACTOR SHALL ACCOMPLISH TESTING INCLUDING BUT NOT LIMITED TO THE FOLLOWING:
- 1. COAX SWEEPS AND FIBER TESTS PER TS-0200 REV 4 ANTENNA LINE ACCEPTANCE
- 2. AGL, AZIMUTH AND DOWNTILT PROVIDE AN AUTOMATED REPORT UPLOADED TO SITERRA USING A COMMERCIAL MADE-FOR THE PURPOSE ELECTRONIC ANTENNA ALIGNMENT TOOL (AAT). INSTALLED AZIMUTH, CENTERLINE AND DOWNTILT MUST CONFORM WITH RF CONFIGURATION DATA

- 3. CONTRACTOR SHALL BE RESPONSIBLE FOR CORRECTIONS TO WORK IDENTIFIED AS UNACCEPTABLE IN SITE INSPECTION ACTIVITIES AND/OR AS A RESULT OF TESTING.
- 4. TESTING REQUIRED BY APPLICABLE INSTALLATION MOPS.
- C. REQUIRED CLOSEOUT DOCUMENTATION INCLUDES, BUT IS NOT LIMITED TO THE FOLLOWING:
 - 1. AZIMUTH, DOWNTILT, AGL FROM SUNSIGHT INSTRUMENTS ANTENNALIGN ALIGNMENT TOOL (AAT)
- 2. SWEEP AND FIBER TESTS
- 3. SCALABLE BARCODE PHOTOGRAPHS OF TOWER TOP AND INACCESSIBLE SERIALIZED B. ANTENNA MOUNTING REQUIREMENTS: PROVIDE ANTENNA MOUNTING
- 4. AVAILABLE JURISDICTIONAL PERMIT AND OCCUPANCY INFORMATION
- 5. PDF SCAN OF REDLINES PRODUCED IN FIELD
- 6. A PDF SCAN OF REDLINE MARK-UPS SUITABLE FOR USE IN ELECTRONIC AS-BUILT DRAWING PRODUCTION
- JEN WAIVERS
- 8. FINAL PAYMENT APPLICATION
- 9. REQUIRED FINAL CONSTRUCTION PHOTOS
- 1D. CONSTRUCTION AND COMMISSIONING CHECKLIST COMPLETE WITH NO DEFICIENT **TEMS**
- 11. APPLICABLE POST NTP TASKS INCLUDING DOCUMENT UPLOADS COMPLETED IN SITERRA (SPRINTS DOCUMENT REPOSITORY OF RECORD).
- 12. CLOSEOUT PHOTOGRAPHS AND CLOSEOUT CHECKLIST: SPRINT WILL PROVIDE SEPARATE GUIDANCE

SECTION 11 700 - ANTENNA ASSEMBLY, REMOTE RADIO UNITS AND CABLE INSTALLATION

THIS SECTION SPECIFIES INSTALLATION OF ANTENNAS, RRU'S, AND CABLE EQUIPMENT, INSTALLATION, AND TESTING OF COAXIAL FIBER CABLE.

THE NUMBER AND TYPE OF ANTENNAS AND RRU'S TO BE INSTALLED IS DETAILED ON THE CONSTRUCTION DRAWINGS.

HYBRID CABLE:

HYBRID CABLE WILL BE DC/FIBER AND FURNISHED FOR INSTALLATION AT EACH SITE. CABLE SHALL BE INSTALLED PER THE CONSTRUCTION DRAWINGS AND THE APPLICABLE MANUFACTURER'S REQUIREMENTS.

JUMPERS AND CONNECTORS:

FURNISH AND INSTALL 1/2" COAX JUMPER CABLES BETWEEN THE RRU'S AND ANTENNAS. JUMPERS SHALL BE TYPE LDF 4, FLC 12-50, CR 540, OR FXL 540. SUPER-FLEX CABLES ARE NOT ACCEPTABLE, JUMPERS BETWEEN THE RRU'S AND ANTENNAS OR TOWER TOP AMPLIFIERS SHALL CONSIST OF 1/2 INCH FOAM DIELECTRIC, OUTDOOR RATED COAXIAL CABLE, MIN LENGTH FOR JUMPER SHALL BE 10"-0".

REMOTE ELECTRICAL TILT (RET) CABLES:

INSTALL SPLITTERS, COMBINERS, FILTERS PER RF DATA SHEET, FURNISHED BY SPRINT.

ANTENNA INSTALLATION:

THE CONTRACTOR SHALL ASSEMBLE ANTENNAS ONSITE IN ACCORDANCE WITH THE INSTRUCTIONS SUPPLIED BY THE MANUFACTURER. ANTENNA HEIGHT, AZIMUTH, AND FEED ORIENTATION INFORMATION SHALL BE A DESIGNATED ON THE CONSTRUCTION DRAWINGS.

- A. THE CONTRACTOR SHALL POSITION THE ANTENNA ON TOWER PIPE MOUNTS SO THAT THE BOTTOM STRUT IS LEVEL. THE PIPE MOUNTS SHALL BE PLUMB TO WITHIN 1 DEGREE
- HARDWARE AS INDICATED ON THE DRAWINGS.

HYBRID CABLE INSTALLATION:

- A. THE CONTRACTOR SHALL ROUTE, TEST, AND INSTALL CABLES AS INDICATED ON THE CONSTRUCTION DRAWINGS AND IN ACCORDANCE WITH THE MANUFACTURER'S RECOMMENDATIONS
- B. THE INSTALLED RADIUS OF THE CABLES SHALL NOT BE LESS THAN THE MANUFACTURER'S SPECIFICATIONS FOR BENDING RADII.
- C. EXTREME CARE SHALL BE TAKEN TO AVOID DAMAGE TO THE CABLES DURING HANDLING AND INSTALLATION.
- 1. FASTENING MAIN HYBRID CABLES: CABLES SHALL BE ATTACHED TO THE CABLE LADDER WITH SUPPORT HANGERS AS REQUIRED BY THE MANUFACTURER.
- 2. FASTENING INDIVIDUAL FIBER AND DC CABLES ABOVE BREAKOUT ENCLOSURE (MEDUSA), WITHIN THE MMBS CABINET AND INTERMEDIATE DISTRIBUTION BOXES:
 - FIBER: SUPPORT FIBER BUNDLES USING 1/2" VELCRO STRAPS OF THE REQUIRED LENGTH © 18" OC. STRAPS SHALL BE UV, OIL AND WATER RESISTANT AND SUITABLE FOR INDUSTRIAL INSTALLATIONS AS MANUFACTURED BY TEXTOL OR APPROVED FOUAL
- b. DC: SUPPORT DC BUNDLES WITH ZIP TIES OF THE ADEQUATE LENGTH. ZIP TIES TO BE UV STABILIZED, BLACK NYLON, WITH TENSILE STRENGTH AT 12,000 PSI AS MANUFACTURED BY NELCO PRODUCTS OR EQUAL.
- 3. FASTENING JUMPERS: SECURE JUMPERS TO THE SIDE ARMS OR HEAD FRAMES USING STAINLESS STEEL TIE WRAPS OR STAINLESS STEEL BUTTERFLY CLIPS.
- 4. CABLE INSTALLATION:
 - INSPECT CABLE PRIOR TO USE FOR SHIPPING DAMAGE, NOTIFY THE CONSTRUCTION MANAGER.
 - CABLE ROUTING: CABLE INSTALLATION SHALL BE PLANNED TO ENSURE THAT THE LINES WILL BE PROPERLY ROUTED IN THE CABLE ENVELOP AS INDICATED ON THE DRAWINGS. AVOID TWISTING AND CROSSOVERS.
 - HOIST CABLE USING PROPER HOISTING GRIPS. DO NOT EXCEED MANUFACTURES RECOMMENDED MAXIMUM BEND RADIUS.




PLANS PREPARED BY: =

SHIVEHATTERY ARCHITECTURE+ENGINEERING

3025 Highland Pkwy Suite 140 | Downers Grove, Illinois 60515 630.390.7444 | fax 630.437.5800 | shive-hattery.com Iowa I Illinois I Missouri

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REVISIONS:
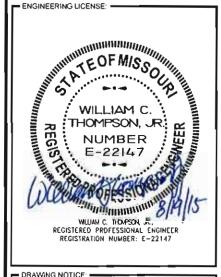
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- SITE NAME:

ATC GUMBO

- SITE CASCADE

ST51XC070

- SITE ADDRESS: -

18614 OLIVE STREET ROAD CHESTERFIELD, MO 63005

- SHEET DESCRIPTION:

SPRINT SPECIFICATIONS

SHEET NUMBER

CONTINUE FROM SP-1

- GROUNDING OF TRANSMISSION LINES: ALL TRANSMISSION LINES SHALL BE GROUNDED AS INDICATED ON DRAWINGS.
- 6. HYBRID CABLE COLOR CODING: COLOR CODING SHALL BE AS REQUIRED IN TS
- 7. HYBRID CABLE LABELING: INDIVIDUAL HYBRID AND DC BUNDLES SHALL BE LABELED ALPHA-NUMERICALLY ACCORDING TO SPRINT CELL SITE ENGINEERING NOTICE - EN 2012-DD1, REV 1

WEATHERPROOFING EXTERIOR CONNECTORS AND HYBRID CABLE GROUND B. FASTENERS: TYPES, MATERIALS, AND CONSTRUCTION FEATURES AS FOLLOWS:

- A. FIBER & COAX CONNECTORS AND GROUND KITS SHALL BE WEATHERPROOFED
- WEATHERPROOFED USING ONE OF THE FOLLOWING METHODS, INSTALLATIONS MUST BE DONE IN ACCORDANCE WITH THE MANUFACTURER'S RECOMMENDATIONS AND INDUSTRY BEST PRACTICES
 - COLD SHRINK: ENCOMPASS CONNECTOR IN COLD SHRINK TUBING AND PROVIDE A DOUBLE WRAP OF 2" ELECTRICAL TAPE EXTENDING 2" BEYOND TUBING. PROVIDE 3M COLD SHRINK CXS SERIES OR EQUAL
 - SELF-AMALGAMATING TAPE: CLEAN SURFACES. APPLY A DOUBLE WRAP OF SELF-AMALGAMATING TAPE 2" BEYOND CONNECTOR, APPLY A SECOND WRAP OF SELF-AMALGAMATING TAPE IN OPPOSITE DIRECTION. APPLY DOUBLE WRAP OF 2" WIDE ELECTRICAL TAPE EXTENDING 2" BEYOND THE SELF-AMALGAMATING TAPE.
 - 3. 3M SLIM LOCK CLOSURE 716: SUBSTITUTIONS WILL NOT BE ALLOWED.
 - 4. OPEN FLAME ON JOB SITE IS NOT ACCEPTABLE

SECTION 11 800 - INSTALLATION OF MULTIMODAL BASE STATIONS (MMBS) AND RELATED EQUIPMENT

SUMMARY:

- THIS SECTION SPECIFIES MMBS CABINETS, POWER CABINETS, AND INTERNAL EQUIPMENT INCLUDING BY NOT LIMITED TO RECTIFIERS, POWER DISTRIBUTION UNITS, BASE BAND UNITS, SURGE ARRESTORS, BATTERIES, AND SIMILAR EQUIPMENT FURNISHED BY THE COMPANY FOR INSTALLATION BY THE CONTRACTOR (OFCI).
- CONTRACTOR SHALL PROVIDE AND INSTALL MISCELLANEOUS MATERIALS AND PROVIDE LABOR REQUIRED FOR INSTALLATION EQUIPMENT IN EXISTING CABINET OR NEW CABINET AS SHOWN ON DRAWINGS AND AS REQUIRE BY THE APPLICABLE INSTALLATION MOPS.
- C. COMPLY WITH MANUFACTURERS INSTALLATION AND START-UP REQUIREMENTS

DC CIRCUIT BREAKER LABELING

A. NEW DC CIRCUIT IS REQUIRED IN MMBS CABINET SHALL BE CLEARLY IDENTIFIED AS TO RRU BEING SERVICED

SECTION 26 100 - BASIC ELECTRICAL REQUIREMENTS

 $\begin{array}{ll} \underline{\text{SUMMARY:}} \\ \text{THIS SECTION SPECIFIES BASIC ELECTRICAL REQUIREMENTS FOR SYSTEMS AND} \end{array}$ COMPONENTS.

QUALITY ASSURANCE:

- EQUIPMENT FURNISHED UNDER DIVISION 26 SHALL CARRY UL LABELS AND LISTINGS WHERE SUCH LABELS AND LISTINGS ARE AVAILABLE IN THE INDUSTRY
- MANUFACTURERS OF EQUIPMENT SHALL HAVE A MINIMUM OF THREE YEARS EXPERIENCE WITH THEIR EQUIPMENT INSTALLED AND OPERATING IN THE FIELD IN A USE SIMILAR TO THE PROPOSED USE FOR THIS PROJECT.
- MATERIALS AND EQUIPMENT: MATERIALS AND EQUIPMENT SPECIFIED IN DIVISION 26 OF THE SAME TYPE SHALL BE OF THE SAME MANUFACTURER AND SHALL BE NEW, OF THE BEST QUALITY AND DESIGN, AND FREE FROM DEFECTS

SUPPORTING DEVICES:

- EQUIPMENT FURNISHED UNDER DIVISION 26 SHALL CARRY UL LABELS AND LISTINGS WHERE SUCH LABELS AND LISTINGS ARE AVAILABLE IN THE INDUSTRY.
- MANUFACTURERS OF EQUIPMENT SHALL HAVE A MINIMUM OF THREE YEARS EXPERIENCE WITH THEIR EQUIPMENT INSTALLED AND OPERATING IN THE FIELD IN A USE SIMILAR TO THE PROPOSED USE FOR THIS PROJECT.
- MATERIALS AND EQUIPMENT:
 MATERIALS AND EQUIPMENT SPECIFIED IN DIVISION 26 OF THE SAME TYPE SHALL BE OF THE SAME MANUFACTURER AND SHALL BE NEW, OF THE BEST QUALITY AND DESIGN, AND FREE FROM DEFECTS

SUPPORTING DEVICES:

- A. MANUFACTURED STRUCTURAL SUPPORT MATERIALS: SUBJECT TO COMPLIANCE WITH REQUIREMENTS, PROVIDE PRODUCTS BY THE FOLLOWING:
- ALLIED TUBE AND CONDUIT
- 2. B-LINE SYSTEM
- 3. SUNISTRUT DIVERSIFIED PRODUCTS
- 4. THOMAS & BETTS
- 1. EXPANSION ANCHORS: CARBON STEEL WEDGE OR SLEEVE TYPE.
- 2. POWER-DRIVEN THREADED STUDS: HEAT-TREATED STEEL, DESIGNED SPECIFICALLY FOR THE INTENDED SERVICE.
- 3. FASTEN BY MEANS OF WOOD SCREWS ON WOOD.
- 4. TOGGLE BOLTS ON HOLLOW MASONRY UNITS.
- 5. CONCRETE INSERTS OR EXPANSION BOLTS ON CONCRETE OR SOLID MASONRY.
- 6. MACHINE SCREWS, WELDED THREADED STUDS, OR SPRING-TENSION CLAMPS ON
- 7. EXPLOSIVE DEVICES FOR ATTACHING HANGERS TO STRUCTURE SHALL NOT BE
- 8. DO NOT WELD CONDUIT, PIPE STRAPS, OR ITEMS OTHER THAN THREADED STUDS TO STEEL STRUCTURES.
- 9. IN PARTITIONS OF LIGHT STEEL CONSTRUCTION, USE SHEET METAL SCREWS.

SUPPORTING DEVICES:

- A. INSTALL SUPPORTING DEVICES TO FASTEN ELECTRICAL COMPONENTS SECURELY AND PERMANENTLY IN ACCORDANCE WITH NEC.
- B. COORDINATE WITH THE BUILDING STRUCTURAL SYSTEM AND WITH OTHER TRADES.
- C. UNLESS OTHERWISE INDICATED ON THE DRAWINGS, FASTEN ELECTRICAL ITEMS AND THEIR SUPPORTING HARDWARE SECURELY TO THE STRUCTURE IN ACCORDANCE WITH
- D. ENSURE THAT THE LOAD APPLIED BY FASTENER DOES NOT EXCEED 25 PERCENT OF THE PROOF TEST LOAD.
- E. USE VIBRATION AND SHOCK-RESISTANT FASTENERS FOR ATTACHMENTS TO CONCRETE

ELECTRICAL IDENTIFICATION:

- A. UPDATE AND PROVIDE TYPEO CIRCUIT BREAKER SCHEDULES IN THE MOUNTING BRACKET, INSIDE DOORS OF AC PANEL BOARDS WITH ANY CHANGES MADE TO THE
- B. BRANCH CIRCUITS FEEDING AVIATION OBSTRUCTION LIGHTING EQUIPMENT SHALL BE CLEARLY IDENTIFIED AS SUCH AT THE BRANCH CIRCUIT PANELBOARD.

SECTION 26 200 - ELECTRICAL MATERIALS AND EQUIPMENT

EXISTING STRUCTURE:

A. EXISTING EXPOSED WIRING AND ALL EXPOSEO OUTLETS, RECEPTACLES, SWITCHES, DEVICES, BOXES, AND OTHER EQUIPMENT THAT ARE NOT TO BE UTILIZED IN THE COMPLETED PROJECT SHALL BE REMOVED OR DE-ENERGIZED AND CAPPED IN THE WALL, CEILING, OR FLOOR SO THAT THEY ARE CONCEALED AND SAFE. WALL, CEILING, OR FLOOR SHALL BE PATCHED TO MATCH THE ADJACENT CONSTRUCTION.

CONDUIT AND CONDUCTOR INSTALLATION:

- A. CONDUITS SHALL BE FASTENED SECURELY IN PLACE WITH APPROVED NON-PERFORATED STRAPS AND HANGERS. EXPLOSIVE DEVICES FOR ATTACHING HANGERS TO STRUCTURE WILL NOT BE PERMITTED. CLOSELY FOLLOW THE LINES OF THE STRUCTURE. MAINTAIN CLOSE PROXIMITY TO THE STRUCTURE AND KEEP CONDUITS IN TIGHT ENVELOPES, CHANGES IN DIRECTION TO ROUTE AROUND OBSTACLES SHALL BE MADE WITH CONDUIT OUTLET BODIES. CONDUIT SHALL BE INSTALLED IN A NEAT AND WORKMANLIKE MANNER, PARALLEL AND PERPENDICULAR TO STRUCTURE WALL AND CEILING LINES. ALL CONDUIT SHALL BE FISHED TO CLEAR OBSTRUCTIONS. ENDS OF CONDUITS SHALL BE TEMPORARILY CAPPED TO PREVENT CONCRETE, PLASTER OR DIRT FROM ENTERING, CONDUITS SHALL BE RIGIDLY CLAMPED TO BOXES BY GALVANIZED MALLEABLE IRON BUSHING ON INSIDE AND GALVANIZED MALLEABLE IRON LOCKNUT ON OUTSIDE AND INSIDE.
- B. CONDUCTORS SHALL BE PULLED IN ACCORDANCE WITH ACCEPTED GOOD PRACTICE.

CONDUIT:

- RIGID GALVANIZED STEEL (RGS) CONDUIT SHALL BE USED FOR EXTERIOR LOCATIONS ABOVE GROUND AND IN UNFINISHED INTERIOR LOCATIONS AND FOR ENCASED RUNS IN CONCRETE. RIGID CONDUIT AND FITTINGS SHALL BE STEEL, COATED WITH ZINC EXTERIOR AND INTERIOR BY THE HOT DIP GALVANIZING PROCESS, CONDUIT SHALL BE PRODUCED TO ANSI SPECIFICATIONS C80.1, FEDERAL SPECIFICATION WW-C-581 AND SHALL BE LISTED WITH THE UNDERWRITERS' LABORATORIES. FITTINGS SHALL BE THREADED — SET SCREW OR COMPRESSION FITTINGS WILL NOT BE ACCEPTABLE. RGS CONDUITS SHALL BE MANUFACTURED BY ALLIED, REPUBLIC OR WHEATLAND.
- B. UNDERGROUND CONDUIT IN CONCRETE SHALL BE POLYVINYLCHLORIDE (PVC) SUITABLE FOR DIRECT BURIAL AS APPLICABLE. JOINTS SHALL BE BELLED, AND FLUSH SOLVENT WELDED IN ACCORDANCE WITH MANUFACTURER'S INSTRUCTIONS, CONDUIT SHALL BE CARLON ELECTRICAL PRODUCTS OR APPROVED EQUAL.
- TRANSITIONS BETWEEN PVC AND RIGID (RGS) SHALL BE MADE WITH PVC COATED METALLIC LONG SWEEP RADIUS ELBOWS.
- D. EMT OR RIGID GALVANIZED STEEL CONDUIT MAY BE USED IN FINISHED SPACES CONCEALED IN WALLS AND CEILINGS. EMT SHALL BE MILD STEEL, ELECTRICALLY WELDEO, ELECTRO—GALVANIZED OR HOT—DIPPED GALVANIZED AND PRODUCED TO ANSI SPECIFICATION CBO.3, FEDERAL SPECIFICATION WW—C—563, AND SHALL BE UL LISTED. EMT SHALL BE MANUFACTURED BY ALLIED, REPUBLIC OR WHEATLAND, OR APPROVED EQUAL, FITTINGS SHALL BE METALLIC COMPRESSION, SET SCREW CONNECTIONS SHALL
- E. LIQUID TIGHT FLEXIBLE METALLIC CONDUIT SHALL BE USED FOR FINAL CONNECTION TO EQUIPMENT. FITTINGS SHALL BE METALLIC GLAND TYPE COMPRESSION FITTINGS, MAINTAINING THE INTEGRITY OF CONDUIT SYSTEM. SET SCREW CONNECTIONS SHALL NOT BE ACCEPTABLE. MAXIMUM LENGTH OF FLEXIBLE CONDUIT SHALL NOT EXCEED 6-FEET. LFMC SHALL BE PROTECTED AND SUPPORTED AS REQUIRE BY NEC. MANUFACTURERS OF FLEXIBLE CONDUITS SHALL BE CAROL, ANACONDA METAL HOSE OR UNIVERSAL METAL HOSE, OR APPROVED EQUAL.
- F. MINIMUM SIZE CONDUIT SHALL BE 3/4 INCH (21MM)

HUBS AND BOXES:

- A. AT ENTRANCES TO CABINETS OR OTHER EQUIPMENT NOT HAVING INTEGRAL THREADED HUBS PROVIDE METALLIC THREADED HUBS OF THE SIZE AND CONFIGURATION REQUIRED. HUB SHALL INCLUDE LOCKNUT AND NEOPRENE O-RING SEAL. PROVIDE IMPACT RESISTANT 105 DEGREE C PLASTIC BUSHINGS TO PROTECT CABLE INSULATION.
- B. CABLE TERMINATION FITTINGS FOR CONDUIT
- 1. CABLE TERMINATORS FOR RGS CONDUITS SHALL BE TYPE CRC BY O-Z/GEDNEY OR
- 2. CABLE TERMINATORS FOR LFMC SHALL BE EICO CL2075; OR MADE FOR THE PURPOSE PRODUCTS BY ROXTEC.
- C. EXTERIOR PULL BOXES AND PULL BOXES IN INTERIOR INDUSTRIAL AREAS SHALL BE PLATED CAST ALLOY, HEAVY DUTY, WEATHERPROOF, DUST PROOF, WITH GASKET, PLATED IRON ALLOY COVER AND STAINLESS STEEL COVER SCREWS, CROUSE—HINDS WAB SERIES OR EQUAL
- CONDUIT OUTLET BODIES SHALL BE PLATED CAST ALLOY WITH SIMILAR GASKETED COVERS. OUTLET BODIES SHALL BE OF THE CONFIGURATION AND SIZE SUITABLE FOR THE APPLICATION. PROVIDE CROUSE-HINDS FORM 8 OR EQUAL
- MANUFACTURER FOR BOXES AND COVERS SHALL BE HOFFMAN, SQUARE "D", CROUSE-HINDS, COOPER, ADALET, APPLETON, O-Z GEDNEY, RACO, OR APPROVED

SUPPLEMENTAL GROUNDING SYSTEM

- A. FURNISH AND INSTALL A SUPPLEMENTAL GROUNDING SYSTEM TO THE EXTENT INDICATED ON THE DRAWINGS. SUPPORT SYSTEM WITH NON-MAGNETIC STAINLESS STEEL CLIPS WITH RUBBER GROMMETS. GROUNDING CONNECTORS SHALL BE TINNED COPPER WIRE, SIZES AS INDICATED ON THE DRAWINGS. PROVICE STRANDED OR SOLID BARE OR INSULATED CONDUCTORS EXCEPTED AS OTHERWISE NOTED.
- SUPPLEMENTAL GROUNDING SYSTEM: CONNECTIONS TO BE MADE WITH CAD WELDS, EXCEPT AT EQUIPMENT USE LUGS OR OTHER AVAILABLE GROUNDING MEANS AS REQUIRED BY MANUFACTURER; AT GROUND BARS USE TWO HOLE SPADES WITH NO OX.
- C. STOLEN GROUND-BARS: IN THE EVENT OF STOLEN GROUND BARS, CONTACT SPRINT CM FOR REPLACEMENT INSTRUCTION USING THREADED ROD KITS.

Overland Park, Kansas 66251

PLANS PREPARED BY:

Iowa | Illinois | Missouri

- ENGINEERING LICENSE:

PLANS PREPARED FOR

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630,390,7444 | fax 630,437,5800 | shive-hattery.com S/H PROJ # 8155100-19

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- SITE NAME:

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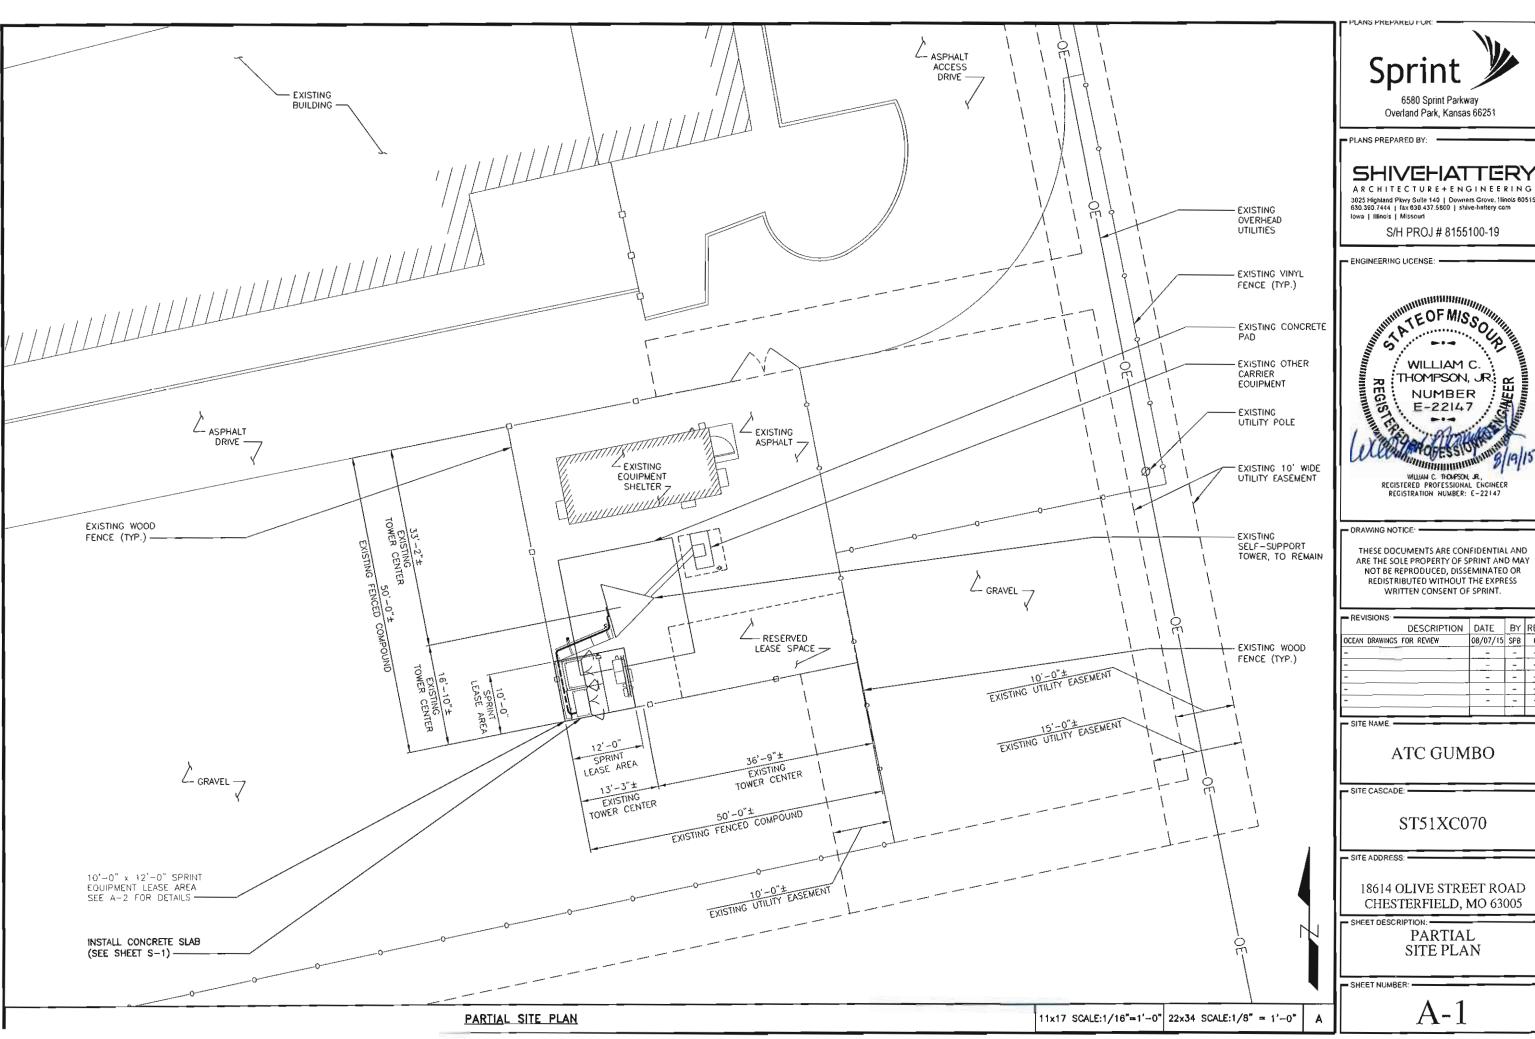
SITE ADDRESS: -

18614 OLIVE STREET ROAD CHESTERFIELD, MO 63005

- SHEET DESCRIPTION: -

SPRINT SPECIFICATIONS


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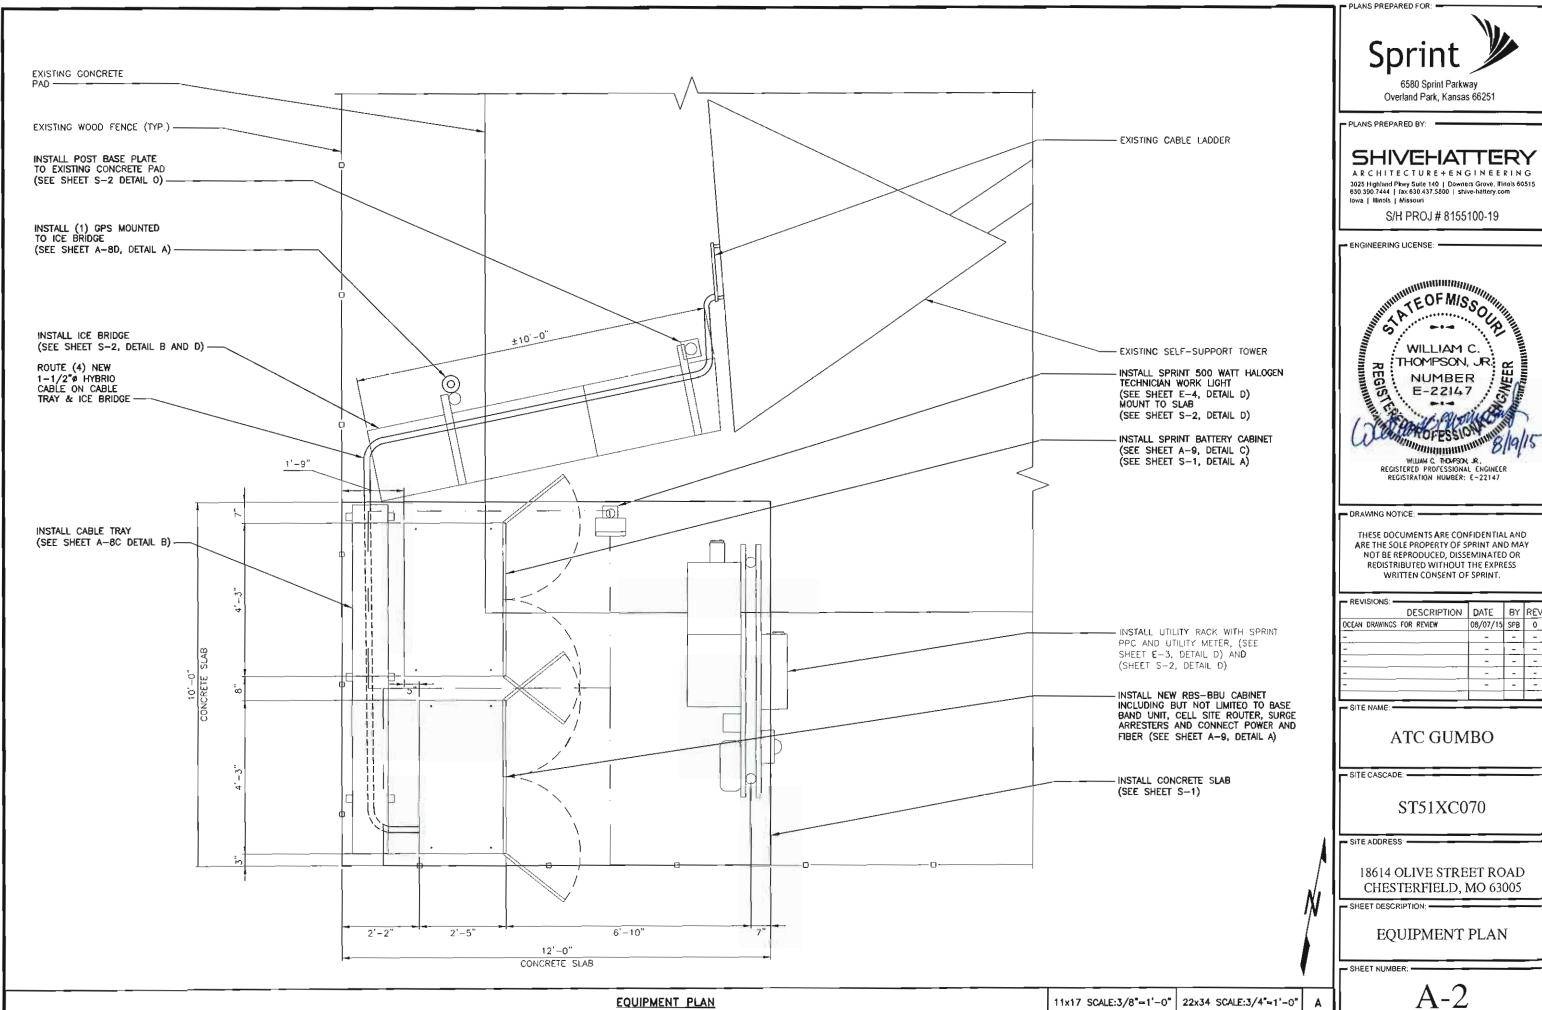



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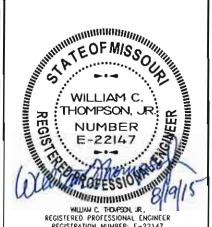
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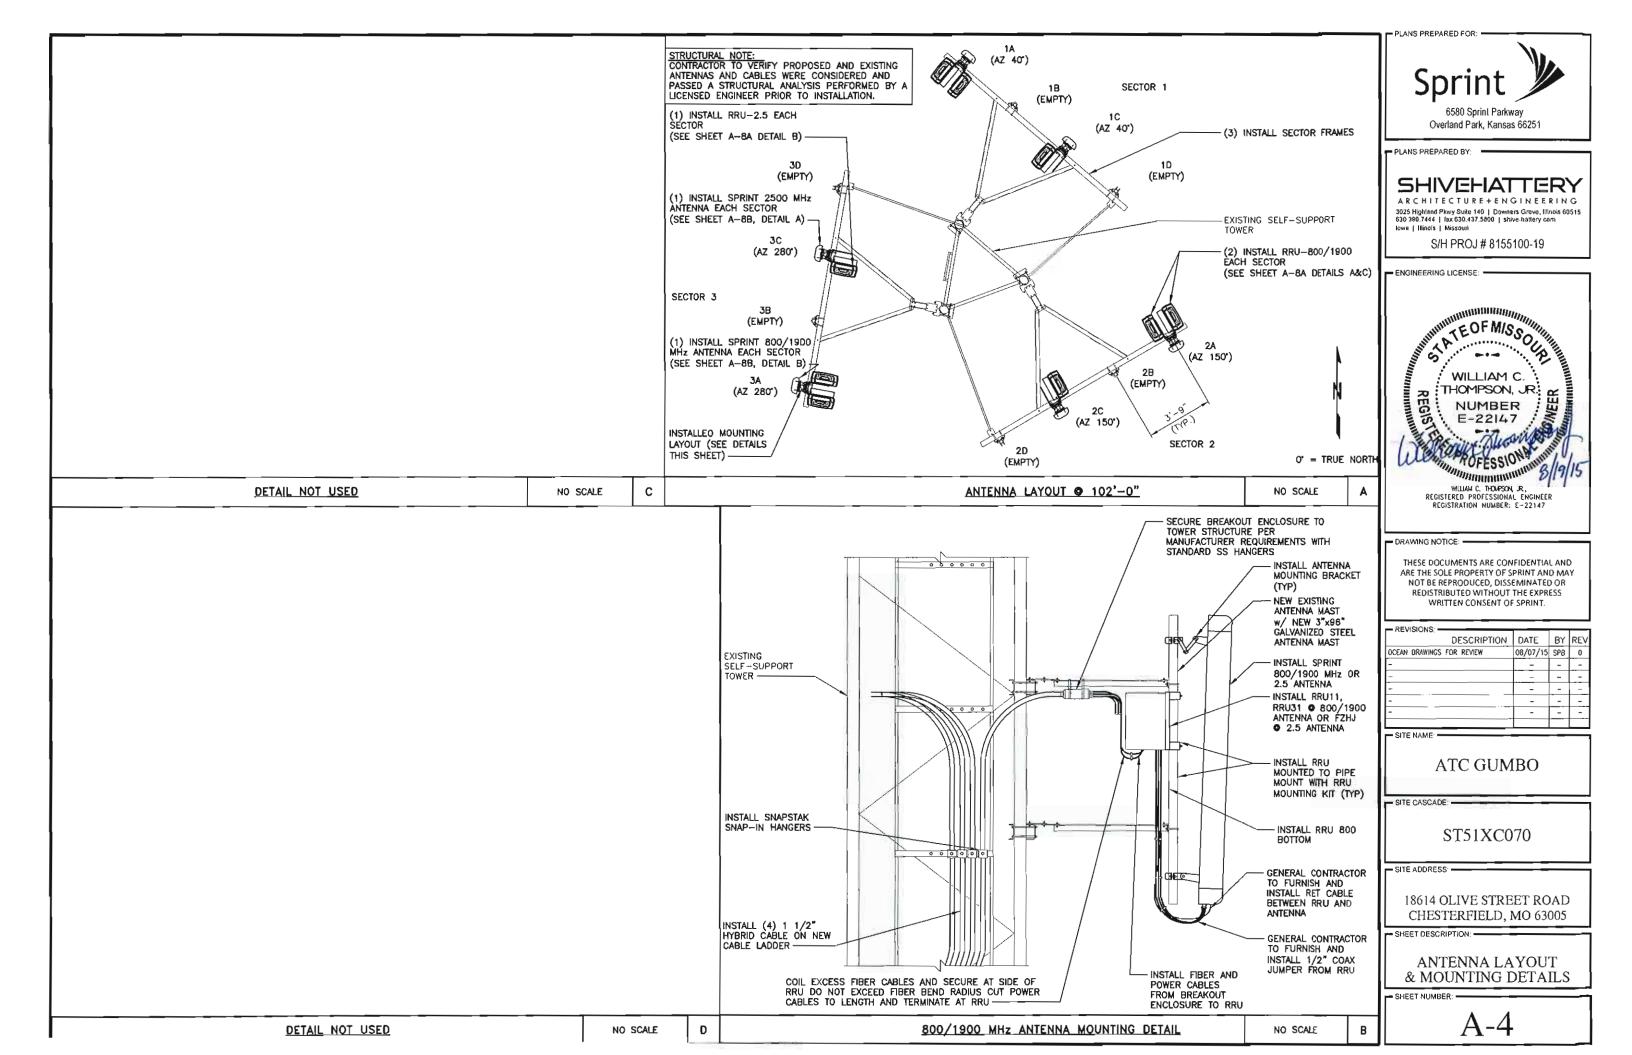
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Part A

RF Des	sign Sheet
Basic I	nformation
Cascade Number	ST51XC070
Site Structure Type (Ground Mount, Self-Supporting, Roof Top,etc.,)	self support
Site Name	
Site Number 1 or 2 (for more than 3 sector site)	
99 Market Name	Missouri
OEM	Ericsson
Cluster ID	
Issue Date	6/8/2015
Revision Date	
Solution ID	
PID	
RFDS Engineer (OEM RF Engineer)	
Sprint RF Engineer	Jeff Tomlin
Sprint RF Engineer (phone/e-mail)	
Sprint RF Manager	
Sprint RF Manager (phone/email)	
RF Need By Date	
Project Description	ATC Gumbo
Siterra Project Schedule Name	

	Location Information
Latitude (≥ 6 decimal places)	38.69250003 °
Longitude (≥ 6 decimal places)	-90.66583332 °
Site Elevation - Mean Sea Level (MSL) (ft)	582ft
Address	
City, State, Zip Code	Chesterfield Missouri 63005
County	St. Louis

Part B

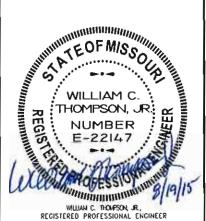Antenna1 Configuration	Sector 1	Sector 2	Sector 3
Azimuth (True North, not magnetic)	40 °	150 °	280
Antenna Radiation Center - Above Ground Level (AGL - ft)	66ft	66ft	66ft
Antenna Manufacturer	Commscope	Commscope	Commscope
Antenna Model	TTTT65AP-1XR	TTTT65AP-1XR	TTTT65AP-1XR
Antenna Qty	1	11	1
Antenna Mechanical Downtilt (+down -up)	0 •	0 °	0
Antenna Electrical Downtilt (800 1900 2500)	0°	0 °	0 °
Antenna Actual Length			
Combined with ²			
Antenna2 Configuration	Sector 1	Sector 2	Sector 3
Azimuth (True North, not magnetic)	40 °	150 °	280
Antenna Radiation Center - Above Ground Level (AGL - ft)	66ft	66ft	66ft
Antenna Manufacturer	RFS	RFS	RFS
Antenna Model	APXVSPP18-C-A20	APXVSPP18-C-A20	APXVSPP18-C-A20
Antenna Qty	1	1	1
Antenna Mechanical Downtilt (+down -up)	0 °	0 °	0
Antenna Electrical Downtilt (800 1900 2500)	0°	0 °	0.0
Antenna Actual Length			

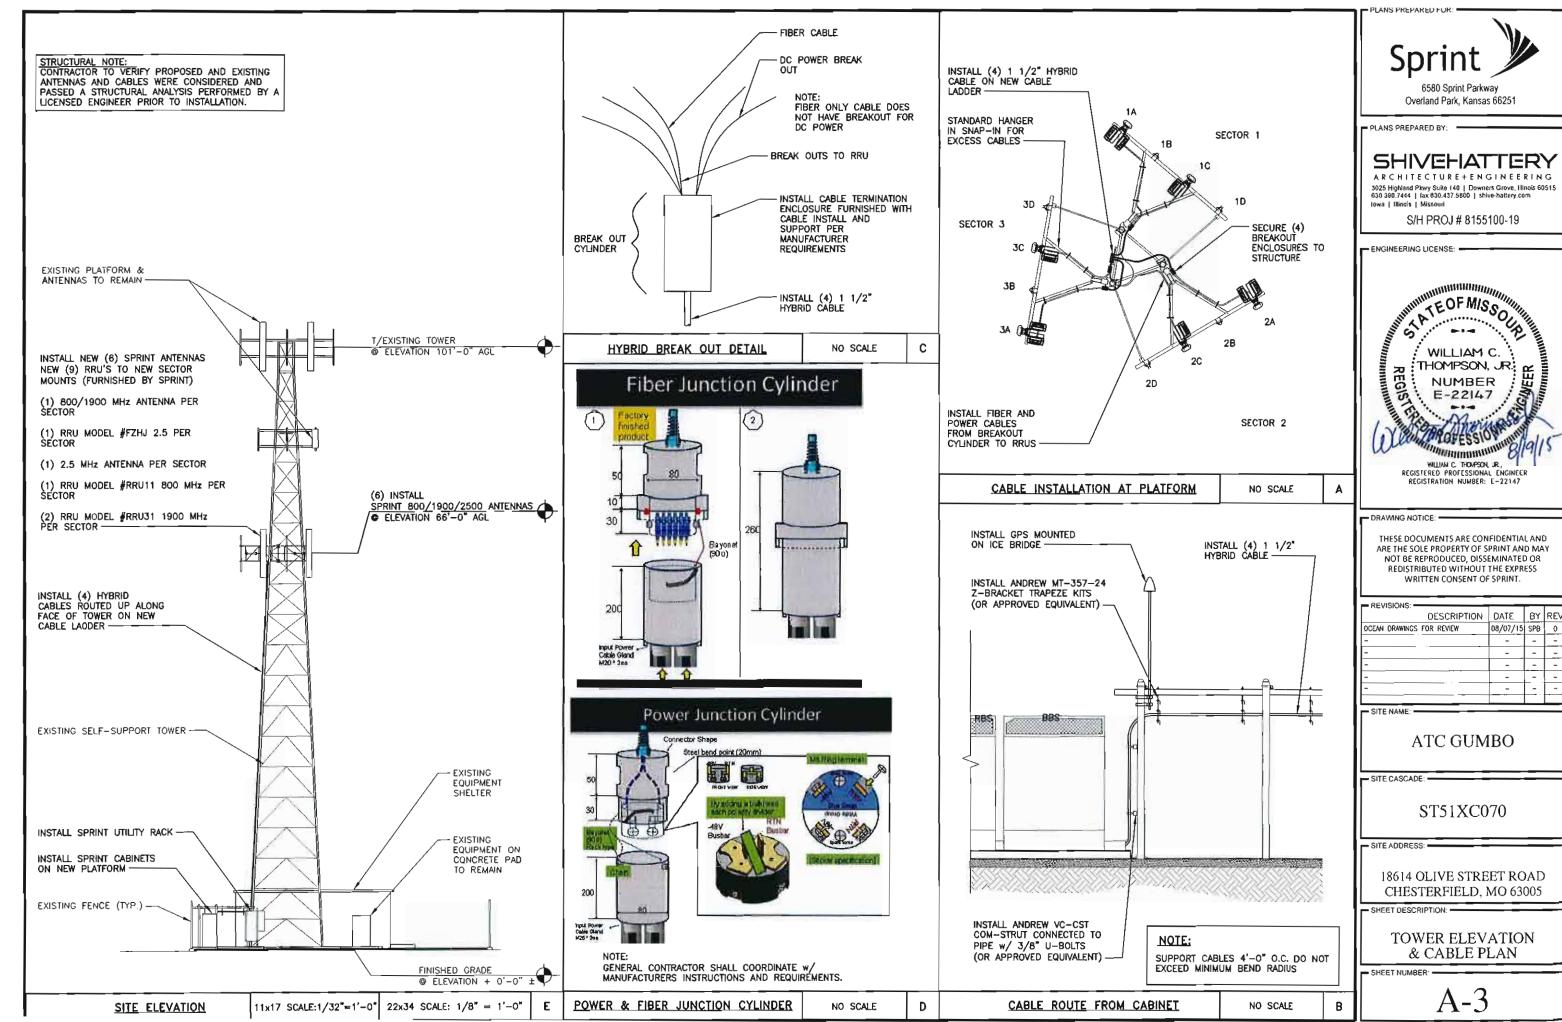

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L SITE NAM

ATC GUMBO

SITE CASCADE: -

ST51XC070

SITE ADDRESS:

18614 OLIVE STREET ROAD CHESTERFIELD, MO 63005

SHEET DESCRIPTION: -

RF DATA SHEET

SHEET NUMBER:

A-5A

Part D	Sector 1	Sector 2	Sector 3
Bottom Jumper Make/Model/Coaxial Kit - (Ground Mounted System)			
Bottom Jumper Coax Quantity - (Ground Mounted System)			
Bottom Coax Jumper length in feet - (Ground Mounted System)			
Main Coaxial Length - (Ground Mounted System)			
Main Coax Make/Model - (Ground Mounted System)			
Main Coax Quantity - (Ground Mounted System)			
Main Cable Size Outside Diameter (inches) - (Ground Mounted System)			
RRU Coaxial Jumper Length to Antenna (Tower or Ground Mounted RRUs)			
RRU Coaxial Jumper Make/Model - (Tower or Ground Mounted RRUs)			
RRU Coaxial Jumper Size Outside Diameter (inches) - (Tower or Ground Mounted RRUs)			
Unique Combiner, Splitter, Connector			
AISG Make Model/Kit			
Upper Diplexer/Triplexor/Duplexor Model			
RF Filter Make/Model			
RF Filter Quantity			
Site Structure Type (Ground Mount, Standard Tower, Roof Top,etc.,) Use same Structure			
description located in NRM	self support	self support	self support
Required Eithernet Size			
800 Radio Configuration 3G	2T2R	2T2R	2T2R
300 Radio Configuration LTE	2T2R	2T2R	2T2R
1900 Radio Configuration 3G	2T2R	2T4R	2T2R
900 Radio Configuration LTE	2T2R	2T4R	2T4R
2.5 Radio Configuration LTE			
Split Mode (Yes, No)			
or ERC only # RRU 11's	1	1	1
or ERC only # RRU 31's	2	_2	2
inter 800 Part Number	-		
Enter 1900 Part Number			
enter 2500 Part Number			
Plumbing Diagram Number (if available)			

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Part E			
Band Configuration		Sector - Channel	
LITE 2.5 GHz	40978	46578	40978
LTE 2.5 GHz			
LTE 2.5 GHz			-
3G 800	476	476	476
LTE 800	8763	8763	8763
3G 1900 MHz A - F Voice	<u>575</u>	57 <u>5</u>	5 <u>75</u>
3G 1900 MHz A - F Voice	625	625	625
3G 1900 MHz A - F_Voice			
3G 1900 MHz A - F Voice			
3G 1900 MHz A - F Voice			
3G 1900 MHz A - F Voice			
3G 1900 MHz A - F Voice			
3G 1900 MHz A - F Data	475	475	475
3G 1900 MHz A - F Data	600	600	600
3G 1900 MHz A - F Data			
3G 1900 MHz A - F Data			
3G 1900 MHz A - F Data			
3G 1900 MHz A - F Data			
3G 1900 MHz A - F Data	-		
LTE PCS G Block	8665	8665	8665
LTE PCS G Block		8003	8003
LTE PCS G Block		-	
LIE PCS G BIOCK		_	
LTE PCS Block A-F			
LTE PCS Block A-F			
LTE PCS Block A-F			
1900 LTE 5x5 carriers (QTY)	1	1 -	1
1900 LTE 10x10 carriers (QTY)			
1900 LTE 15x15 carriers (QTY)			
1900 LTE 19x15 carriers (QTY)		-	
Tago the sover counses (Gill)			



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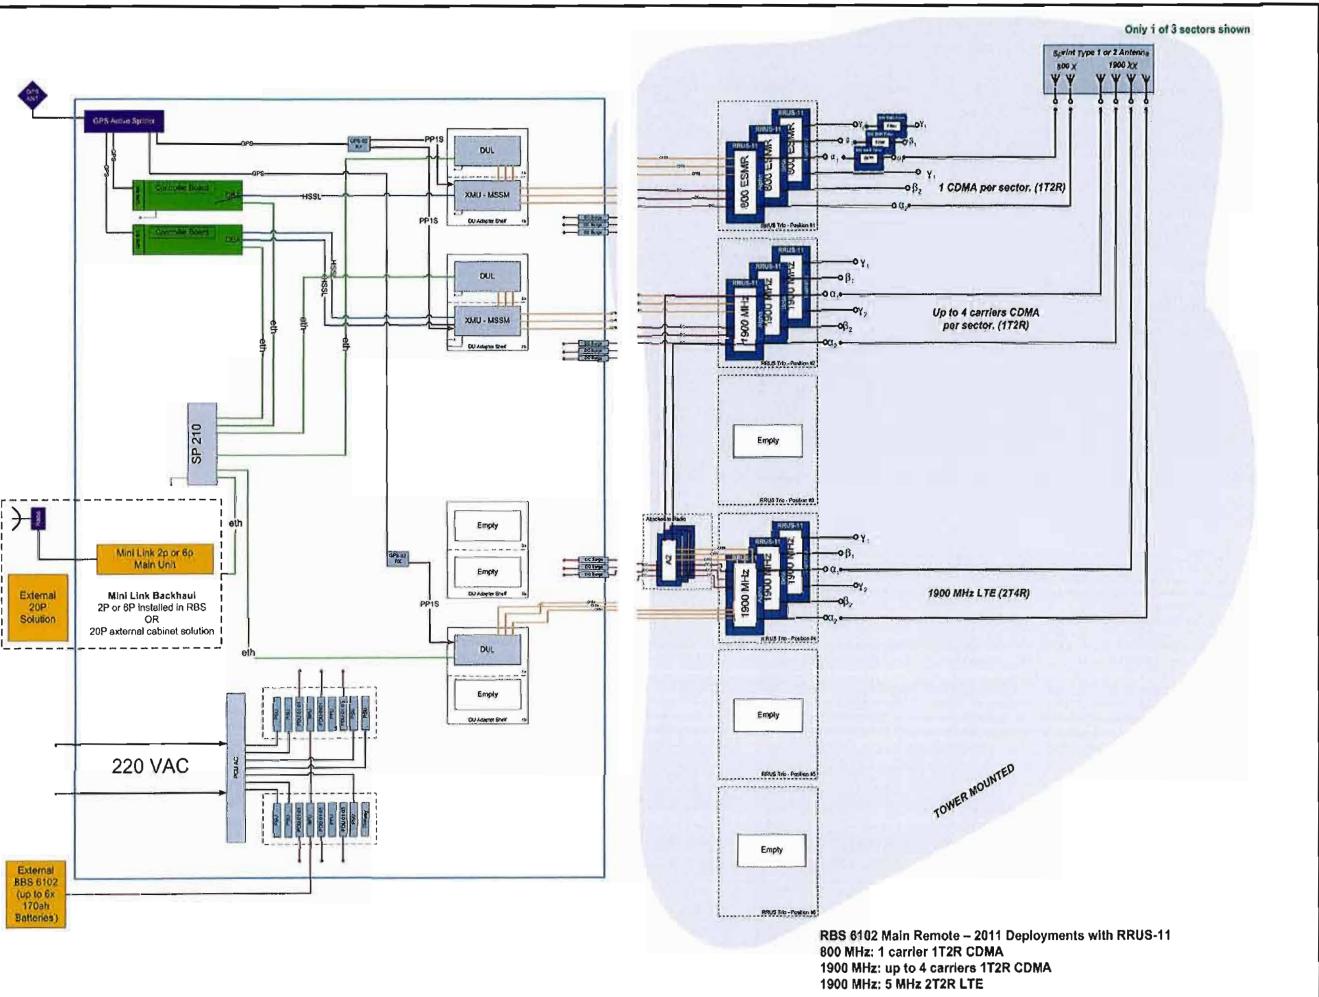
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RF DATA SHEET

SHEET NUMBER: -

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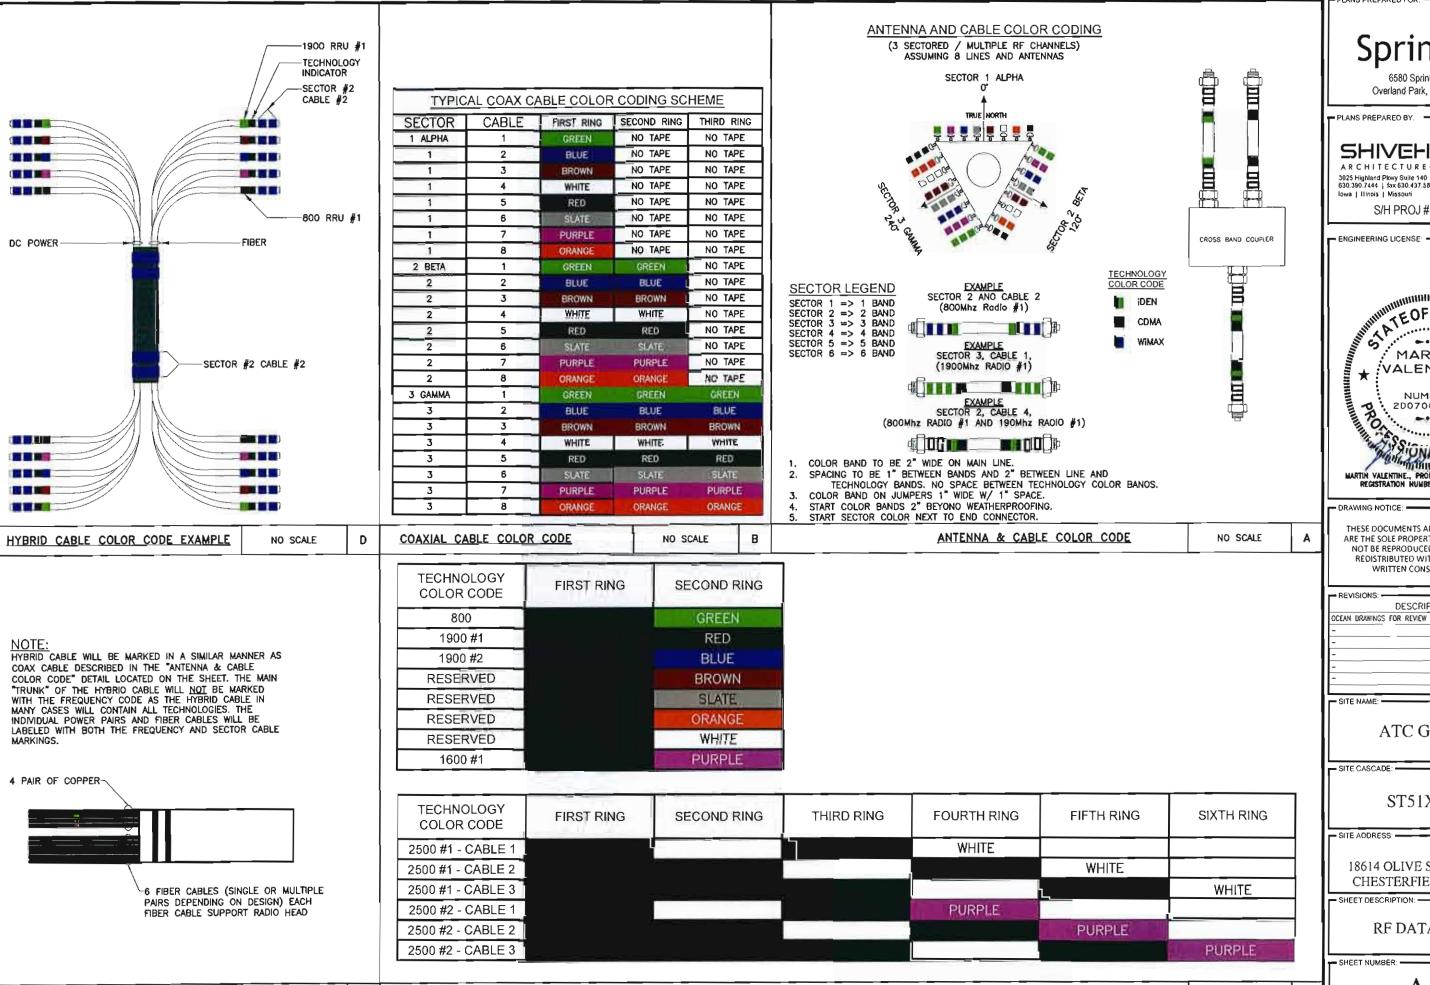
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RF DATA SHEET

SHEET NUMBER:

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HYBRID CABLE COLOR CODE

NO SCALE


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TECHNOLOGY COLOR CODE

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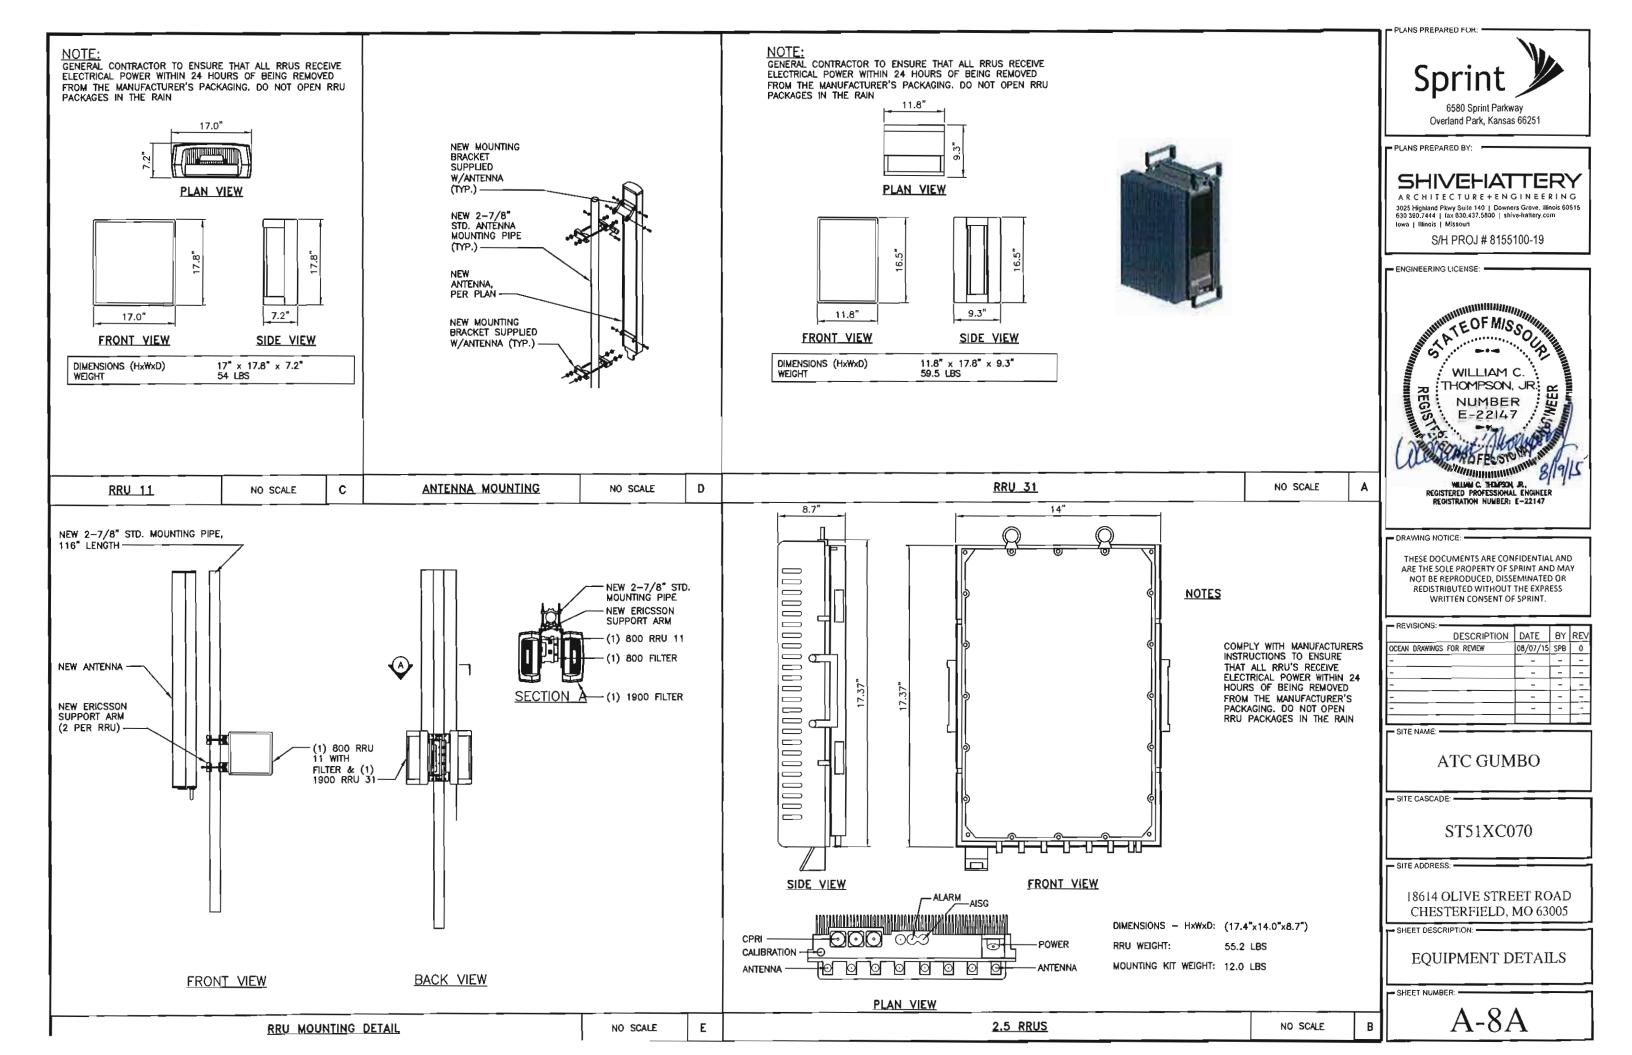
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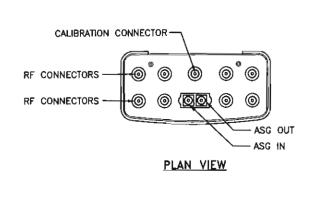
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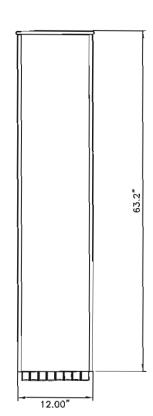
LIGHT GRAY


DIMENSIONS, HxWxD.in(mlm): 63.2"x12.0"x5.0"

WEIGHT:


39.2 lbs

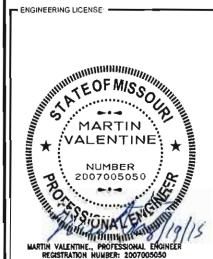



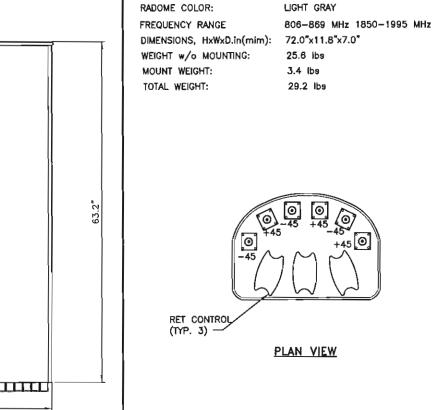

RFS / APXVSPP18-C-A20

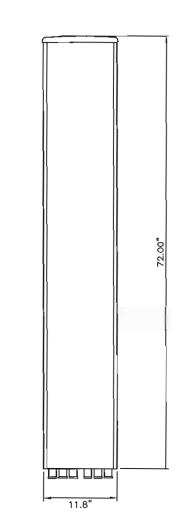



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WILLIAM C. THOMPSON, JR. NUMBER WILLIAM C TREASON, JR., REGISTERED PROFESSIONAL ENGINEER REGISTRATION NUMBER: E-22147

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- SITE CASCADE: -

ST51XC070

SITE ADDRESS: -

18614 OLIVE STREET ROAD CHESTERFIELD, MO 63005

- SHEET DESCRIPTION: -

EQUIPMENT DETAILS

A-8B

2.5 ANTENNA

NO SCALE

800/1900 ANTENNA



general public exposure limit. Obey all posted signs and site guidelines

Upon Switch or Cell Area Entry, Technical Support, or Emergency Please Call Toll Free:

National Operations Control Center (NOCC) 888-859-1400

24 Hours/Day, 7 Days/Week, 365 Days/Year

SITE ID#.



RADIO FREQUENCY ANTENNAS AT THIS SITE

PLEASE EXERCISE CAUTION AROUND ANTENNAS AND OBEY POSTED SIGNS AND/OR MARKINGS


FOR ACCESS TO RESTRICTED AREAS OR FOR FURTHER INFORMATION, PLEASE CALL

1-888-859-1400


IN ACCORDANCE WITH FCC RULES 47 CFR 1.1307(b)

SIGNAGE DETAIL

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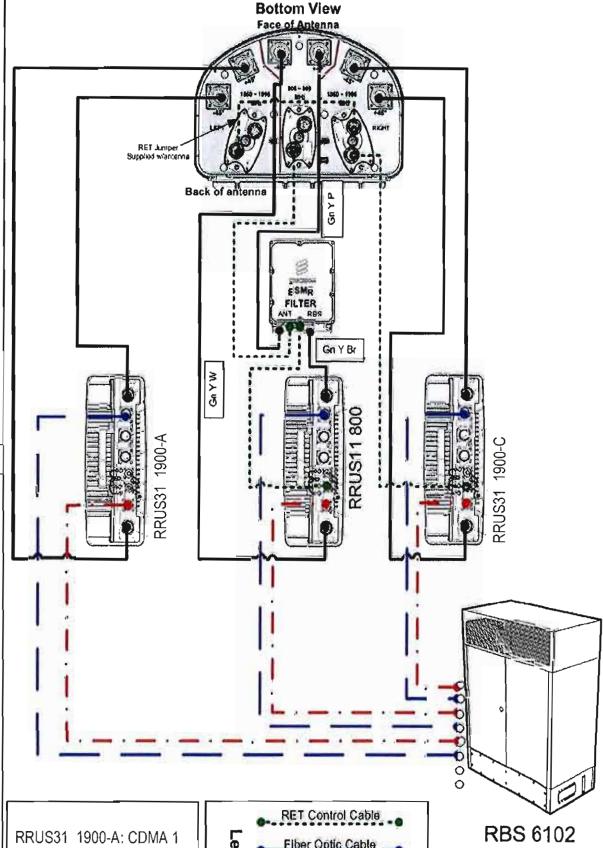


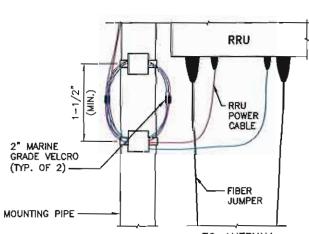- RATED VELCRO WRAPS WILL BE UTILIZED TO BUNDLE FIBER COILS. EXCESS HYBRID FIBER SHALL NOT BE COILED ON THE ANTENNA SUPPORT STRUCTURE. FIBER OPTIC COILS AND BENDS SHALL NOT BE LESS
- THAN THE MANUFACTURER'S BEND RADIUS

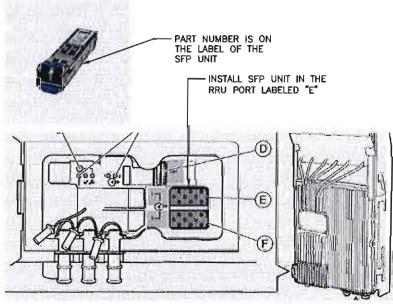

- VERIFY THE PART NUMBER RDH 102 47/2 IS THE SFP USED FOR THE REMOTE RADIO AND DIGITAL UNIT FIBER CONNECTION.

 IF THE SFP UNITS ARE NOT AVAILABLE, DO NOT SUBSTITUTE WITH ANY OTHER
- NOTIFY YOUR LEAD OR IMPLEMENATION MANAGER OF THE ISSUE AND GET THE CORRECT SFP UNITS BEFORE PROCEEDING.



RFS 800 / 1900 Antenna

RRUS31 1900-C: LTE RRUS11 800: CDMA

RF Coax Jumper Cable


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SHEET DESCRIPTION:

EQUIPMENT DETAILS

A-8C

TO ANTENNA EXCESS FIBER OPTIC RRU JUMPER CABLES SHALL BE COILED AND SECURED TO THE ANTENNA/RRU SUPPORT STRUCTURE USING APPROVED CABLE SUPPORT BLOCKS. FIBER JUMPER STORAGE COILS SHALL BE PLACED AS CLOSE TO THE RRU AS POSSIBLE. 2" OUTDOOR RATED VINYL TAPE OR OUTDOOR (UV)

COIL CABLE CONTROL

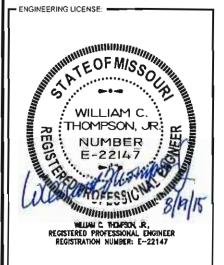
NO SCALE

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SFP DETAIL

NO SCALE

RFS ANTENNA RET CABELING DIAGRAM

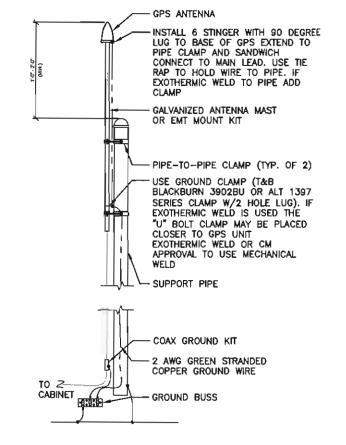

(5) POWER CABLES -H+S DIAMETER MINIMUM SQUID BOX -BEND RADIUS (IN) (LB/FT) (IN) **METERS** 30 84132555 40 50 84132556 60 84132557 84132558 1-3/8 70 14.03 84132559 1-3/8 14.03 84132560 1-3/8 14.03 0.64 (6) FIBER OPTIC CABLE 100 84132561 1-3/8 14.03 0.64

> MLE HYBRID TOWER CABLE NO SCALE

- SNAP-IN HANGER (TYP.)

HOLE FOR GROUND (TYP. BOTH SIDES)

- PVC SLEEPER

- RUBBER MAT

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WILLIAM C.

WILLIAM C. THEMPSON JR., REGISTERED PROFESSIONAL ENGINEER REGISTRATION NUMBER: E-22147

THOMPSON, JR.; 👱

DESCRIPTION DATE BY REV OCEAN DRAWINGS FOR REVIEW 08/07/15 SPB 0

ATC GUMBO

SITE CASCADE: -

ST51XC070

SITE ADDRESS: -

18614 OLIVE STREET ROAD CHESTERFIELD, MO 63005

- SHEET DESCRIPTION:

EQUIPMENT DETAILS

A-8D

ERICSSON MM-BTS RBS 6102		ALARM CONTACT	SEVERITY	OWNER	COMMENTS	COLOR CODE
BTS SCAN POINT 1	{2200} BBS 6102 OPEN DOOR (CABLE SUPPLIED)	NC	MINOR	SERVICE ASSURANCE	RBS/RIGHT OVP1/A1	BLACK/BROWN
BTS SCAN POINT 2	{2100} BBS 6102 CLIMATE UNIT FAILURE (CABLE SUPPLIED)	NC	MINOR	FIELD SERVICES	RBS/RIGHT OVP1/A2	RED/ORANGE
BTS SCAN POINT 3	{2008} CDMA DBU1 FAN FAILURE (CABLE SUPPLIED INTERNAL)	NC	MAJOR	FIELD SERVICES	RBS/RIGHT OVP1/A3	WHITE/BROWN
BTS SCAN POINT 4	{1000} UTILITY POWER FAILURE	NC	MAJOR	SERVICE ASSURANCE	RBS/RIGHT OVP1/A4	WHITE/BLUE
BTS SCAN POINT 5	{1200} GENERATOR FAILURE	NC	MAJOR	FIELD SERVICES	RBS/RIGHT OVP1/A5	WHITE/ORANGE
BTS SCAN POINT 6	{1201} GENERATOR RUNNING	NC	MAJOR	NO ACTION. DRMS ONLY	RBS/RIGHT OVP1/A6	WHITE/GREEN
BTS SCAN POINT 7	{1202} GENERATOR LOW FUEL THRESHOLD	NC	MAJDR	FIELD SERVICES	RBS/RIGHT OVP1/A7	WHITE/BROWN
BTS SCAN POINT 8	CUSTOMER DEFINED			_	RBS/RIGHT OVP1/A8	WHITE/SLATE
BTS SCAN POINT 9	{2008} CDMA DBU2 FAN FAILURE (CABLE SUPPLIED INTERNAL)	NC	MAJOR	FIELD SERVICES	RBS/RIGHT OVP2/A1	WHITE/BROWN
BTS SCAN POINT 10	[9000] TOWER TOP LIGHT FAILURE, NOT AM REQUIRED	NC	MAJOR	SERVICE ASSURANCE	RBS/RIGHT OVP2/A2	RED/BLUE
BTS SCAN POINT 11	{9100} TOWER SIDE LIGHT FAILURE, NO NOT AM	NC	MINOR	SERVICE ASSURANCE	RBS/RIGHT OVP2/A3	RED/ORANGE
BTS SCAN POINT 12	USER DEFINED FROM STANDARDS COLUMN A ONLY				RBS/RIGHT OVP2/A4	RED/GREEN
BTS SCAN POINT 13	USER DEFINED FROM STANDARDS COLUMN A ONLY				RBS/RIGHT OVP2/A5	RED/BROWN
BTS SCAN POINT 14	USER DEFINED FROM STANDARDS COLUMN A ONLY				RBS/RIGHT OVP2/A6	RED/SLATE
BTS SCAN POINT 15	USER DEFINED FROM STANDARDS COLUMN A ONLY				RBS/RIGHT OVP2/A7	BLACK/BLUE
BTS SCAN POINT 16	USER DEFINED FROM STANDARDS COLUMN A ONLY				RBS/RIGHT OVP2/A8	BLACK/ORANGE
BTS SCAN POINT 17	{2008} CDMA DBUJ FAN FAILURE (CABLE SUPPLIED INTERNAL) SED CONTACTS WITH NO ALARM CONDITION	NC	MAJOR	FIELD SERVICES	RBS/LEFT OVP1/A1	WHITE/BROWN

MMBTS ALARM SCHEDULE

WEIGHT

0.44

0.44

0.44

0.44

0.64

0.64

С

TYPICAL GPS ANTENNA DETAIL NO SCALE

COAX CABLE TRAY COVER -

1. 6-'0" MAXIMUM SPACING BETWEEN SUPPORTS.

PARTS TO BE FURNISHED & INSTALLED BY CONTRACTOR UNLESS OTHERWISE NOTED.


HOLD-DOWN CLAMP FASTENED

SLEEPER WITH %"x2½" LONG LAG SCREWS -

CABLE TRAY

В

NO SCALE

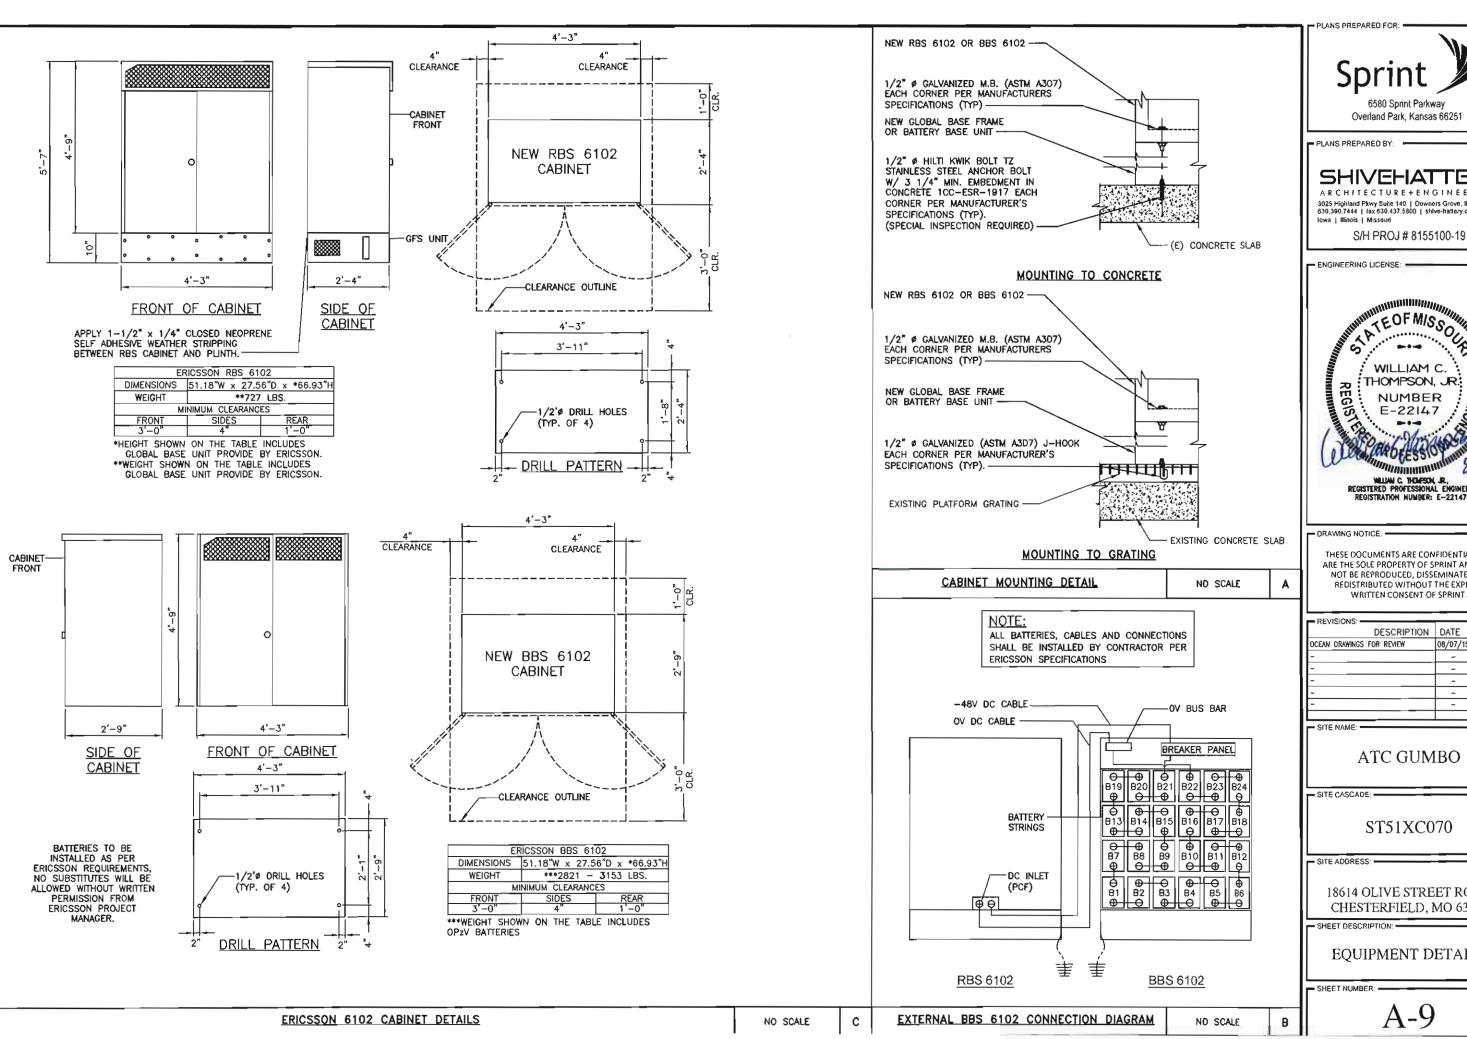


Overland Park, Kansas 66251

SHIVEHATTERY

3025 Highland Pkwy Suite 140 | Downers Grove, Illinois 80515 630,390,7444 | (ax 630,437,5800 | shive-hattery.com

S/H PROJ # 8155100-19

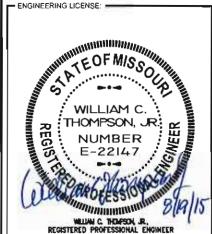

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- SITE CASCADE:

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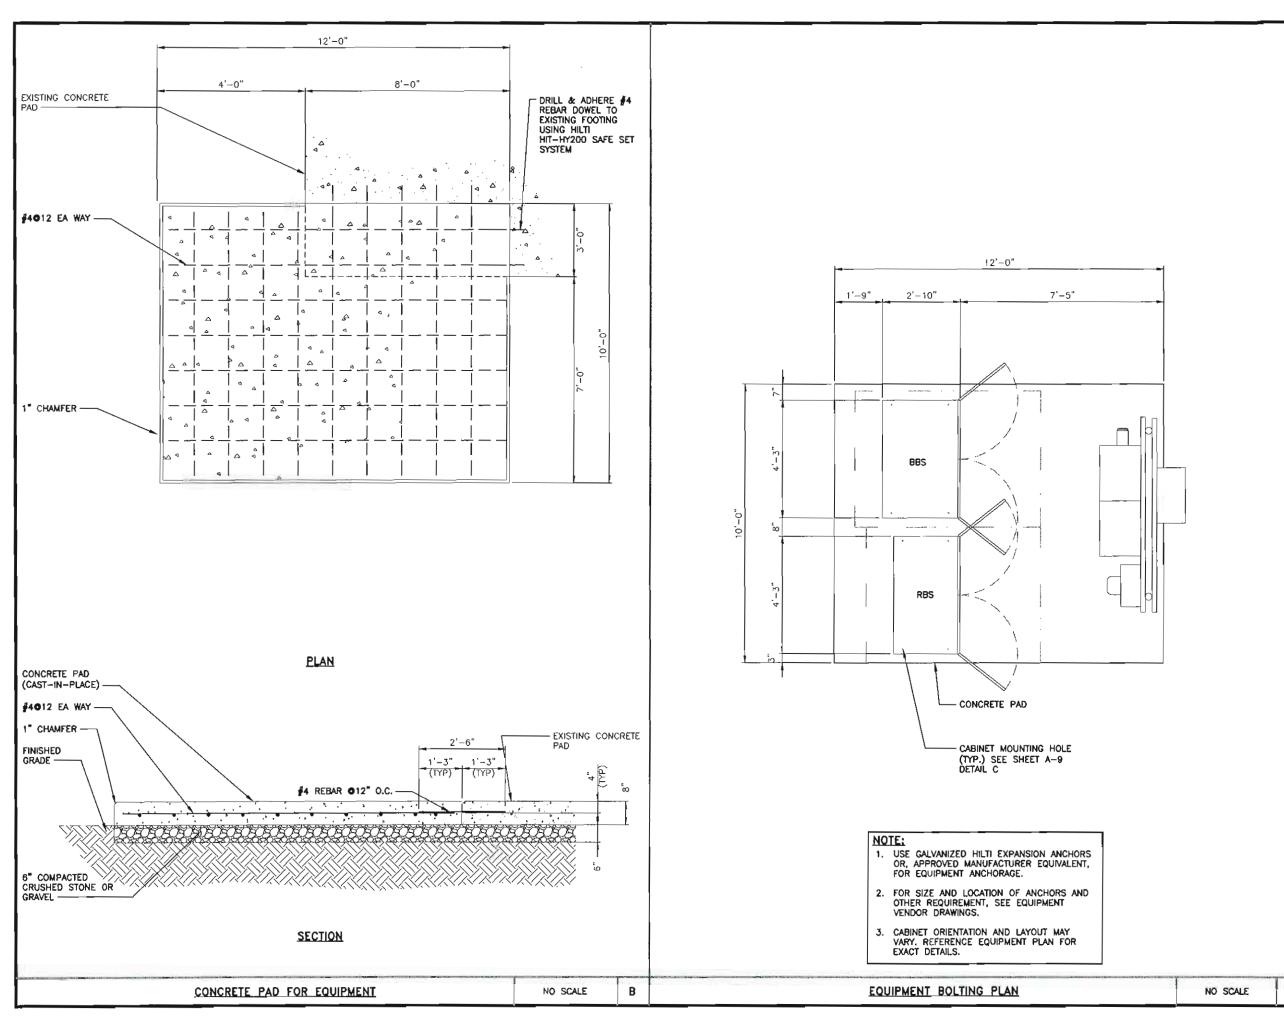
- SITE ADDRESS: •

18614 OLIVE STREET ROAD CHESTERFIELD, MO 63005

- SHEET DESCRIPTION:

EQUIPMENT DETAILS

SHEET NUMBER



Sprint

6580 Sprint Parkway Overland Park, Kansas 66251


PLAN\$ PREPARED BY: -

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ATC GUMBO

SITE CASCADE:

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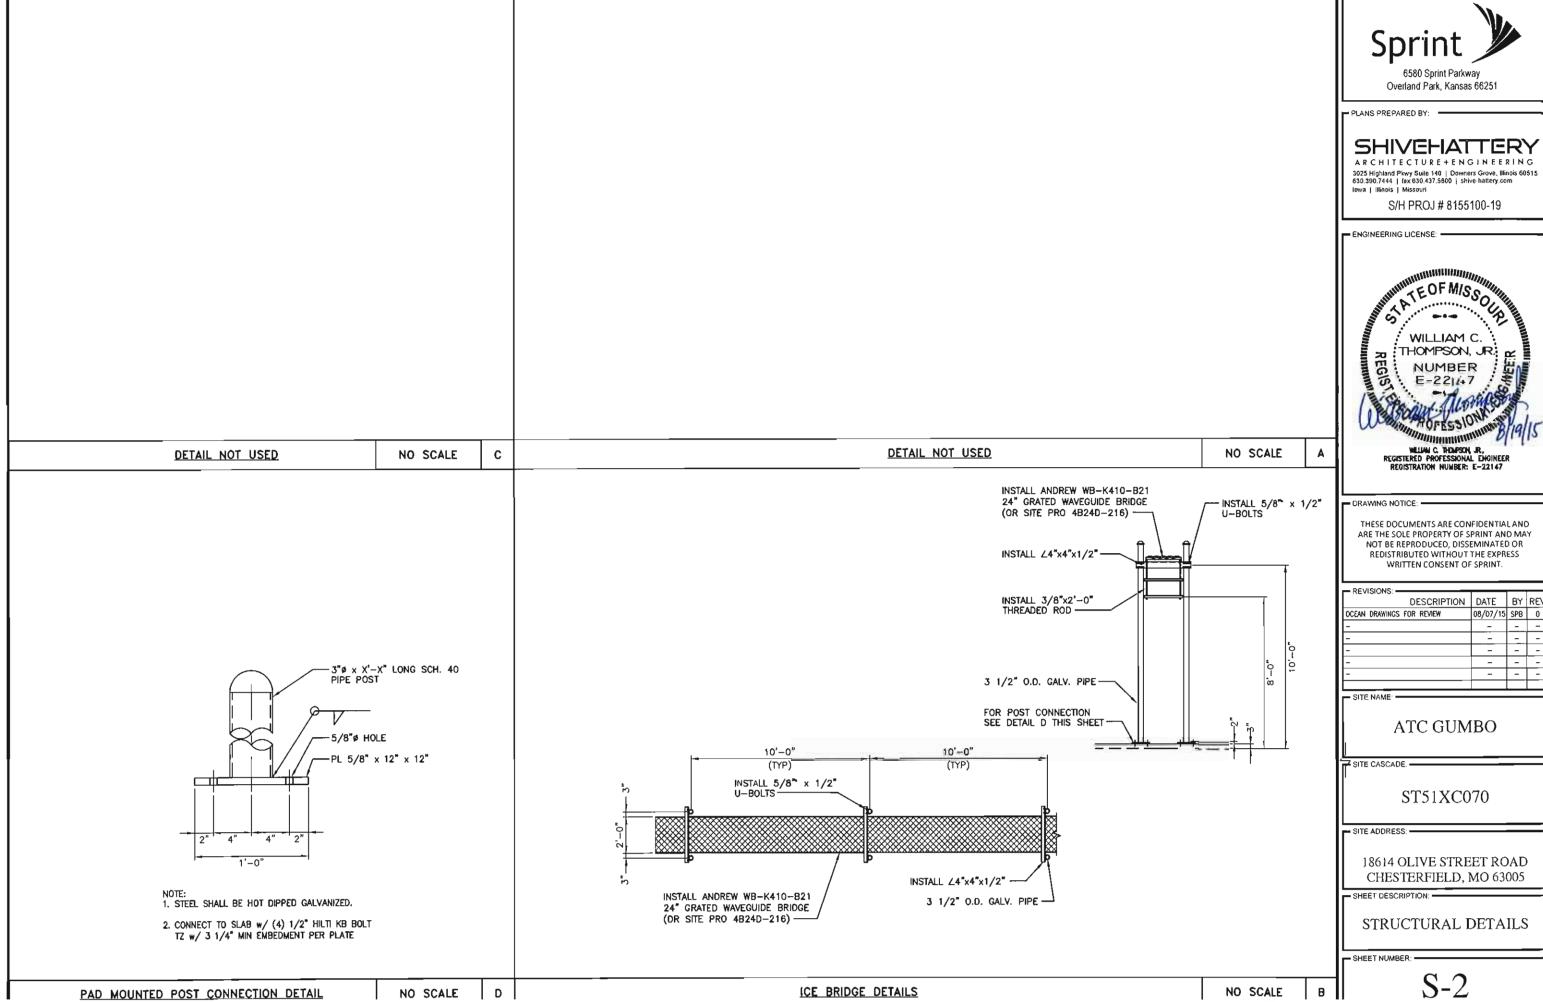
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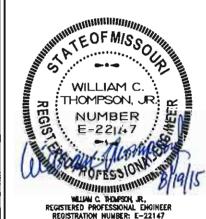
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- SHEET NUMBER: -


S-1

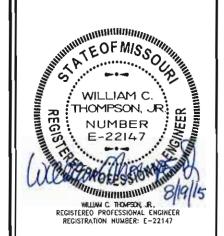

PLANS PREPARED FOR:




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SHIVEHATTERY ARCHITECTURE+ENGINEERING
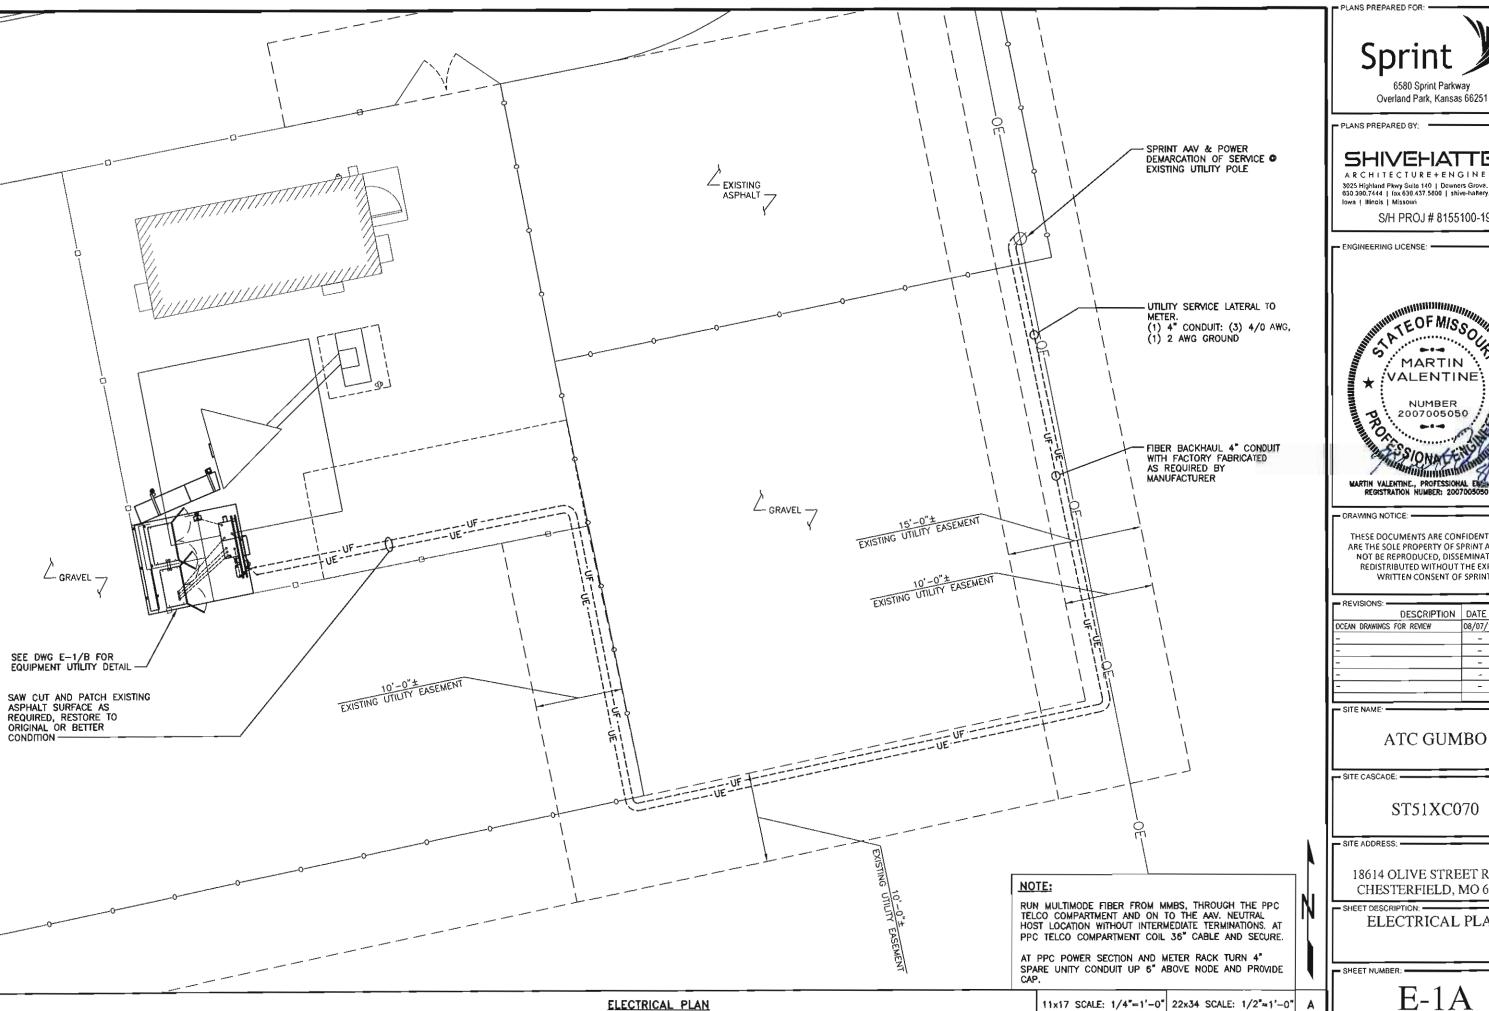
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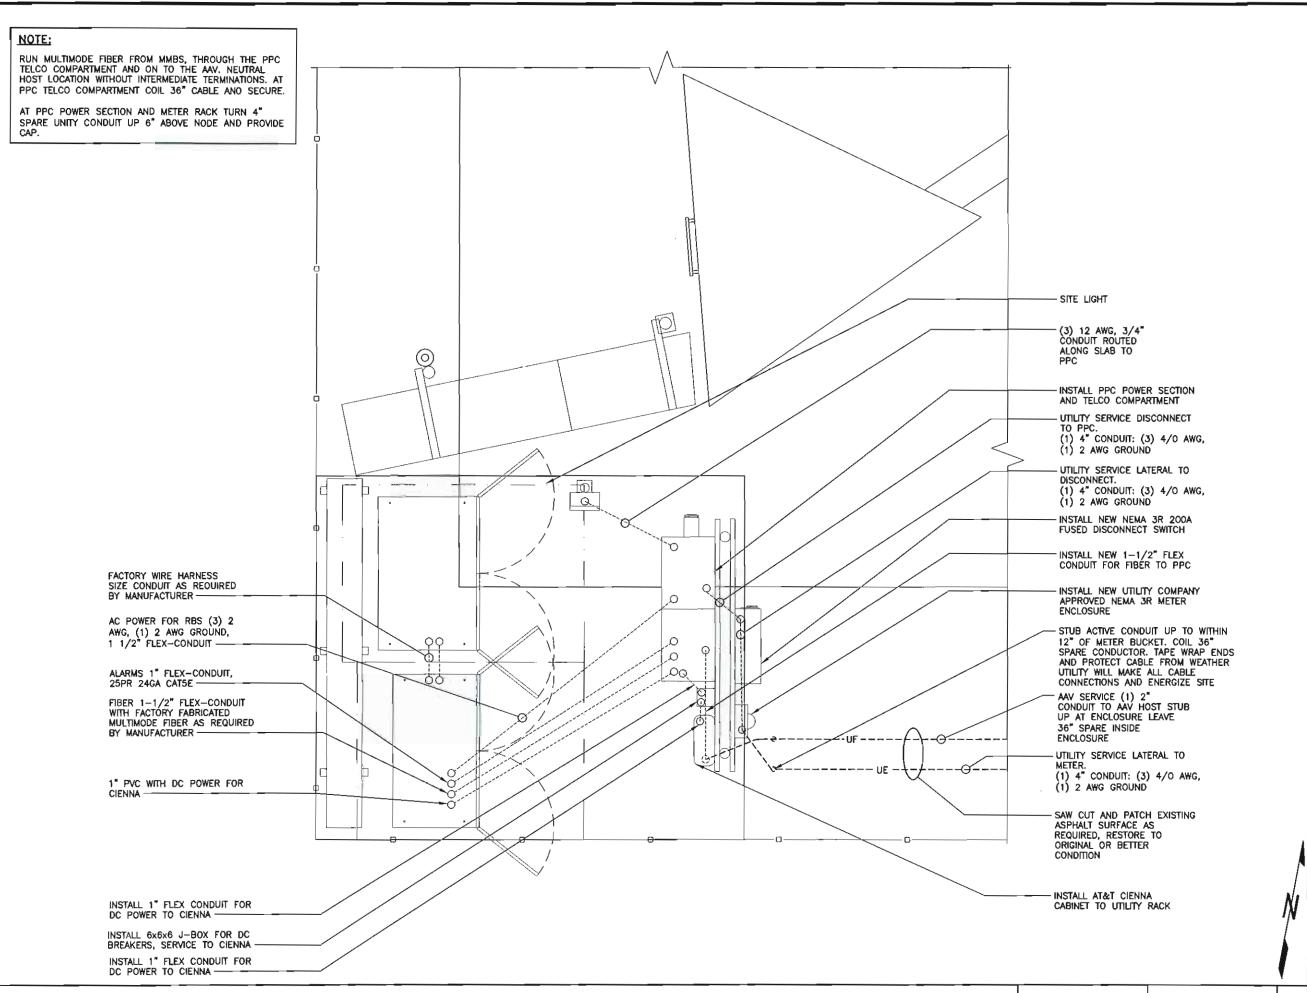
ATC GUMBO

ST51XC070

18614 OLIVE STREET ROAD CHESTERFIELD, MO 63005

ELECTRICAL PLAN

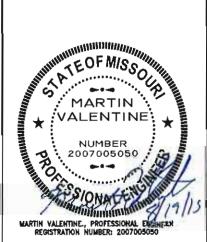E-1A






Overland Park, Kansas 66251

PLANS PREPARED BY:

SHIVEHATTERY

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- SITE NAME: -

ATC GUMBO

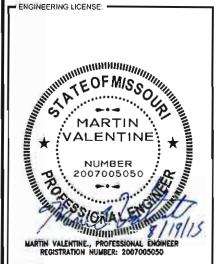SITE CASCADE: -

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SITE ADDRESS: -

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- SHEET DESCRIPTION: -


ELECTRICAL PLAN DETAIL

- SHEET NUMBER: -

E-1B

ELECTRICAL PLAN

11x17 SCALE: 1/4"=1'-0" 22x34 SCALE: 1/2"=1'-0"

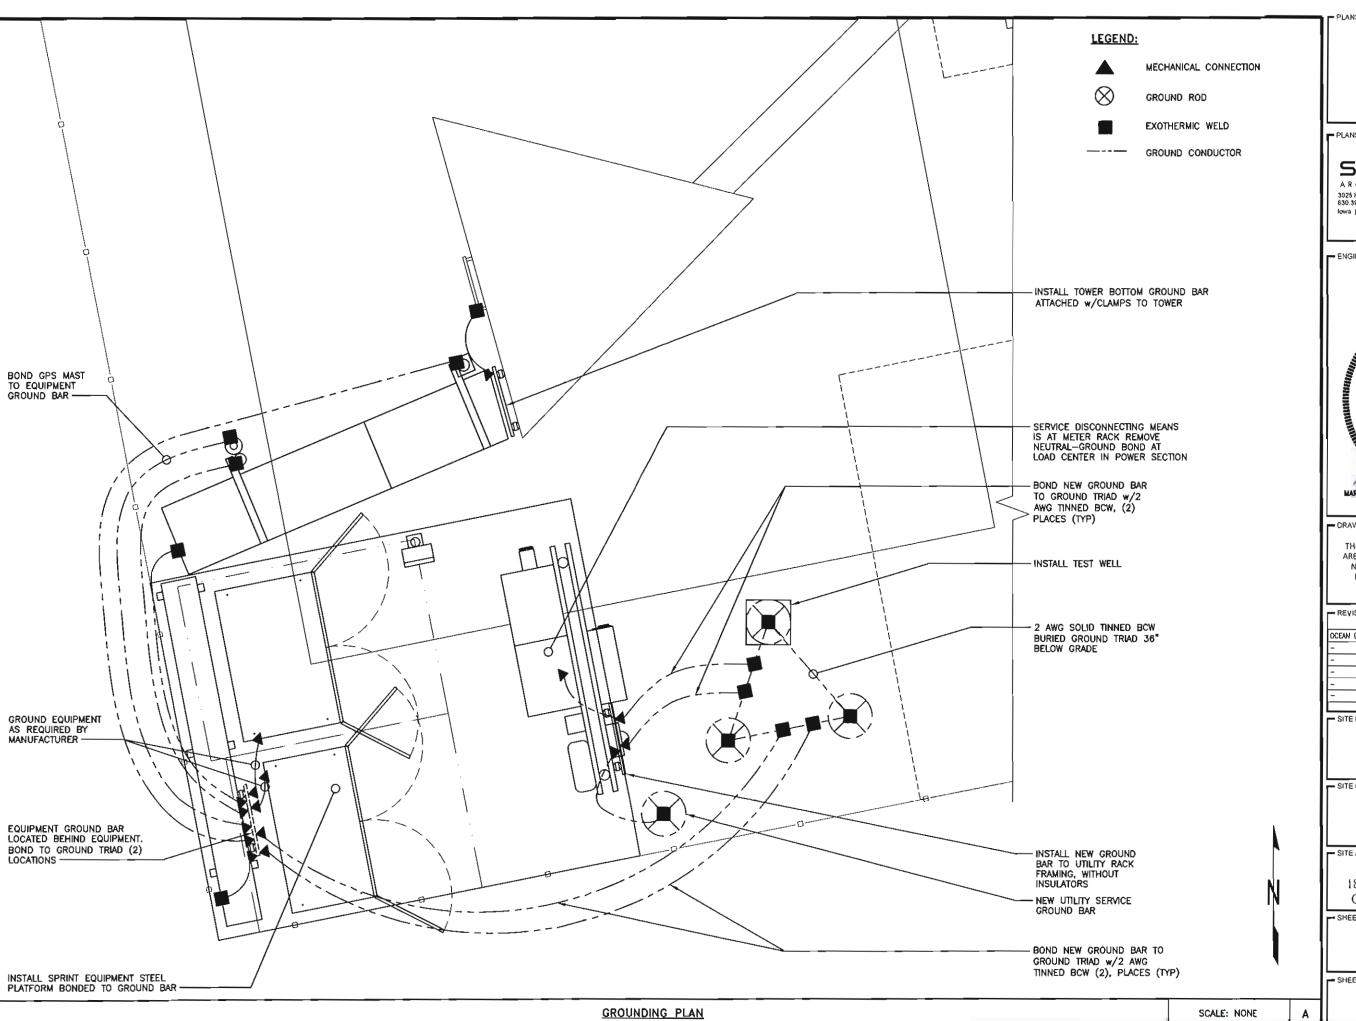

PLANS PREPARED FOR:



6580 Sprint Parkway Overland Park, Kansas 66251


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ATC GUMBO

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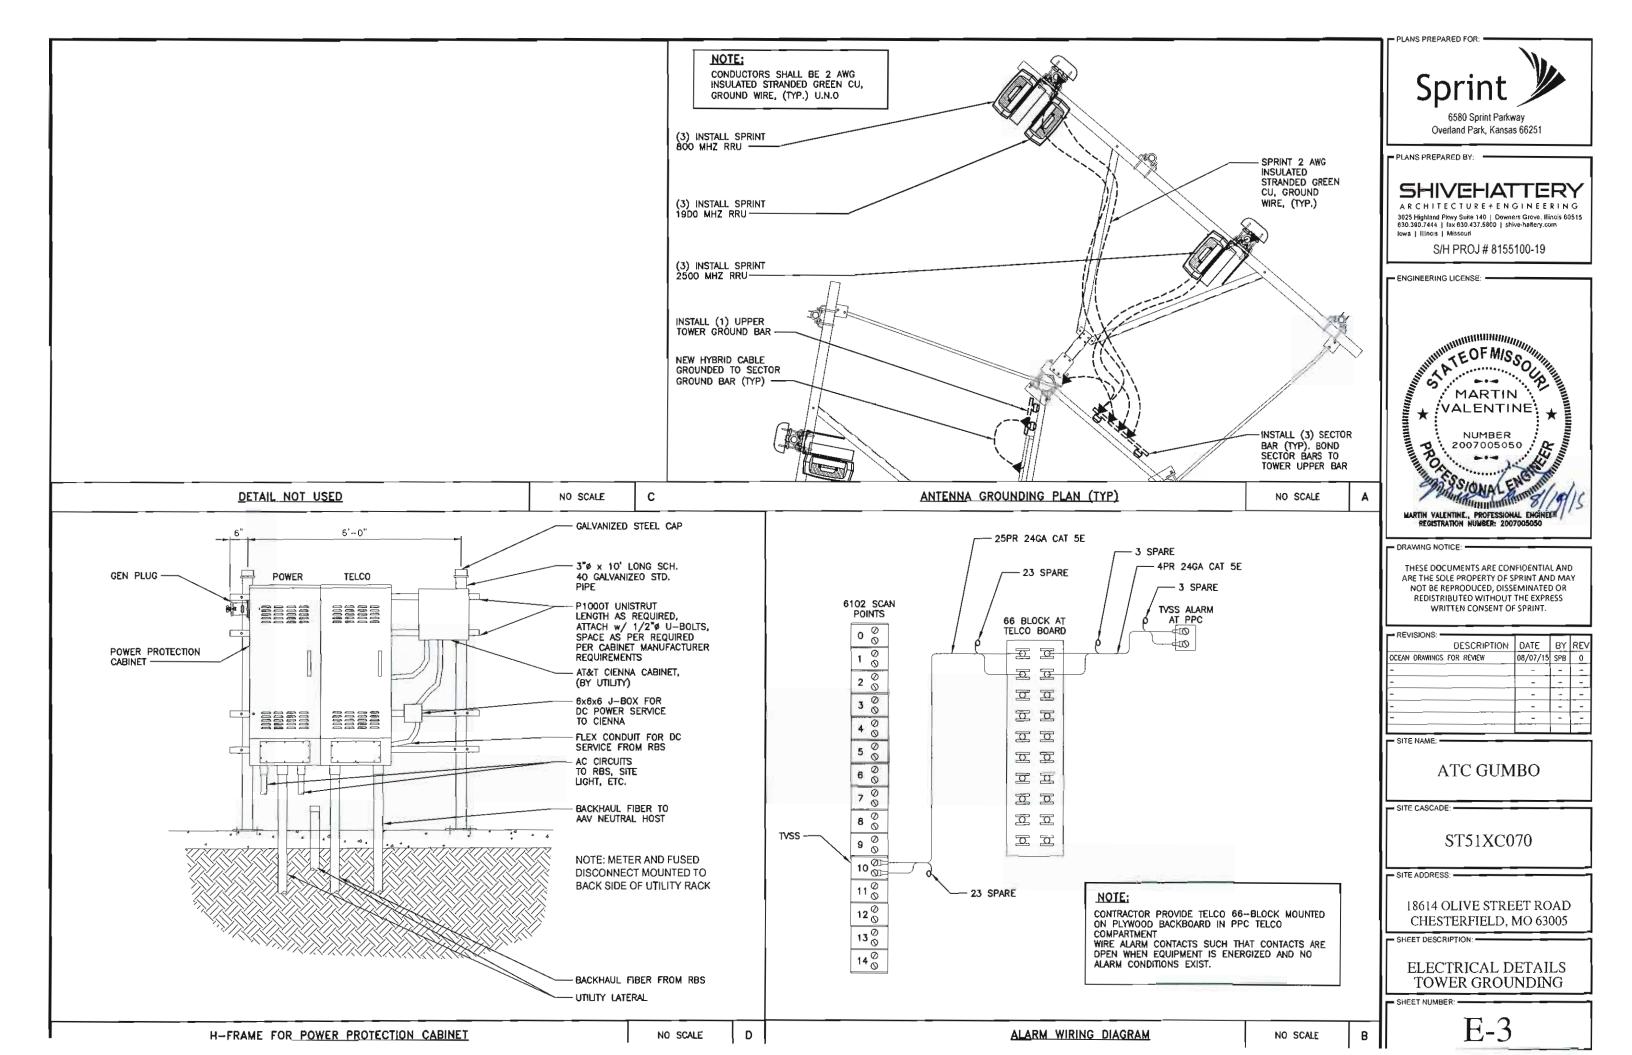
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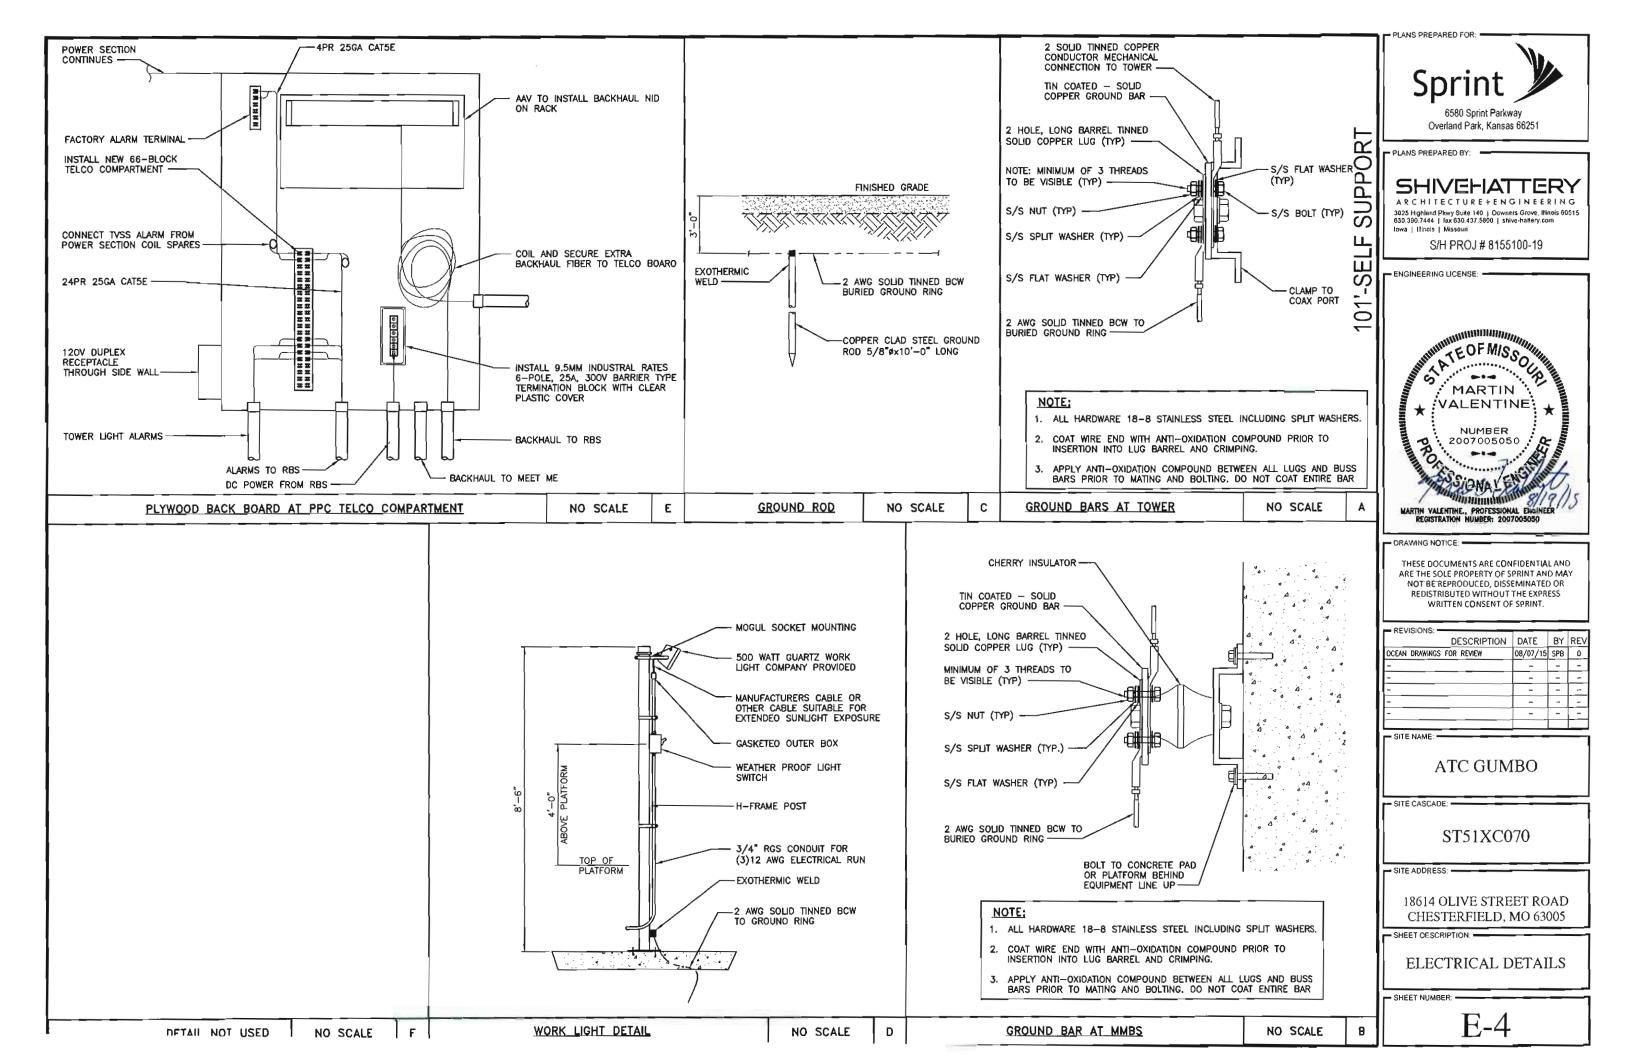
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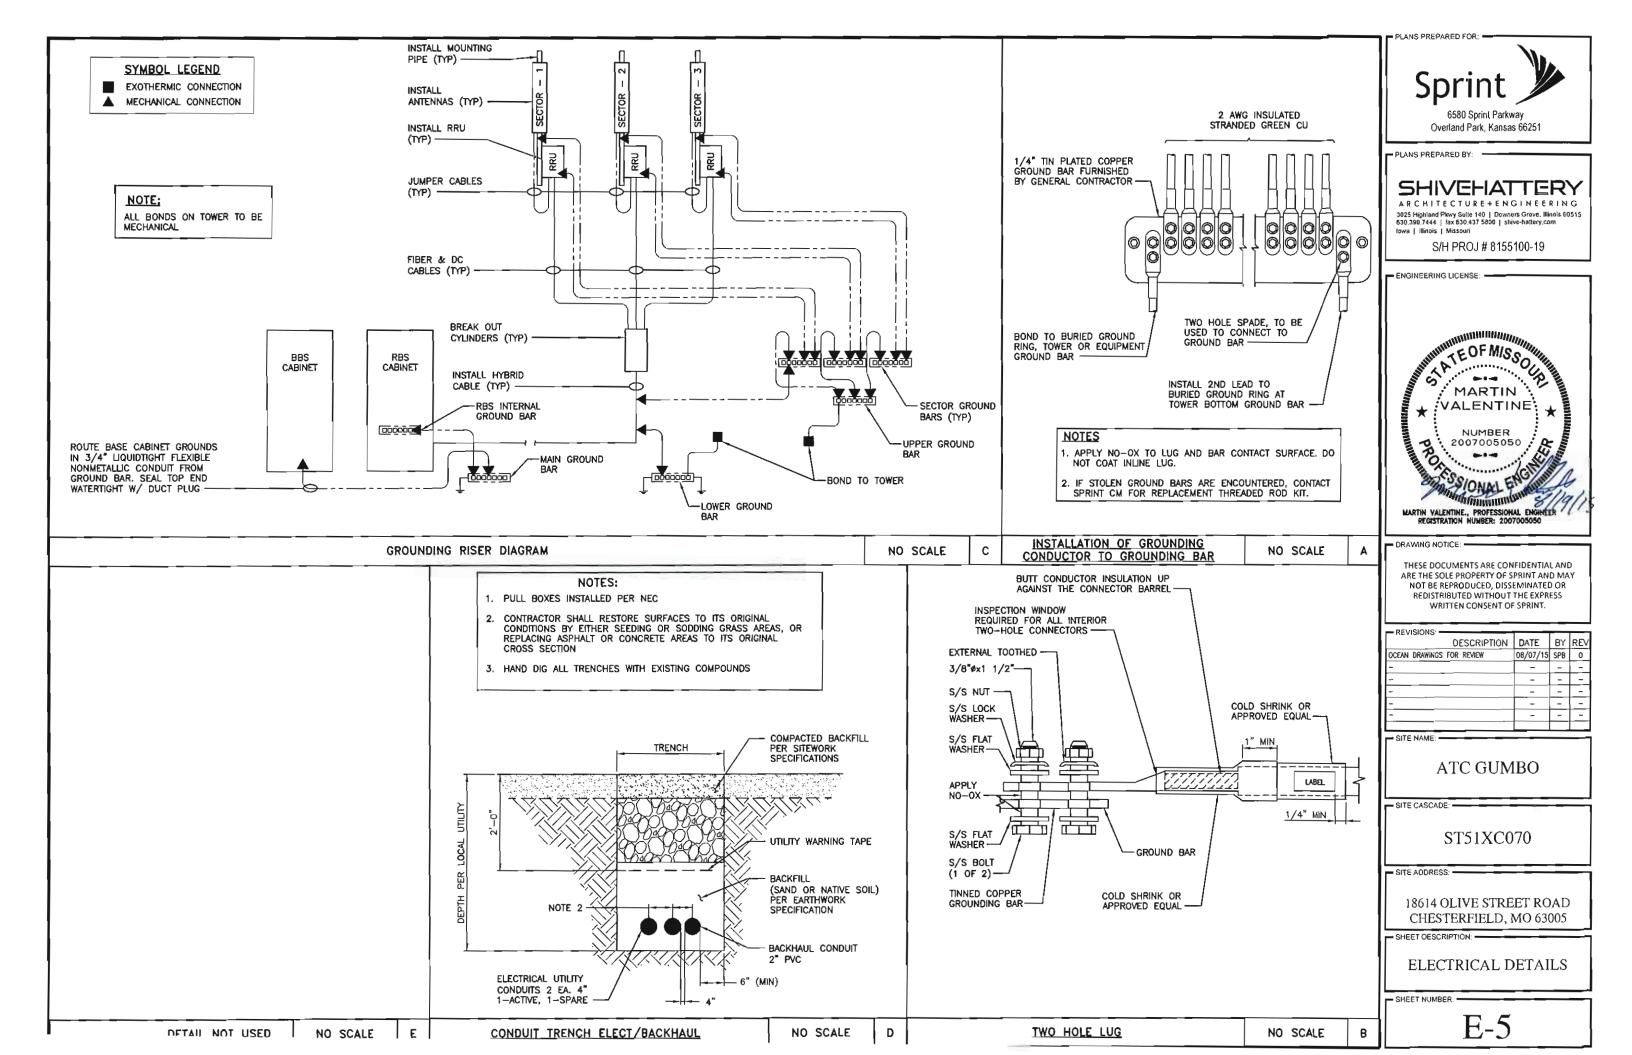
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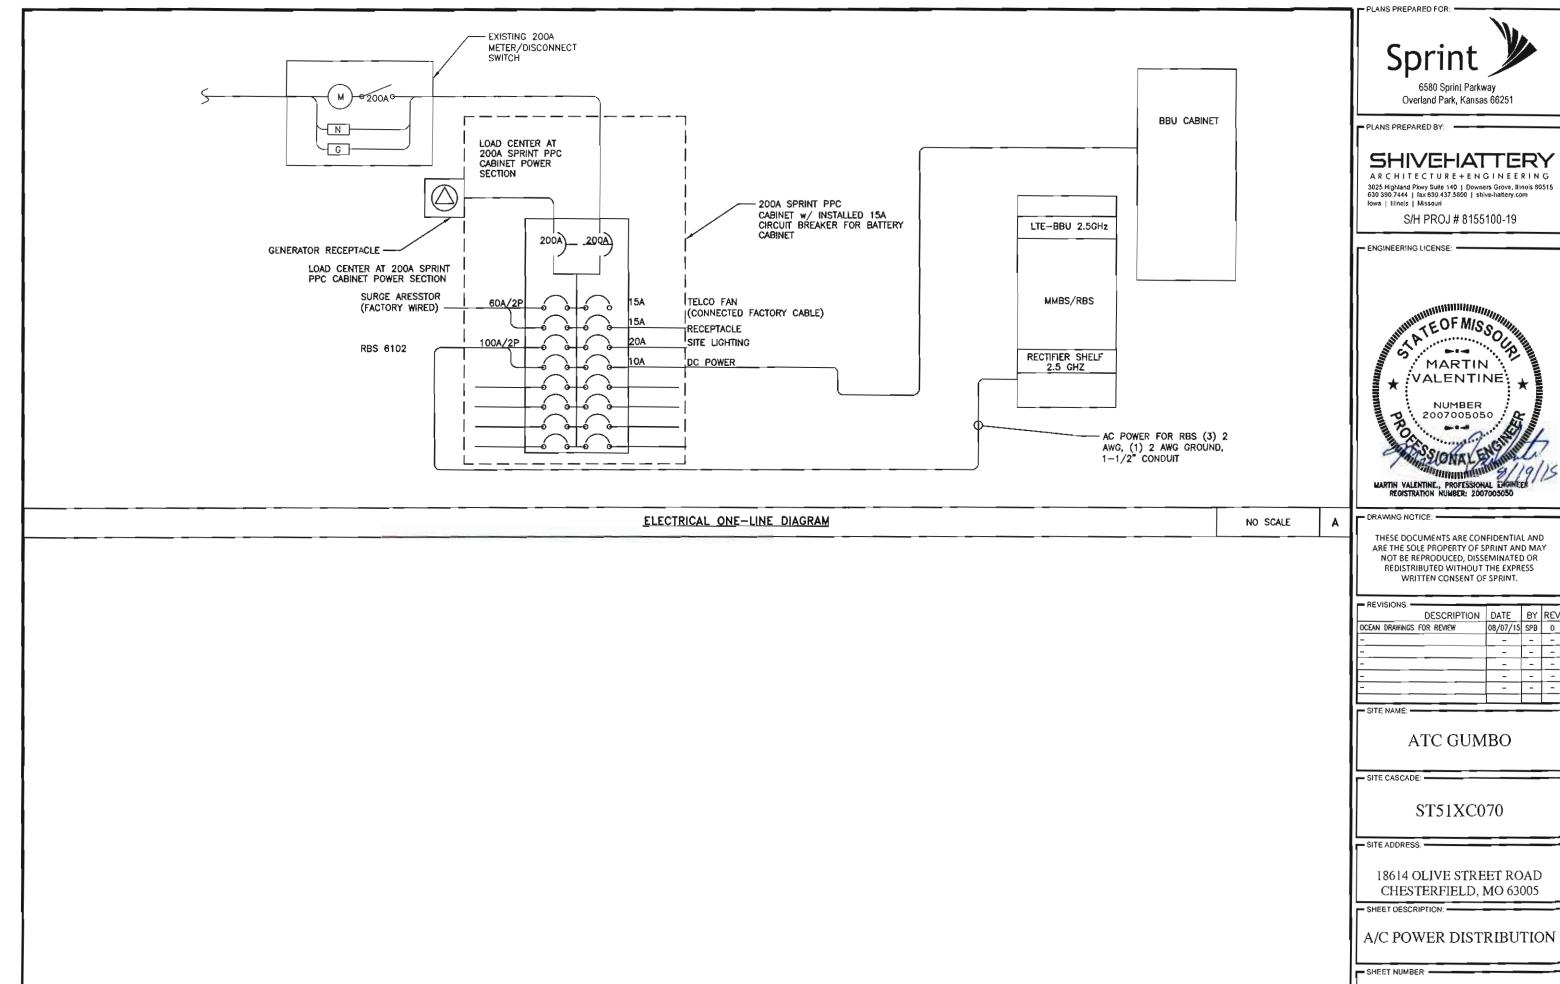
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GROUNDING PLAN









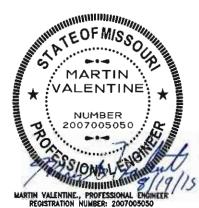


NOT USED

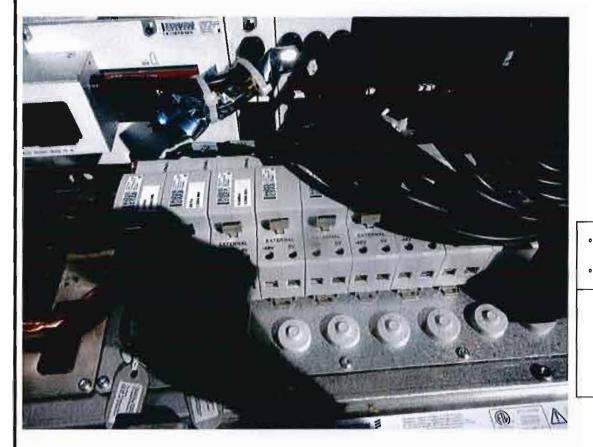

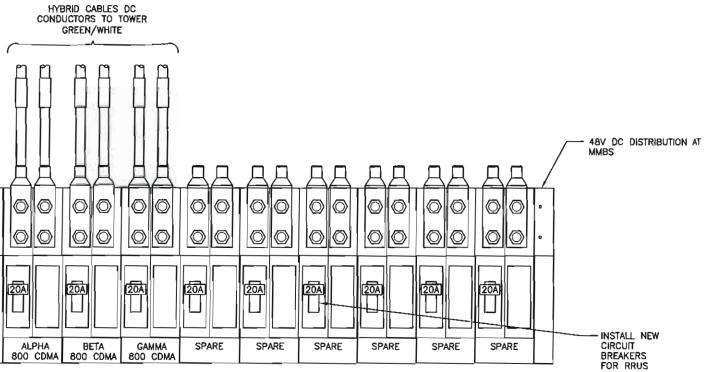

WANTED TO THE PROPERTY OF THE

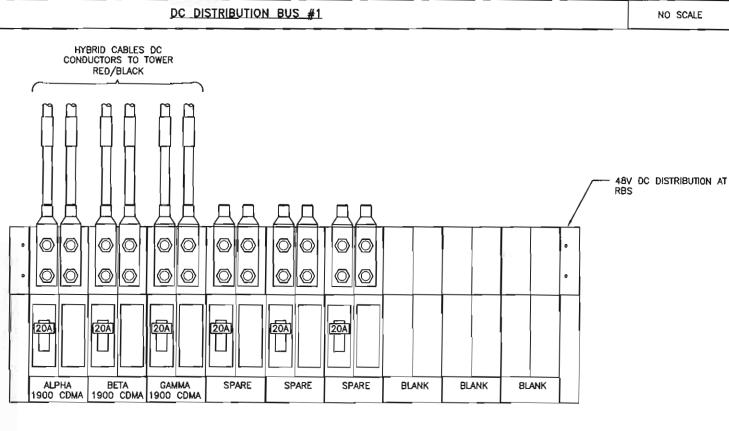



6580 Sprint Parkway
Overland Park, Kansas 66251

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SITE NAME

ATC GUMBO

SITE CASCADE: -

ST51XC070

SITE ADDRESS:

18614 OLIVE STREET ROAD CHESTERFIELD, MO 63005

SHEET DESCRIPTION

D/C POWER DISTRIBUTION

- SHEET NUMBER:

T

DC DISTRIBUTION BUS #2


NO SCALE

E-7





ANTENNA GROUND BAR.

2. WEATHER PROOFING SHALL BE TWO-PART TAPE KIT. COLD

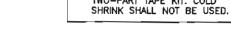

TYPICAL ANTENNA GROUND KIT

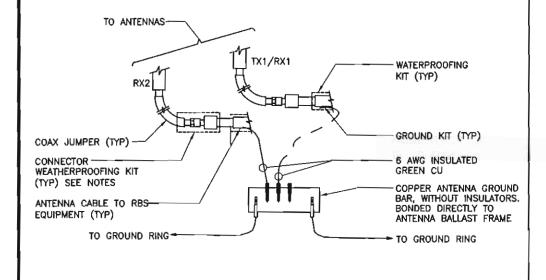

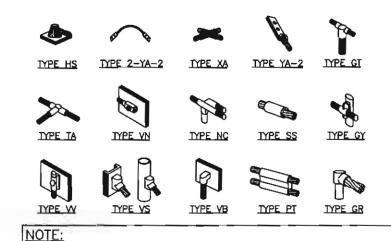

ERICO EXOTHERMIC "MOLD TYPES" SHOWN HERE ARE EXAMPLES, CONSULT WITH

PROJECT MANAGER FOR SPECIFIC MOLDS TO BE USED FOR THIS PROJECT.

WIRE SIZE	BURNDY LUG	BOLT SIZE		
6 AWG GREEN INSULATED	YA6C-2TC38	3/8" - 16 NC S 2 BOLT		
2 AWG SOLID TINNED	YA3C-2TC38	3/8" - 16 NC S 2 BOLT		
2 AWG STRANDED	YA2C-2TC38	3/8" - 16 NC S 2 BOLT		
2/0 AWG STRANDED	YA26-2TC38	3/6" - 16 NC S 2 BOLT		
4/0 AWG STRANDED	YA28-2N	1/2" - 16 NC S 2 BOLT		


EXOTHERMIC WELDS


NOTES:

NO SCALE

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- 1. HARDWARE BOLTS, NUTS, LOCK WASHERS SHALL BE STAINLESS STEEL. HARDWARE IS TO BE AS FOLLOWS: BOLT, FLAT WASHER, GROUND BAR, GROUND LUG, FLAT WASHER AND NUT.
- COPPER SHIELD, ANTIOX, CR NO-OX OR EQUIVALENT SHALL BE PLACE WHERE DISSIMILAR METALS CONNECT.
- LUGS ARE TO BE INSTALLED PER MANUFACTURER'S SPECIFICATIONS.
- 4. FLAT WASHER SHALL NOT OVERLAP ADJACENT LUGS OR WASHERS



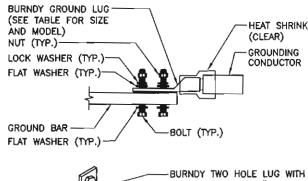

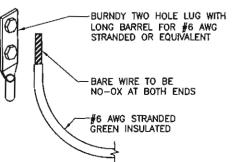

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SITÉ NAME:

ATC GUMBO

SITE CASCADE: -

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SITE ADDRESS: -

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SHEET DESCRIPTION: -

D/C SUB PANEL DETAIL

- SHEET NUMBER

E-8

NO SCALE

C