## III. B.

# Memorandum Department of Planning & Public Works

To: Planning and Public Works Committee

From: Annissa McCaskill-Clay, AICP

Lead Senior Planner

**Date:** July 2, 2010

RE: T.S.P. 24-2010 Clearwire US LLC (Drury Plaza Hotel): A request to

obtain approval for a Telecommunication Siting Permit for the purpose of adding an additional antenna canister and equipment on the roof of a "PC" Planned Commercial District-zoned tract of land located at 355 E.

Chesterfield Center (18S230433).



Clearwire US, LLC, has requested a telecommunications facilities siting permit to allow the following on the roof of the Drury Plaza Hotel:

> Installation of one (1) antenna canister.

Installation of associated equipment to be shielded within the roof parapet.

City of Chesterfield Ordinance 2391, which governs telecommunications and facilities siting, requires that the Planning Commission provide a venue for public hearing of requests for Telecommunications Siting Permits. Please note, the Commission does not provide a recommendation to the City Council, but rather generates a list of issues during the hearing. At the public hearing on June 26, 2010, no outstanding issues were identified.

Attached are copies of the materials submitted to the Planning Commission.

Respectfully submitted,

Annissa McCaskill-Clay, AICP Lead Senior Planner


CC: Michael G. Herring, City Administrator

Rob Heggie, City Attorney

Annissa McCaskill-Clay

Michael O. Geisel, Director of Planning & Public Works Aimee Nassif, Director of Planning & Development Services

Attachments: Planning Commission packet

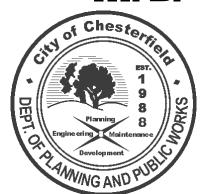





690 Chesterfield Pkwy W • Chesterfield MO 63017-0760 Phone: 636-537-4000 • Fax 636-537-4798 • www.chesterfield.mo.us


# Department of Planning & Public Works City of Chesterfield Public Hearing Summary Report

T.S.P. 24-2010 Clearwire US LLC (Drury Plaza Hotel): A request to obtain approval for a Telecommunication Siting Permit for the purpose of adding an additional antenna canister and equipment on the roof of a "PC" Planned Commercial District-zoned tract of land located at 355 E. Chesterfield Center (18S230433)

The above-referenced project is a request for a Telecommunications Siting Permit (T.S.P.). If the request is approved. the Permit will placement of antennas within a canister from a new user. Clearwire US, on the roof of the Drury Plaza Hotel. Equipment to support the antenna canister will also be placed on the roof and be hidden by the parapet. Another user currently has an antenna canister on the roof. Clearwire's proposed canister would be identical.

Drury Plaza hotel is zoned "PC" Planned Commercial District. On July 17, 2006, the City of Chesterfield approved Ordinance 2281, amended the governing conditions for the hotel to authorize placement of disguised communications antenna on the site. City of Chesterfield Ordinance 2391, which governs telecommunications and facilities siting, requires a public hearing before the City of Chesterfield



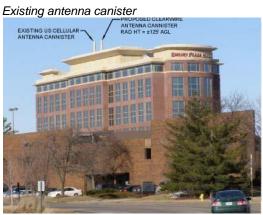

Petitioner's depiction

T.S.P. 24-2010 Clearwire US LLC (Drury Plaza Hotel Planning Commission July 26, 2010 Page 2 of 2

Planning Commission for alterations that present a material change. Please note, the Commission does not provide a recommendation to the City Council, but rather a list of issues generated during the hearing. City Council is the decision-making body for all requests for Telecommunications Siting Permits. A public hearing further addressing the request will be held at the July 26, 2010 City of Chesterfield Planning meeting. Attached please find a copy of the Public Hearing Notice and an application packet detailing the Petitioner's request.

Respectfully submitted,

Annissa McCaskill-Clay, AICP

Annissa McCaskill-Clay

Lead Senior Planner

Cc: Michael G. Herring, City Administrator

Rob Heggie, City Attorney

Michael O. Geisel, Director of Planning and Public Works Aimee Nassif, Planning and Development Services Director




# NOTICE OF PUBLIC HEARING CITY OF CHESTERFIELD PLANNING COMMISSION

NOTICE IS HEREBY GIVEN that the Planning Commission of the City of Chesterfield will hold a Public Hearing on Monday, July 26, 2010 at 7:00 pm in the Council Chambers at the City Hall, 690 Chesterfield Parkway West, Chesterfield, Missouri 63017. Said hearing will be as follows:

T.S.P. 24-2010 Clearwire US LLC (Drury Plaza Hotel): A request to obtain approval for a Telecommunication Siting Permit for the purpose of adding an additional antenna canister and equipment on the roof of a "PC" Planned Commercial District-zoned tract of land located at 355 E. Chesterfield Center (18S230433)

#### **Description of Property**

LOTS 1 AND 2 OF DRURY PLAZA, A SUBDIVISION ACCORDING TO THE PLAT THEREOF RECORDED IN PLAT BOOK 352, PAGE 123 IN ST. LOUIS COUNTY, MISSOURI RECORDER'S OFFICE.

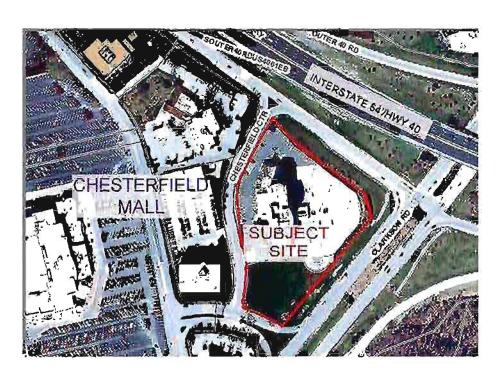

Information on this Public Hearing may be found on the City's website at http://www.chesterfield.mo.us/public-notice.html or by contacting Lead Senior Planner Annissa McCaskill-Clay at 636.537.4737 or via e-mail at amccaskill@chesterfield.mo.us. All interested parties will be given an opportunity to be heard at the Public Hearing.

# MO-STL0378 Coverage Analysis






Indoor Coverage without MO-STL0378





Indoor Coverage with MO-STL0378 (90ft)



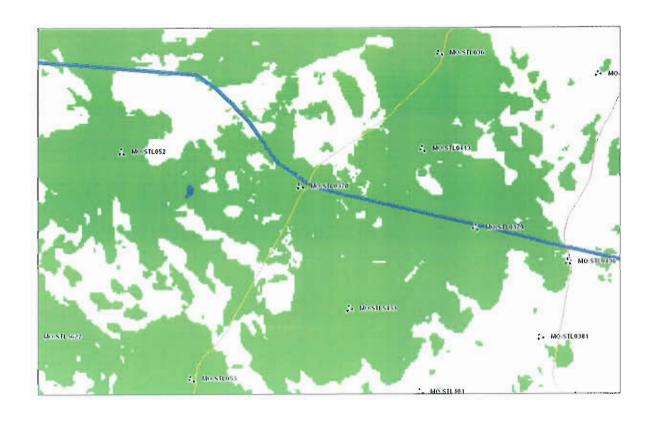

Indoor Coverage with MO-STL0378 (80ft)



Due to the 10' parapet wall at the long end of the building, 80' will not clear. Given the height of the wall, It will require the antennas to be ~10' higher to clear.







SITE ID: MO-STL0378

#### DRURY INN

#### DRAWING INDEX

T-1 TITLE SHEET S-1 PARCEL PLAN A-1 ROOF PLAN

A-1.3 BUILDING ELEVATION

A-1.5 **BUILDING ELEVATION PHOTOS** 

A-2 ANTENNA MOUNTING DETAILS & NOTES A-3 ANTENNA SHROUD SECTIONS & DETAILS A-3.1 ANTENNA SHROUD SECTIONS & DETAILS

A-3.3 ANTENNA SHROUD SECTIONS & DETAILS PIPE MAST CONNECTION DETAILS A-3.5

A-4 **EQUIPMENT DETAILS** 

A-5 RF/MW CONFIG E-1 ELECTRICAL PLAN

E-2 **GROUNDING PLAN** 

E-3 **ELECTRICAL DETAILS** 

E-4 **GROUNDING DETAILS & NOTES** E-5 GROUNDING ANTENNA DETAILS

#### CODE COMPLIANCE

ALL WORK AND MATERIALS SHALL BE PERFORMED AND INSTALLED IN ACCORDANCE WITH THE CURRENT EDITIONS OF THE FOLLOWING CODES AS ADDITIONS OF THE LOCAL GOVERNING AUTHORISES. NOTHING IN THESE PLAYS IS TO SE CONSTRUED TO PERMIT WORK NOT CONFORMING TO THE LATEST EDITIONS OF THE FOLLOWING CODES.

2. IMC 2003

6 LOCAL BUILDING CODE 7. CITY/COUNTY ORDINANCES

9 INTERNATIONAL EXISTING BUILDING CODE 2003

#### SITE QUALIFICATION PARTICIPANTS

NAME COMPANY MATTHEW MOKANYK, P.E.

NUMBER LANDTECH 231-943-0050

RUSSELL BEEN CELLECTIVE SOLUTIONS, LLC CLEARWIRE JASON GIBBS

amy.isenburg@clearwire.com AMY ISENBURG CLEARWIRE LANDLORD VINCE MILLER

DRURY PLAZA CHESTERFIELD LLP 314-423-6698


#### CIVIL ENGINEER

LANDTECH PROFESSIONAL SURVEYING AND ENGINEERING 1275 McGREGOR WAY GRAWN, MI 49637 P.O. BOX 193 PHONE: (231) 943-0050

#### SURVEYOR

LANDTECH PROFESSIONAL SURVEYING AND ENGINEERING 1275 McGREGOR WAY GRAWN, MI 49637 P.O. BOX 193 PHONE: (231) 943-0050

## DIRECTIONS TO SITE: FROM ST. LOUIS LAMBERT AIRPORT: TAKE HWY 70 WEST TO 270 SOUTH. FOLLOW TO HWY 40 WEST TO OLIVE BLVD, MAKE A LEFT WHERE ROAD CHANGES TO CLARKSON AND THE DRURY INN IS ON YOUR LEFT.

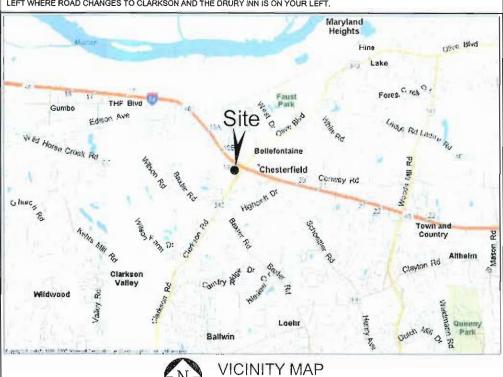

#### PROJECT INFORMATION

THIS FACILITY IS AN UNOCCUPIED TELECOMMUNICATIONS FACILITY CONSISTING OF CO-LOCATING ON AN EXISTING BUILDING WITH ANTENNAS HIDDEN IN A STEALTH CANISTER AND THE INSTALLATION OF NEW EQUIPMENT ON ROOFTOP.

355 E. CHESTERFIELD CENTER CHESTERFIELD, MO 63017

#### BUILDING OWNER:

DRURY PLAZA CHESTERFIELD LLP 721 EMERSON ROAD SUITE 200 ST. LOUIS, MO 63141

BUILDING NAME: DRURY INN

APPLICANT:

CLEARWIRE 4400 CARILLION POINT KIRKLAND, WA 98033 (425) 216-7600 PH (425) 216-7900 FAX

#### CONTACT:

AMY ISENBURG

MISSOURI

#### BUILDING INFORMATION:

(LATITUDE & LONGITUDE BASED ON NAD1983) LATITUDE: 38° 39' 08.3" N

LONGITUDE: 90° 33' 38.7" W

PROPOSED RAD CENTER HEIGHT: ±125' AGL

#### PARCEL NUMBER (TAX I.D.):

18S230433

CURRENT ZONING: PC COMMERCIAL

PROJECT TYPE: EXISTING TEN STORY HOTEL BUILDING





314-989-9810

4400 CARILLION POINT KIRKLAND, WA 98033 (425) 216-7600 PH

SITE ID: MO-STL0378

#### DRURY INN

NOT TO SCALE

355 E. CHESTERFIELD CENTER CHESTERFIELD, MO 63017

L						SHEET T-1
3	05/08/10	MOVE EQUIPMENT PLATFORM	DAM	ММ	ММ	STILLT 1-1
2	04/22/10	BLDG ELEVATION & PARCEL PLAN PER COMMENTS	DAM	ММ	мм	
1	03/08/10	ADD PENTHOUSE INTERIOR HVAC COMPONENTS	DAM	MM	ММ	TITLE SHEET
0	02/19/10	PRELIMINARY DRAWINGS	DAN MM MM		MM	
МО	. DATE	REVISIONS	BY	CHK	APP'D	DRAWING NUMBER
S	SCALE: AS SHOWN DESIGNED BY: MM					0938526

ΑÆ

SAC

RF

CON

355 E. CHESTERFIELD CENTER CHESTERFIELD, MO 63017

#### LAND OWNER:

DRURY PŁAZA CHESTERFIELD LLP 721 EMERSON ROAD SUITE 200 ST. LOUIS, MO 63141

#### **ZONING:**

SUBJECT SITE: PC COMMERCIAL NORTH OF SITE: C8 COMMERCIAL SOUTH OF SITE: C8 COMMERCIAL EAST OF SITE: C8 COMMERCIAL WEST OF SITE: C8 COMMERCIAL

#### **SETBACKS:**

FRONT SETBACKS: N/A SIDE SETBACKS: N/A REAR SETBACKS: N/A


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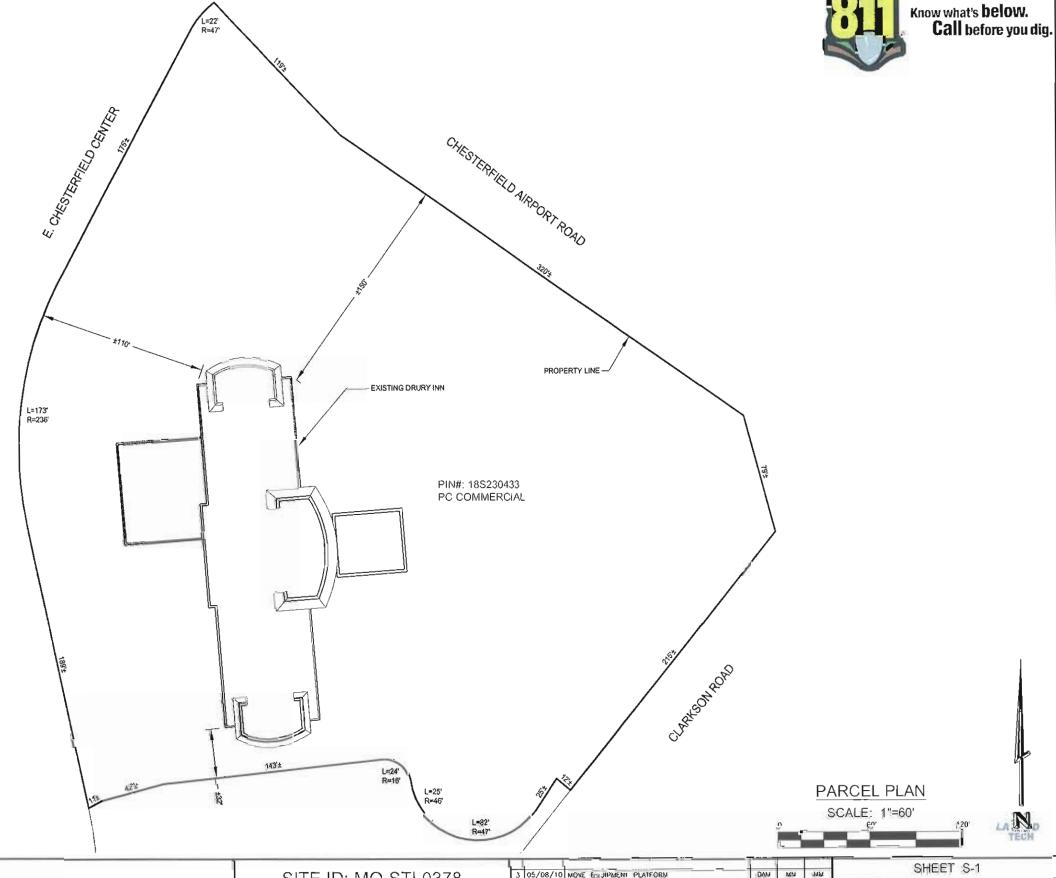
PARENT PARCEL AREA: 3.82 ACRES LEASE AREA: 49 SQ.FT.

AREA OF CONSTRUCTION: N/A (on rooftop)

#### PARENT PARCEL LEGAL DESCRIPTION

DESCRIPTION PER DEED IN PLAT BOOK 17932, PAGE 1145: LOTS 1 AND 2 OF DRURY PLAZA, A SUBDIVISION ACCORDING TO THE PLAT THEREOF RECORDED IN PLAT BOOK 352, PAGE 123 IN ST. LOUIS COUNTY, MISSOURI RECORDERS OFFICE.



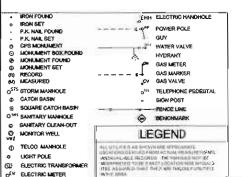






4400 CARILLION POINT KIRKLAND, WA 98033 (425) 216-7600 PH (425) 216-7900 FAX SITE ID: MO-STL0378

DRURTININ
355 E. CHESTERFIELD CENTER
CHESTERFIELD, MO 63017


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	04/22/10	BLDG ELEVATION & PARCEL PLAN PER COMMENTS	DAM	MN	MM	
	03/08/10	ADD PENTHOUSE INTERIOR HVAC COMPONENTS	DAM	MM	MM	PARCEL PLAN
٦	02/19/10	PRELIMINARY DRAWINGS	DAM	MM	MM	
١.	DATE	REVISIONS		CHK	APP'D	DRAWING NUMBER
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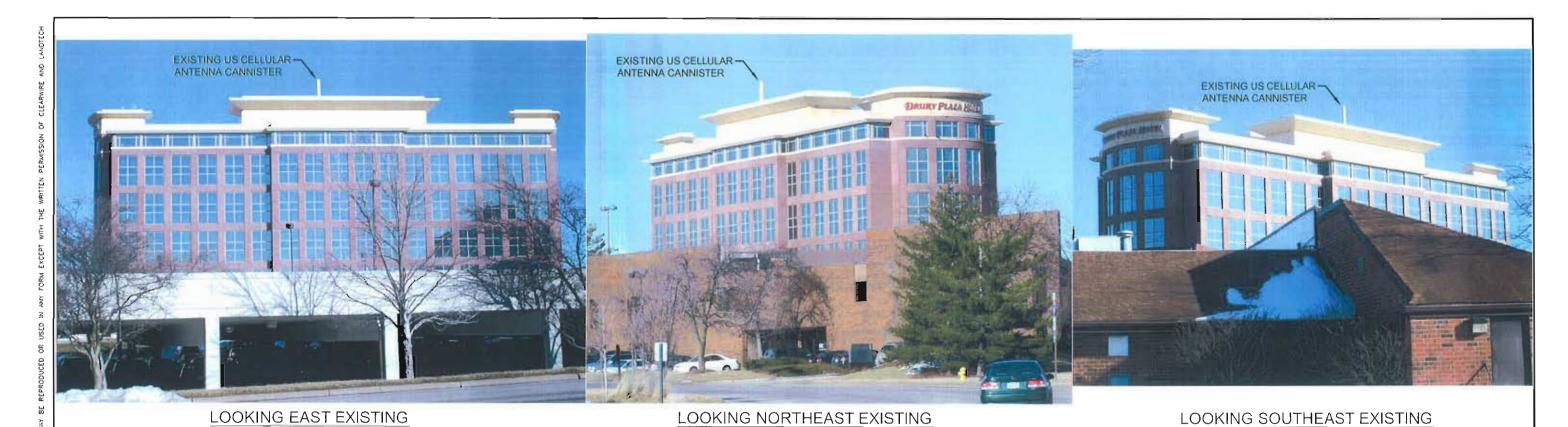




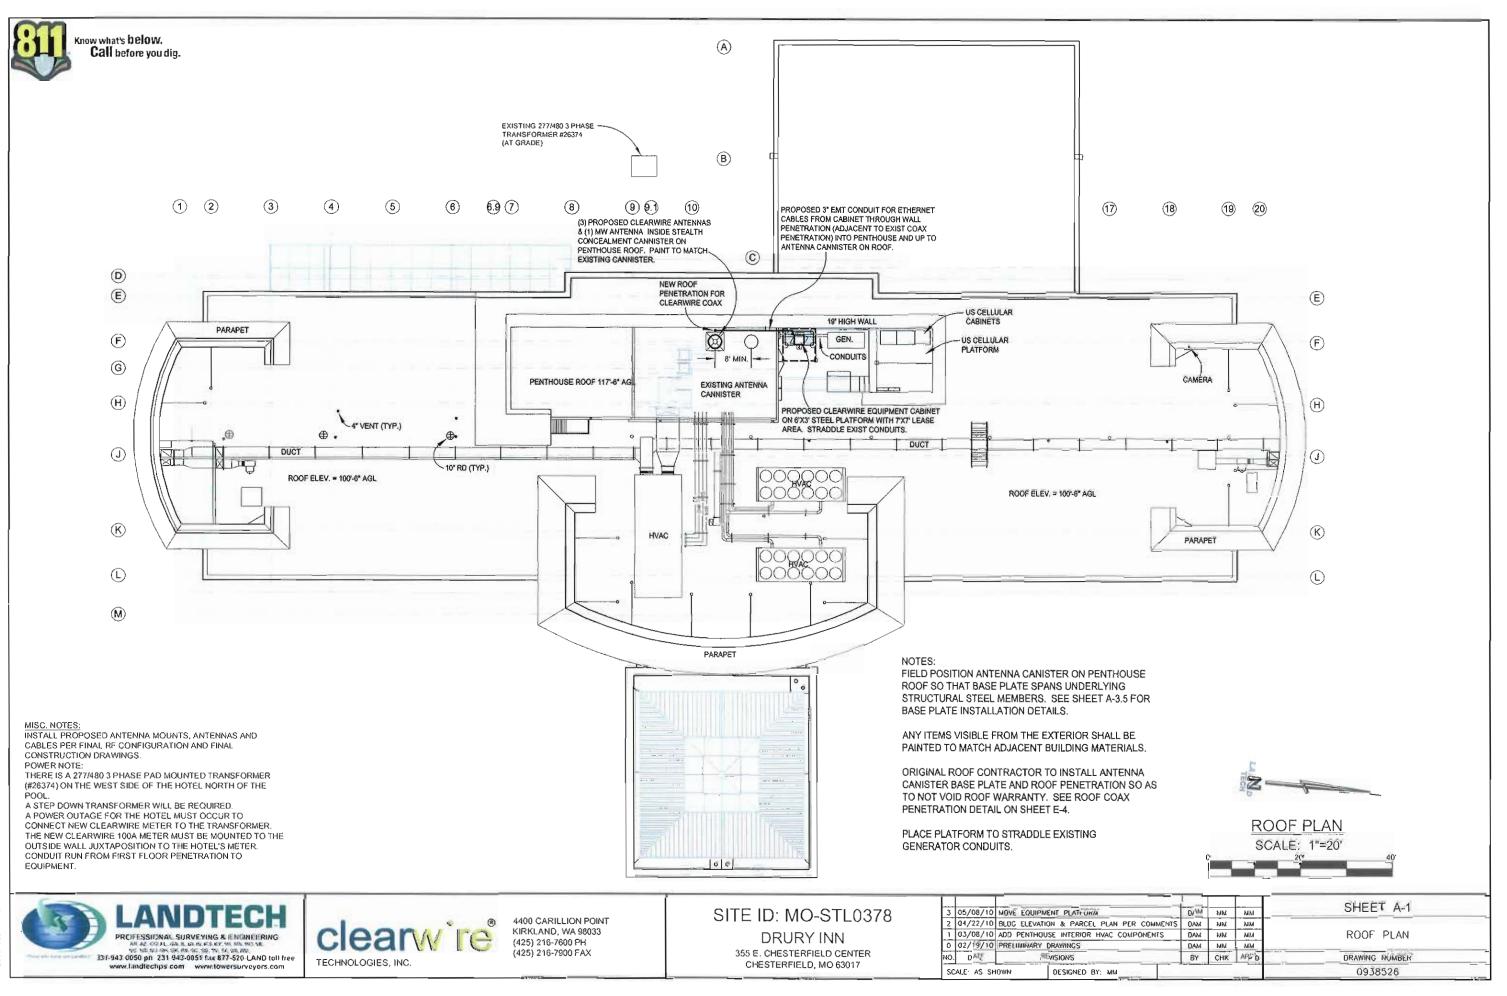

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LOOKING NORTHEAST PROPOSED

LOOKING SOUTHEAST PROPOSED

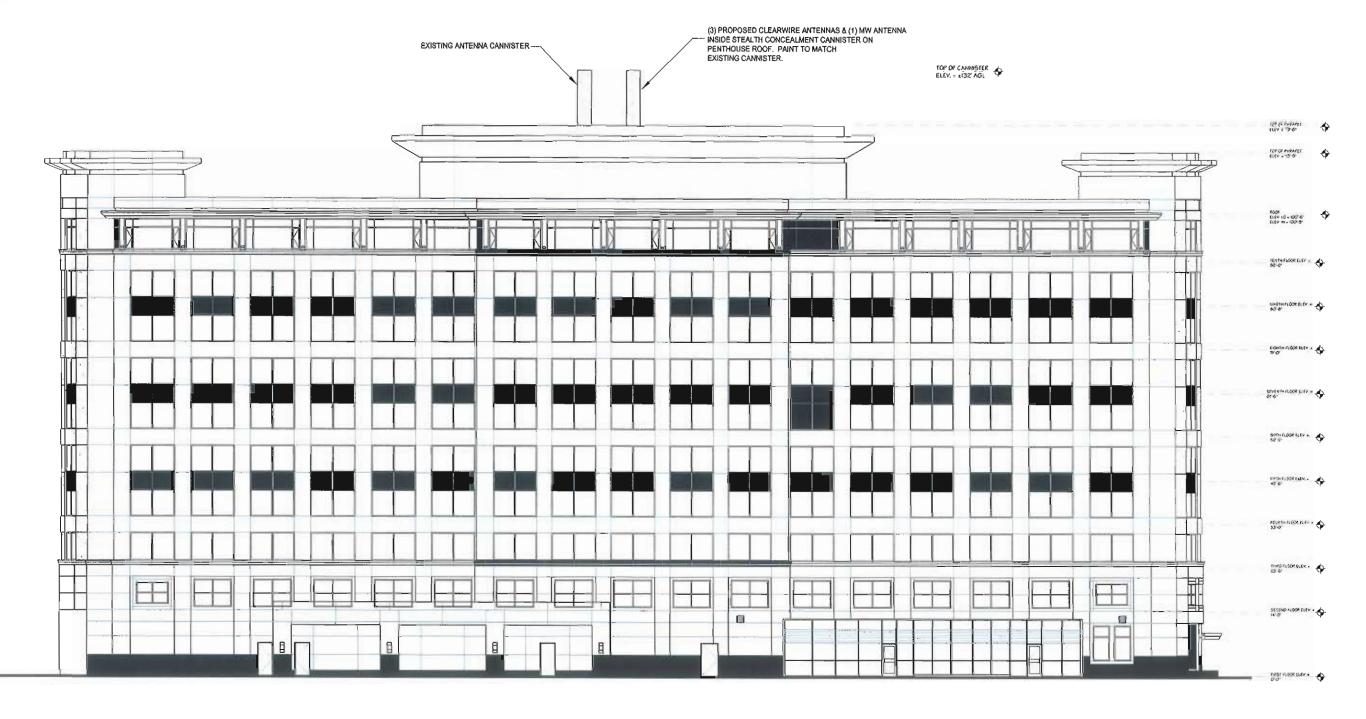




4400 CARILLION POINT KIRKLAND, WA 98033 (425) 216-7600 PH (425) 216-7900 FAX SITE ID: MO-STL0378 DRURY INN

355 E. CHESTERFIELD CENTER CHESTERFIELD, MO 63017


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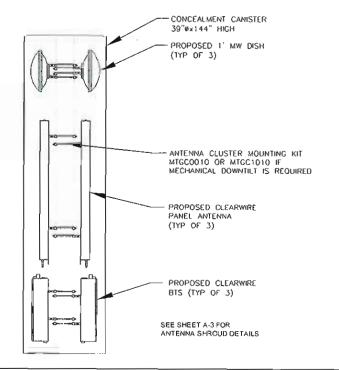


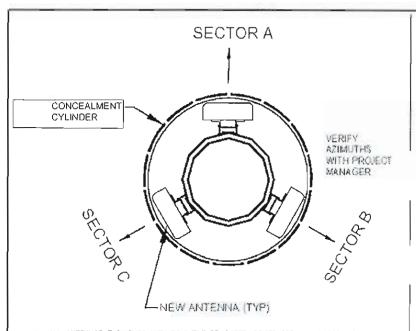- ALL ANTENNAS FURNISHED WITH DOWNTILT BRACKETS. CONTRACTOR TO COORDINATE REQUIRED MECHANICAL DOWNTILT FOR EACH ANTENNA WITH RF ENGINEER.
- 2. ANTENNA CENTERLINE HEIGHT IS IN REFERENCE TO ELEVATION 0'-0". ANTENNA HEIGHTS ARE SHOWN ON TOWER ELEVATION DETAIL 2/A-1.
- 3. CONTRACTOR SHALL VERIFY ANTENNA TYPE, CABLE TYPE, AND AZIMUTH WITH RF ENGINEER AND/OR CONSTRUCTION MANAGER PRIOR TO CONSTRUCTION.

BE

4. LOCAL MAGNETIC DECLINATION FACTOR, PER THE NATIONAL GEOPHYSICAL DATA CENTER, IS 50'W BY 07'W PER YEAR.




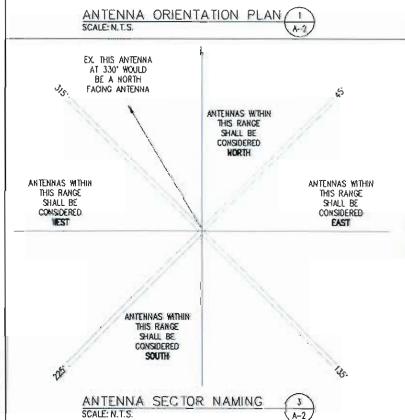


SECTOR	MARKING METHOD COLORED BANDS	MARKING METHOD NUMBER OF BANDS
NORTH	RED	1
EAST	8LVE	2
SOUTH	WHITE	3
WEST GREEN		4

LABEL MARKINGS SHALL BE PLACED WITHIN 12" OF THE CABLE AT BOTH ENDS, AT OR NEAR THE TOWER MGB AND EITHER PRIOR TO THE ENTRY INTO THE CONDUIT OR PRIOR TO ENTRY INTO THE CABINET. LABEL MARKING SHALL BE AT LEAST 1" WIDE BUT NOT MORE THAN 2" WIDE. FOR MULTIPLE BAND MARKING, BANDS SHALL BE SEPERATED BY AT LEAST 1" BUT NOT

ETHERNET CABLES SHALL BE ATTACHED TO TOWER WAVEGUIDE LADDER USING UV-RESISTANT BLACK CABLE TIES WITH 40LB MINIMUM BREAKING

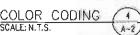

- 1. FACILITY IS UNNANNED AND NOT FOR HUMAN HABITATION (HANCICAPPED ACCESS NOT REQUIRED).
- 2. FACILITY HAS NO PLUMBING.
- J. FACILITY WILL BE INDEPENDENTLY POWERED WITH SEPERATE WETER.
- 4. ANTENNA INSTALLATION SHALL BE CONDUCTED BY FIELD CREWS EXPERIENCED IN THE ASSEMBLY AND ERECTION OF RADIO ANTENNAS, TRANSMISSION LINES, AND SUPPORT STRUCTURES.
- 5. CONTRACT COMPANIES AND THEIR EMPLOYEES SHALL OBSERVE AND PRACTICE ALL O.S.H.A. SAFETY CUIDELINES WHILE PERFORMING SERVICE FOR CLEARWIRE TECHNOLOGIES, INC.
- 6. CONTRACTOR SHALL PERFORM A SAFETY INSPECTION PRIOR TO COMMENCING ALL WORK ACTIVITIES AT A CLEARWIRE TECHNOLOGIES, INC. LEASED OR DWINED SITE. CLEARWIRE TECHNOLOGIES, INC. SHOULD BE IMMEDIATELY NOTIFIED OF SAFETY HAZARD(S) FOUND DURING THE INSPECTION THAT COULD CAUSE DAMAGE TO PROPERTY. ALL WORK SHALL BE HALTED UNTIL SUCH TIME THE REPORTED SAFETY HAZARD IS CORRECTED. THE SAFETY HAZARD, IF POSSIBLE, SHOULD BE CORRECTED BY THE CONTRACTOR WHILE ON SITE. AFTER THE CONTRACTOR HAS NOTIFIED CLEARWIRE TECHNOLOGIES, INC. OF THE HAZARD AND HAS RECEIVED APPROVAL FROM CLEARWIRE TECHNOLOGIES, INC. TO PERFORM THE CORRECTION.
- 7. TOWER MODIFICATIONS, IF REQUIRED, ARE TO BE COMPLETED BEFORE THE INSTALLATION OF ANY EQUIPMENT.

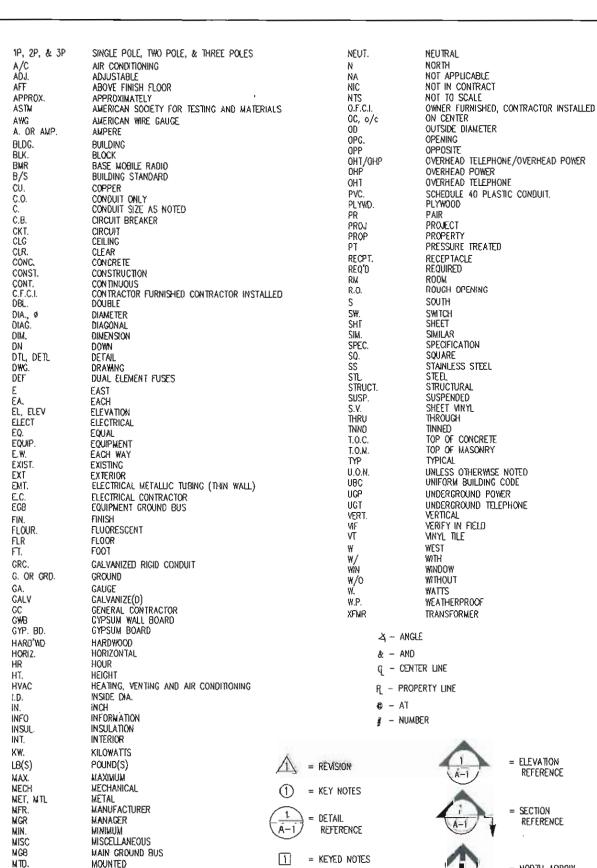





4400 CARILLION POINT KIRKLAND, WA 98033 (425) 216-7600 PH (425) 216-7900 FAX

SITE ID: MO-STL0378

DRURY INN 355 E. CHESTERFIELD CENTER CHESTERFIELD, MO 63017

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		BLOC ELEVATION & PARCEL PLAN PLAN COMMENTS		807	7232	PROPERTY OF THE STATE OF THE STATE OF
1	03/08/10	ADD PENTHOUSE INTERIOR HVAC COMPONENTS	DAM	MK	MM	ANTENNA MOUNTING DETAILS & NOTES
0	02/19/10	PRELIMINARY DRAWINGS	DAM	MIN	1,45,6	
NO	DATE	REVISIONS	BY	CHK	APP'D	DRAWING NUMBER
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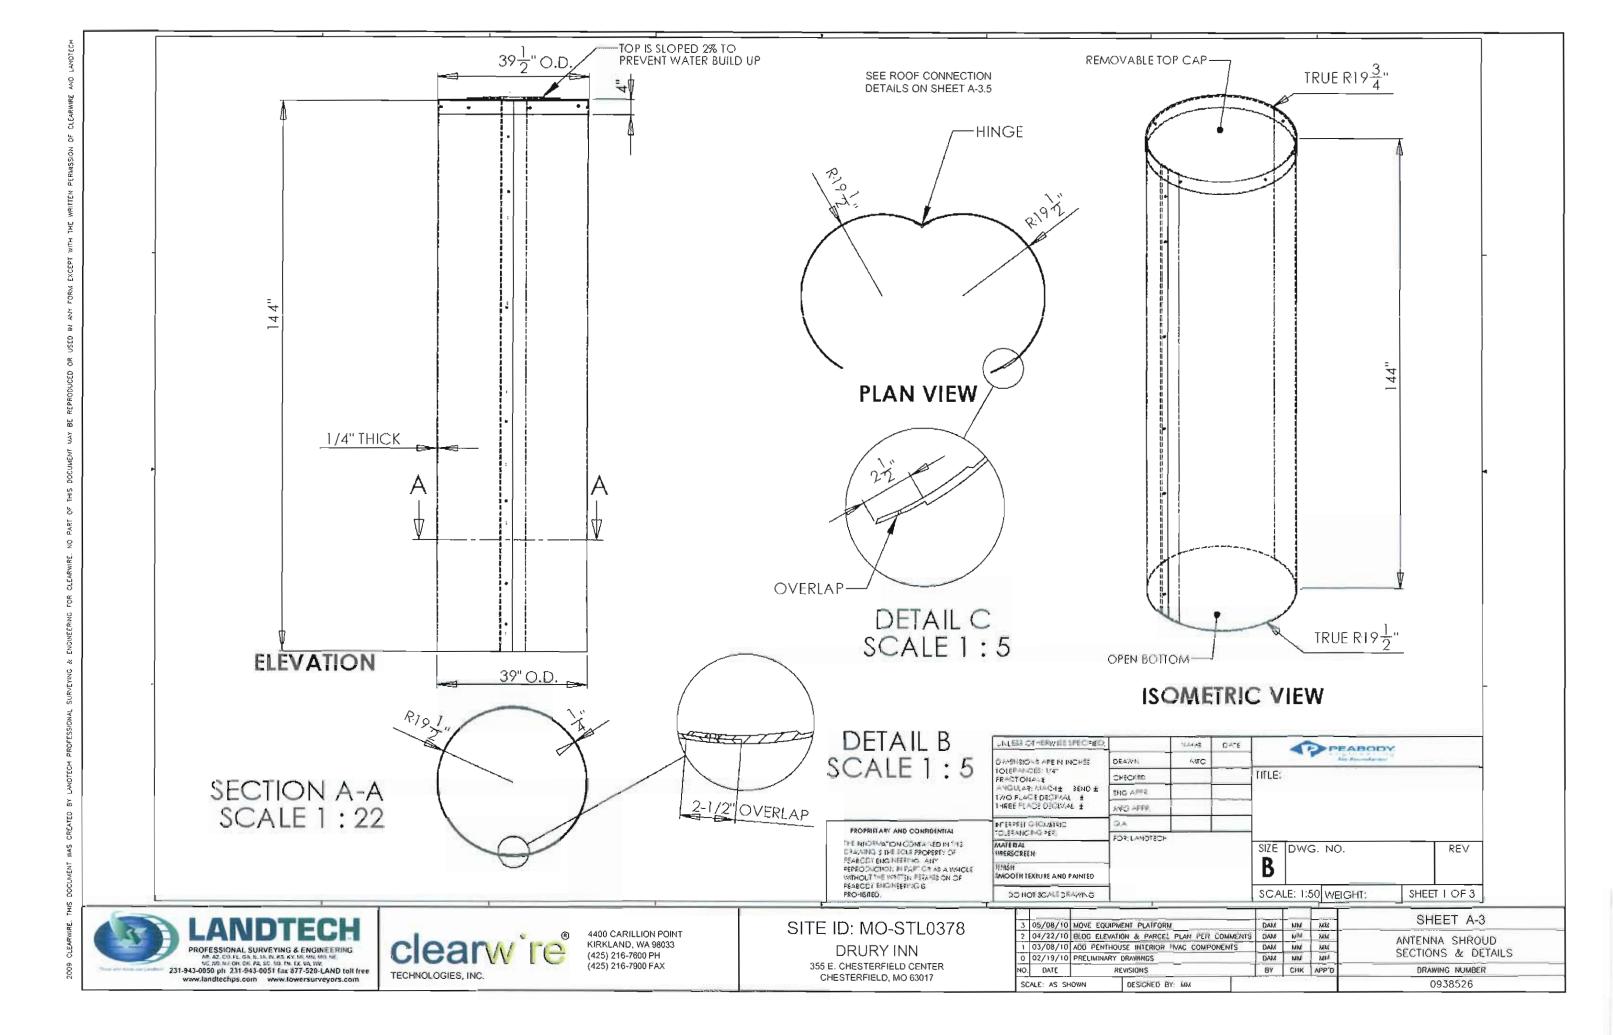
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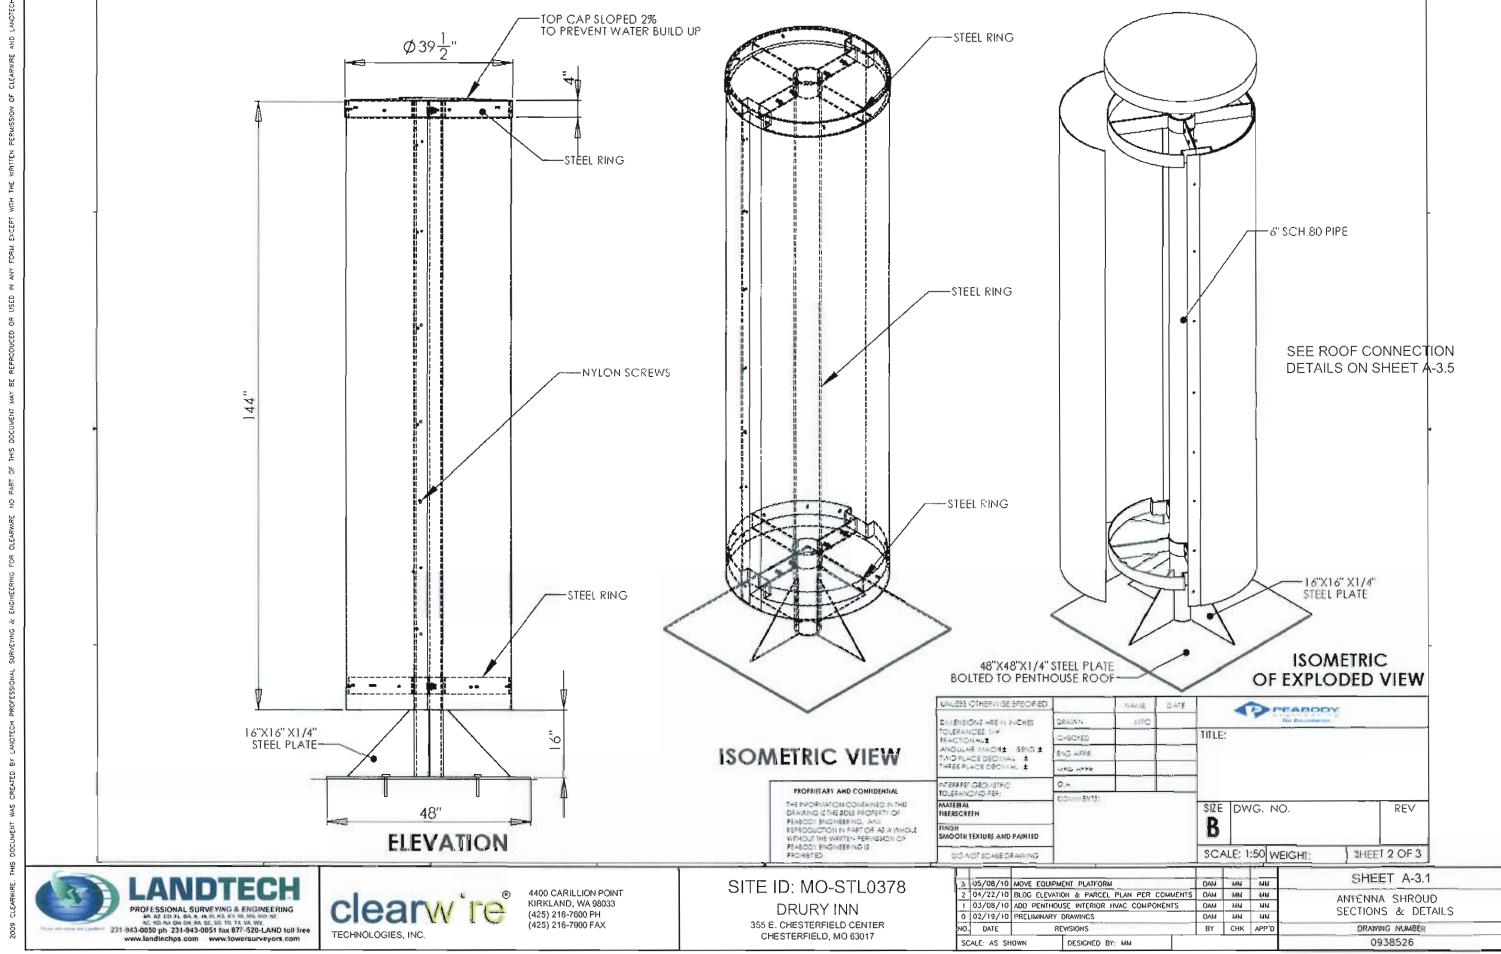
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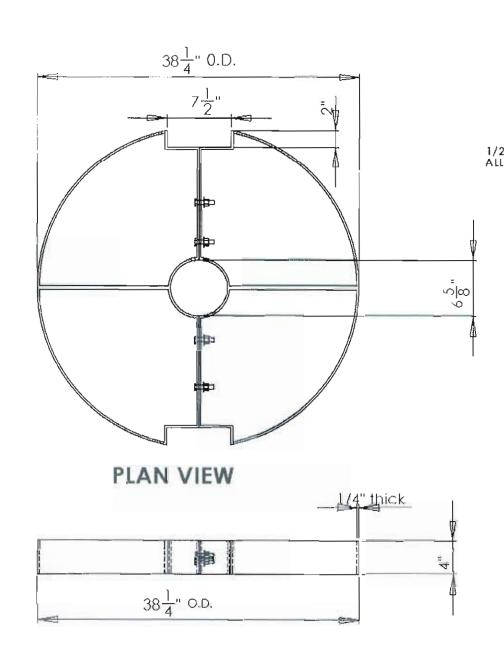
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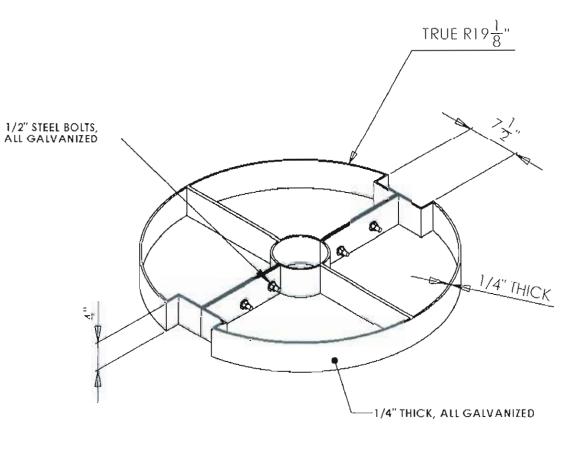
= NORTH ARROW

REFERENCE









### SOMETRIC VIEW

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**ELEVATION** 

4400 CARILLION POINT KIRKLAND, WA 98033 (425) 216-7600 PH (425) 216-7900 FAX


SITE ID: MO-STL0378

DRURY INN 355 E. CHESTERFIELD CENTER CHESTERFIELD, MO 63017

		The state of the s				SHEET A-3.3
3	05/08/10	MOVE EQUIPMENT PLATFORM	DAM	XARJ .	MM	SHEET A-3.3
2	04/22/10	BLOG ELEVATION & PARILL PLAN PER COMMENTS	DAM	MM	MM	ANTENNA SHROUD
1	03/08/10	ADD PENTHOUSE INTERIOR INVAC COMPUNENTS	DAM	MM	MX	
0	02/19/10	PRÉLIMINARY DRAWINGS	DAM	MM	MAX	SECTIONS & DETAILS
NO.	DATE	REVISIONS	BY	CHK	G'99A	DRAWING NUMBER
SC	ALE: AS SH	IOWN DESIGNED BY: MM				0938526
_			_			

#### **GENERAL NOTES:**

- THE BASIC WIND SPEED UTILIZED FOR OUTDOOR EQUIPMENT CABINETS IS 90 MPH PER IBC (LATEST EDITION.)
- INFORMATION SHOWN ON THESE DRAWINGS WAS OBTAINED BY FIELD MEASUREMENTS. THE GENERAL CONTRACTOR SHALL VERIFY ALL EXISTING CONDITIONS AND NOTIFY THE ENGINEER OF ANY DISCREPANCIES PRIOR TO ORDERING MATERIALS OR PROCEEDING WITH CONSTRUCTION.
- THE GENERAL CONTRACTOR AND HIS SUBCONSULTANTS SHALL BE RESPONSIBLE FOR OBTAINING ALL PERMITS AND INSPECTIONS WHICH MAY BE REQUIRED FOR THE
- STRUCTURAL STEEL SHALL CONFORM TO THE LATEST EDITION OF THE AISC SPECIFICATIONS FOR STRUCTURAL STEEL BUILDINGS. ALLOWABLE STRESS DESIGN AND PLASTIC DESIGN INCLUDING THE COMMENTARY AND THE AISC CODE OF STANDARD PRACTICE
- STRUCTURAL STEEL PLATES AND SHAPES SHALL CONFORM TO ASTM A36, ALL STRUCTURAL STEEL PIPES SHALL CONFORM TO ASTM A53 GRADE B. ALL STRUCTURAL STEEL TUBING SHALL CONFORM TO ASTM A500 GRADE B. ALL STRUCTURAL STEEL CONPONENTS AND FABRICATED ASSEMBLIES SHALL BE HOT DIP GALVANIZED AFTER FABRICATION.
- ALL THREADED STRUCTURAL FASTENERS FOR ANTENNA SUPPORT ASSEMBLIES SHALL CONFORM TO ASTM A307OR ASTM A36. ALL STRUCTURAL FASTENERS FOR STRUCTURAL STEEL FRAMING SHALL CONFORM TO ASTM A325. FASTENERS SHALL BE 5/8" MIN. DIAMETER BEARING TYPE CONNECTIONS WITH THREADS EXCLUDED IN THE SHEAR PLANE. ALL EXPOSED FASTENERS, NUTS, AND WASHERS SHALL BE GALVANIZED UNLESS NOTED OTHERWISE CONCRETE EXPANSION ANCHORS SHALL BE HILTI KWIK BOLTS UNLESS NOTED OTHERWISE. ALL ANCHORS INTO CONCRETE SHALL BE STAINLESS STEEL
- ALL COAX CABLE CONNECTORS AND TRANSMITTER EQUIPMENT SHALL BE AS SPECIFIED BY THE OWNER AND IS NOT INCLUDED IN THESE CONSTRUCTION DOCUMENTS. THE CONTRACTOR SHALL FURNISH ALL CONNECTION HARDWARE REQUIRED TO SECURE THE CABLES. FOR GUYED AND SELF SUPPORT TOWERS, THE ETHERNET CABLES SHALL BE ATTACHED TO 2" FLEX CONDUIT TO THE TOWER WAVEGUIDE LADDER USING STAINLESS STEEL HARDWARE. ZIP TIES ARE NOT PERMITTED UNDER ANY CIRCUMSTANCE. FOR MONOPOLE TOWERS, THE ETHERNET CABLES SHALL BE ROUTED INSIDE THE TOWER (OR AS PER STRUCTURAL REPORT) AND WITHIN (1) 2" INNERDUCT CONDUIT.
- NORTH ARROW ON PLANS REFERS TO TRUE NORTH, CONTRACTOR SHALL VERIFY NORTH AND INFORM ENGINEER ANY DISCREPANCY BEFORE STARTING CONSTRUCTION.
- ALL REINFORCING STEEL SHALL CONFORM TO ASTM 615 GRADE 60, DEFORMED BILLET STEEL BARS.
- 10. LUMBER SHALL COMPLY WITH THE REQUIREMENTS OF AMERICAN INSTITUTE OF TIMBER CONSTRUCTION AND THE NATIONAL FOREST PRODUCTS ASSOCIATION'S NATIONAL DESIGN SPECIFICATION FOR WOOD CONSTRUCTION, ALL LUMBER SHALL BE PRESSURE TREATED AND SHALL BE STRUCTURED GRADE No. 2 OR BETTER.
- 11. IT IS THE RESPONSIBILITY TO VERIFY THE STRUCTURAL CAPACITY OF THE EXISTING TOWER AND ITS FOUNDATION TO RESIST THE WIND/GRAVITY LOADS FROM THE PROPOSED ANTENNAS.
- ALL FIELD CUT METAL WILL BE SCRAPED OF ANY RUST AND COLD GALVANIZED.
   RUBBER CAPS WILL BE PLACED ON ALL EXPOSED UNISTRUT ENDS.
- EXISTING PENTHOUSE ROOF IS ASSMUED METAL AND IN GOOD CONDITION. IF DURING CONSTRUCTION, THE EXISTING ROOF IS FOUND TO BE IN QUESTIONABLE OR DETERIORATED CONDITION, THE ENGINEER MUST BE CONTACTED.
- 15 ALL WELDING SHALL BE DONE USING E70XX ELECTRODES AND WELDING SHALL CONFORM TO AISC AND AWG D1.1. WHERE FILLET WELD SIZES ARE NOT SHOWN, PROVIDE THE MINIMUM SIZE PER TABLE J2.4 IN THE AISC "MANUAL OF STEEL CONSTRUCTION," 9TH EDITION. AT THE COMPLETION OF WELDING, ALL DAMAGE TO GALVANIZED COATING SHALL BE REPAIRED USING COLD GALVANIZER.

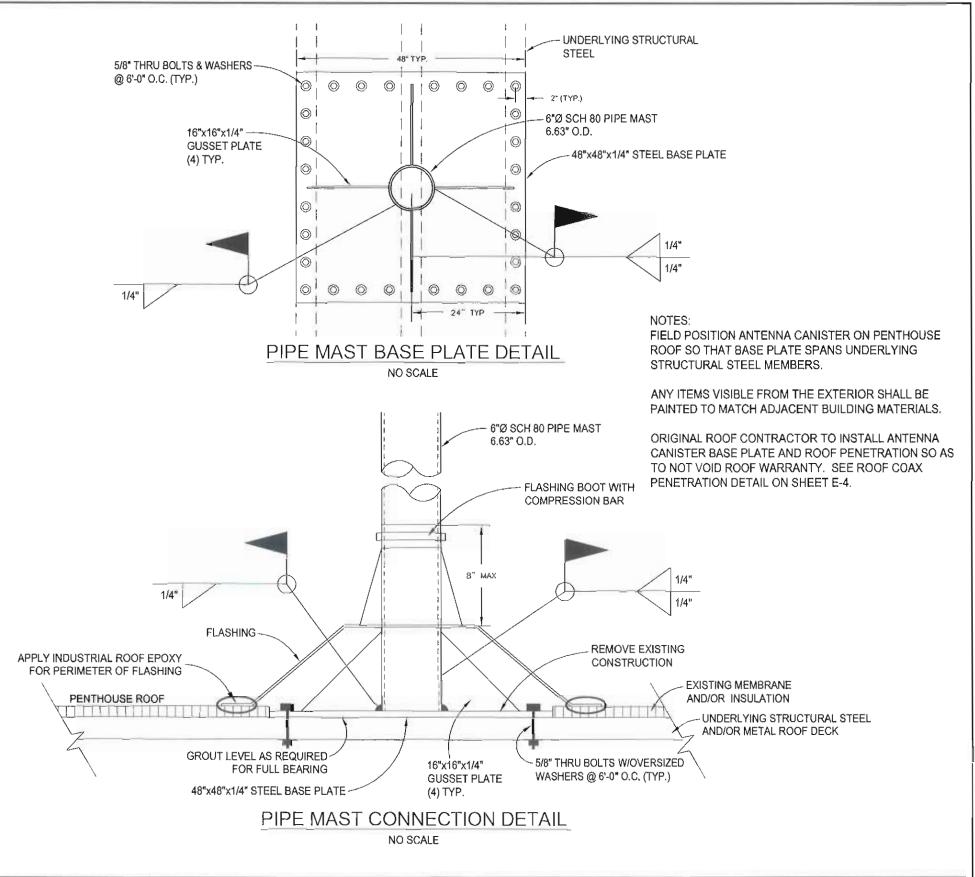






4400 CARILLION POINT KIRKLAND, WA 98033 (425) 216-7600 PH (425) 216-7900 FAX

SITE ID: MO-STL0378

DRURY INN 355 E. CHESTERFIELD CENTER CHESTERFIELD, MO 63017


3	05/08/10	MOVE EQUIPMENT PLATFCOM	DAM	MM	MM	SHEET A-3.5
2	04/22/10	BLDG ELEVATION & PARCEL PLAN PER COMMENTS	DAM	мм	мм	PIPE MAST
ì,	03/08/10	AOD PENTHOUSE INTERIOR HVAC COMPONENTS	DAM	мм	MM	
0	02/19/10	PRELIMINARY DRAWINGS	DAM	ММ	MM	CONNECTION DETAILS
Ю.	DATE	FICVISIONS	8Y	CHK	U,deV	DRAWING NUMBER
SC	NE AS SH	OWN DESIGNED BY: MM				0938526

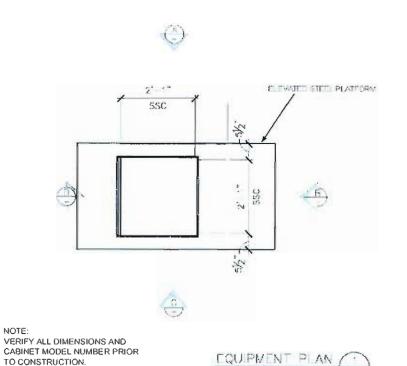

SCALE: 3/8"=1"-0"


SPECIFIC EQUIPMENT CABINET MODEL TO BE DETERMINED.




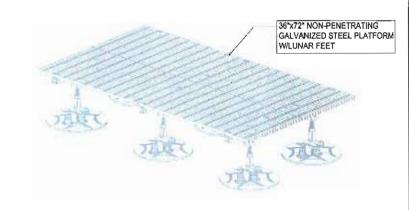



36"x72" PLATFORM DETAIL SCALE: N.T.S.

## **CABINET PHOTOS**

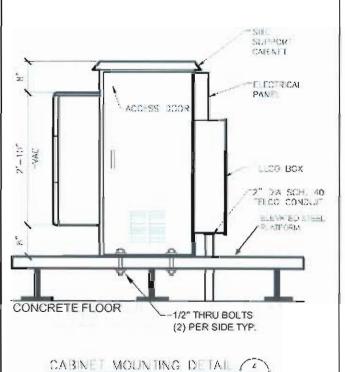

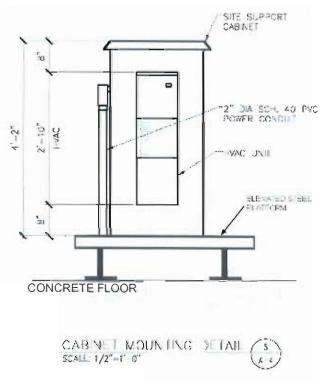

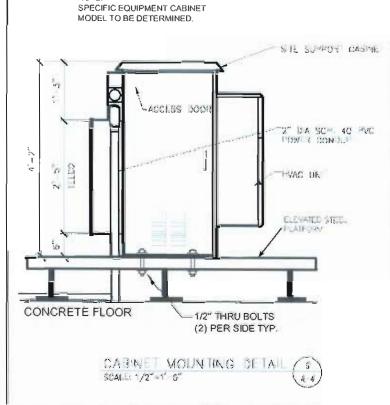

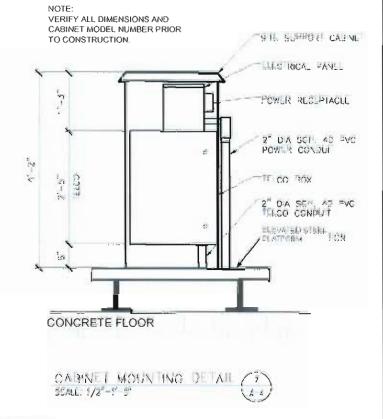



SCALE: 1/2"-1"-0"



4400 CARILLION POINT KIRKLAND, WA 98033 (425) 216-7600 PH (425) 216-7900 FAX

SITE ID: MO-STL0378

DRURY INN

355 E. CHESTERFIELD CENTER CHESTERFIELD, MO 63017

-				-122		And Learning V. A.
3	05/08/10	MOVE EQUIPMENT PLATFORM	DAW	MM	MM	SHEET A-4
2	04/22/10	BLOG ELEVATION & PARCEL PLAN PER COMMENTS	DAM	KILL	MM	
1	03/08/10	ADD PENTHOUSE INTERIOR HVAC COMPONENTS	DAM	ММ	MM	EQUIPMENT DETAILS
0	02/19/10 PRELIMINARY DRAWINGS		DAM	MN	мм	
NO.	DATE	REVISIONS	8Y	CHK	APP'D	DRAWING NUMBER
sc	ALE: AS SH	OWN DESIGNED BY: MM				0938526

C: Special Access  Will need to setup an appointment before visiting the building  C: Special Access  Will need to setup an appointment before visiting the building  C: After Hours Access  C: After Hours Access  C: Gate Combination  C: Cabinet Combination  C: Cabinet Combination  C: Generator Access  T: (F) C  T: (	Identification C: Candidate ID C: Candidate Rank C: Candidate Status Access	Mkt: Market Name St Louis, MO Clus: Cluster St Louis Clus: Cluster CMA 11	Location C: Address C: City C: ZIP Chesterfield 63017	C: Jurisdictic C: County C: State	Chesterfiled St Louis County	C: Latitude 38 652 656 C: Longitude -90.561	Project Prj: Pro Prj: Pro Workpl:
C: Afer Hours Access C: Gale Combination C: Cabinet Combination C: C				rd, make a left where road ch	anges Clarkson and the Drury In	in is on your left.	Key Tas T: (F) Si T: (F) Zc T: (F) Zc T: (F) Cc T: (F) Cc T: (F) Si T: (F) Cc
Site Designation Site Designation New Size Eurid Size Equipment Type OAP C. Copil Request Activation? C. Custant Fraction Copy Size Size Equipment Manufacture Size Equipment Manufa							
S. Sire Designation S. Current Technology S. RF Sire Type S. Current Technology S. RF Sire Type S. POP Sity Type S. POP Sity Type S. POP Sity Type S. POP Sity Type Contact Information C. Access Contact Number LA: Landford Contact Number LA: Landford Contact Number LA: Landford Contact Number LA: Landford Contact Number C. MLA Site ID C. MLA Site ID C. MLA Site ID C. MLA Contact Name C. Power Company C. MLA Contact Phone C. MLA Contact Phone C. Power Company Contact II S. Equipment Type S. Field Tech Dispersion S. Field Tech S. F		C: Cabinet Com		erator Access	Part Carlotte		
S. RF Sile Type S. PI Sile Typ							
S: PDP Sty Type   Sp	S: Current Techonology	WilMax S: Equipment Manufactu	rine C: Dig	i Request Activation?			
Canal Information   NOC Phone #: 866.316-7575   Nec@elearwire.com   Canal Contact Name   Ca	S: BH Site Type	Spur Site S: Equipment Location	G: Dig				
C. Access Contact Number LA: Landlord Contact Number LA: L	Contact Information	NOC Phone #: 866-316-7575	noc@clearwire.com			and the second second	
LA: Landlord Contact Name	C: Access Contact Name	Vince Miller C: Property Owner		Access/NOC Number		S: Field Tech	9
LA: Landlord Contact Number  C: MLA Owner (1st lease) C: MLA Contact Name C: Power Company				∞ carrier	ATAT		
C: MLA Site ID C: MLA Contact Name C: MLA Contact Name C: MLA Contact Name C: MLA Contact Phone C: MLA Contact Phone C: MLA Contact Phone C: MLA Contact Phone C: Power Company C: Manuelli Phone C: Power Company C: Power Company C: Power Company C: Manuelli Phone C: Power Company C: Manuelli Phone C: Power Company C: Manuelli Phone C: Power Company C: Manuelli Phone C: Power Company C: Power Company C: Chan: Channel Number Frequency Chan: Chan: Channel Number Frequency Chan: Chan: Channel Number Frequency Chan: Chan: C	LA: Landlord Contact Number	IC: Outage Contact 1	C: Teld	co Company Contact#		S: Ops Manager Phone	
C: MLA Contact Phone RF Information    RF: Sector   RF: RF: RAD   RF: Sector   Sector   Status   Cthange   RF: Available   Sector   Status   Status	C: MLA Site ID	IC: Outage Contact 8	C: Fibe	er Company Contact#		S: Project Manager Phone	
RF: Bector   RF: Sector   RF: RAD   RF: Sector   RF: RF: Mach   RF: Sector   RF: RF: Mach   RF: Antenna Make/Model   ID   Chan: Channel Number   Frequency   Installed   Quantity   Channels   Width   RF: To   Channel Number   RF: Ret   RF: Ret   Available   Sector   Channels   Channels   RF: Ret   RF: Ret   Available   Sector   RF: Ret   RF: Ret   Available   Sector   Channels   RF: Ret   RF: Ret   RF: Ret   Available   Sector   RF: Ret   RF: Ret   RF: Ret   RF: Ret   Available   Sector   RF: Ret					Mike Grandcolas	,	
RF: Sector	RF Information	RE RE RAD RE RE		Chan		DC: DC:	
MO-STL0378a-23991 A1 Build 90 345 0 0 LLPX310R65deg XX-pol Argus 1 2499000 1.3 65 WMAX MO-STL0378a-24150 B1 Build 90 120 -7 0 LLPX310R65deg XX-pol Argus 3 2510250 1.3 86 WMAX MO-STL0378a-24309 C1 Build 90 240 -1 0 LLPX310R65deg XX-pol Argus 2 2504750 1.3 66 WMAX MW Interconnect Information    Cand Backhaul Site   Link ID   Status   Link Type   Distance   Capacity   Capacity   Vendor   Model   Type   Band   AGL   Azimith   Antenna Model   Antenna Size   Config   Sub Band   TX Type   (dBm)   STL052   a Access Ring   0000047301   Build   MW-Unlicensed   1.767 108   Redline   AN-801   Integrated   5.8 90 282 6856   Andrew FPA6150-16-1   6" (0.1524m)   RF/Modem   16   MO-STL0378   Sub Band   TX Type   TX Pow   Clearvision Site Data Report   Bate: 2010-2-18		Sector CtrAGL RF: Sector Elec. Mect	h.	Channel		Ret RF: Ret Available Sector	RE: Ye
MO-STL0378a-24309 C1 Build 90 240 -1 0 LLPX310R66deg XX-pol Argus 2 2504750 1-3 65 WMMA  MW Interconnect Information  Cand Backhaul Site Link ID Status Link Type Distance Capacity Capacity Vendor Model Type Band AGL Azimith Antenna Model Antenna Size Config Sub Band TX Type (dBm NO-STL052 a Access Ring 0000047301 Build MW-Dilicensed 1.767 108 Redline AN-801 Integrated 5.8 90 282 6856 Andrew FPA6150-16-1 6* (0.1624m) RF/Modem 16  MO-STL0378  MO-STL0378  MO-STL0378  MO-STL0378  MO-STL0378		Build 90 345 0 0	LLPX310R 65deg XX-pol Argus	1	2499000	1-3 65	AWW
Site ID   Cand   Backhaul Site   Link ID   Link ID   Link ID   Link ID   Link ID   Status   Link Type   Distance   Capacity   Capacity   Vendor   MW   Radio   Modem   Type   Band   AGL   Azimith   Antenna Model   Antenna Size   Config. Sub Band   TX Type   Capacity   Capacity   Capacity   Vendor   Type   Band   AGL   Azimith   Antenna Model   Antenna Size   Config. Sub Band   TX Type   Capacity   Capacity   Capacity   Capacity   Vendor   Type   Band   AGL   Azimith   Antenna Model   Antenna Size   Config. Sub Band   TX Type   Capacity   Capacity   Capacity   Capacity   Vendor   Type   Band   AGL   Azimith   Antenna Model   Antenna Size   Config. Sub Band   TX Type   Capacity   Capacity   Capacity   Capacity   Vendor   Type   Band   AGL   Azimith   Antenna Model   Antenna Size   Config. Sub Band   TX Type   Capacity   Capacity   Capacity   Capacity   Capacity   Vendor   Type   Band   AGL   Azimith   Antenna Model   Antenna Size   Config. Sub Band   TX Type   Capacity   Capacity   Capacity   Capacity   Capacity   Vendor   Type   Band   AGL   Azimith   Antenna Model   Antenna Size   Config. Sub Band   TX Type   Capacity   Capacity   Capacity   Capacity   Capacity   Vendor   Type   Band   AGL   Azimith   Antenna Model   Antenna Size   Config. Sub Band   TX Type   Capacity   Capacit	MO-STL0378a-24309 C1						
Site ID ID Type Link ID Status Link Type Distance Capacity Capacity Vendor Model Type Band AGL Azimith Antenna Model Antenna Size Config Sub Band TX Type (dBm MO-STL052 a Access Ring 0000047301 Build MW-Unlicensed 1.767 108 RedIme AN-801 Integrated 5.8 90 282 6856 Andrew FPA5150-16-1 6" (0.1524m) RFModem 16  Clearvision Site Data Report  Remort Date: 2010-2-18							
STL052 a Access Ring 0000047307 Build Unlicensed 1.767 108 Redline AN-801 Integrated 5.8 90 282 6866 Section 6" (0.1524m) RF/Modem 16  Clear vision Site Data Report Pate: 2010-2-18			to Configured MW noe Capacity Capacity Vendor				
Report Date: 2010-2-18			7 108 Redline	AN-80i Integrated 5.8	8 90 282 6856 Andrew FF		16
Report Date: 2010-2-18			MO-STL0378	}	52470		
	Report Date: 2010-2-18						

LANDTECH PROFESSIONAL SURVEYING & ENGINEERING 731-943-0050 ph 231-943-0051 fax 877-\$20-LAND toll free www.landichps.com www.towersurveyors.com



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SITE ID: MO-STL0378

DRURY INN 355 E. CHESTERFIELD CENTER CHESTERFIELD, MO 63017

	_						á
						SHEET A-5	
3	05/08/10	MOVE EQUIPMENT PLATFORM	DVM	MM	мм	SHEET A-0	
2	04/22/10	BLOG ELEVATION & PARCEL PLAN PER COMMENTS	DAM	YUY	жк	20020	
1	03/08/10	ADD PENTHOUSE INTERIOR HVAC COMPONENTS	DAM	MM	MM	RF/MW CONFIG	
0	02/19/10	PRELIMINARY DRAWINGS	DAM	ММ	им		
NO.	DATE	RÉVISIONS	8Y	ÇHK	APP'D	DRAWING NUMBER	
SC	ALE: AS SH	OWN DESIGNED BY: MM				0938526	
_							,

MO-STL\_Phase1

(For initial site builds only)

Jason Gibbs

Michael D Moore

Polarization

Quad

Quad

32

EIRP TX Freq 1 TX Freq 2

Quad

Gain (dBi)

17.7

17.7

17.7

03.31.2010

05.20.2010

06.10.2010

06.10.2010

07.09.2010

07.28.2010

06.24.2010

06.29.2010

Workplan Template S: WPT: New Site Build Large Market

Key Tasks (Forecast, Actual)
T: (F) Situature Lease Complete (050) Finish

T: (F) Zoning Approval Confirmed (M6) Finish


T: (F) Zoning Submitted (060) Finish


T; (F) Pull Building Permit (090) Finish


T: (F) Construction Complete (130) Finish

T: (F) Site Commissioning (140) Finish

T: (F) Construction Start (100) Finish

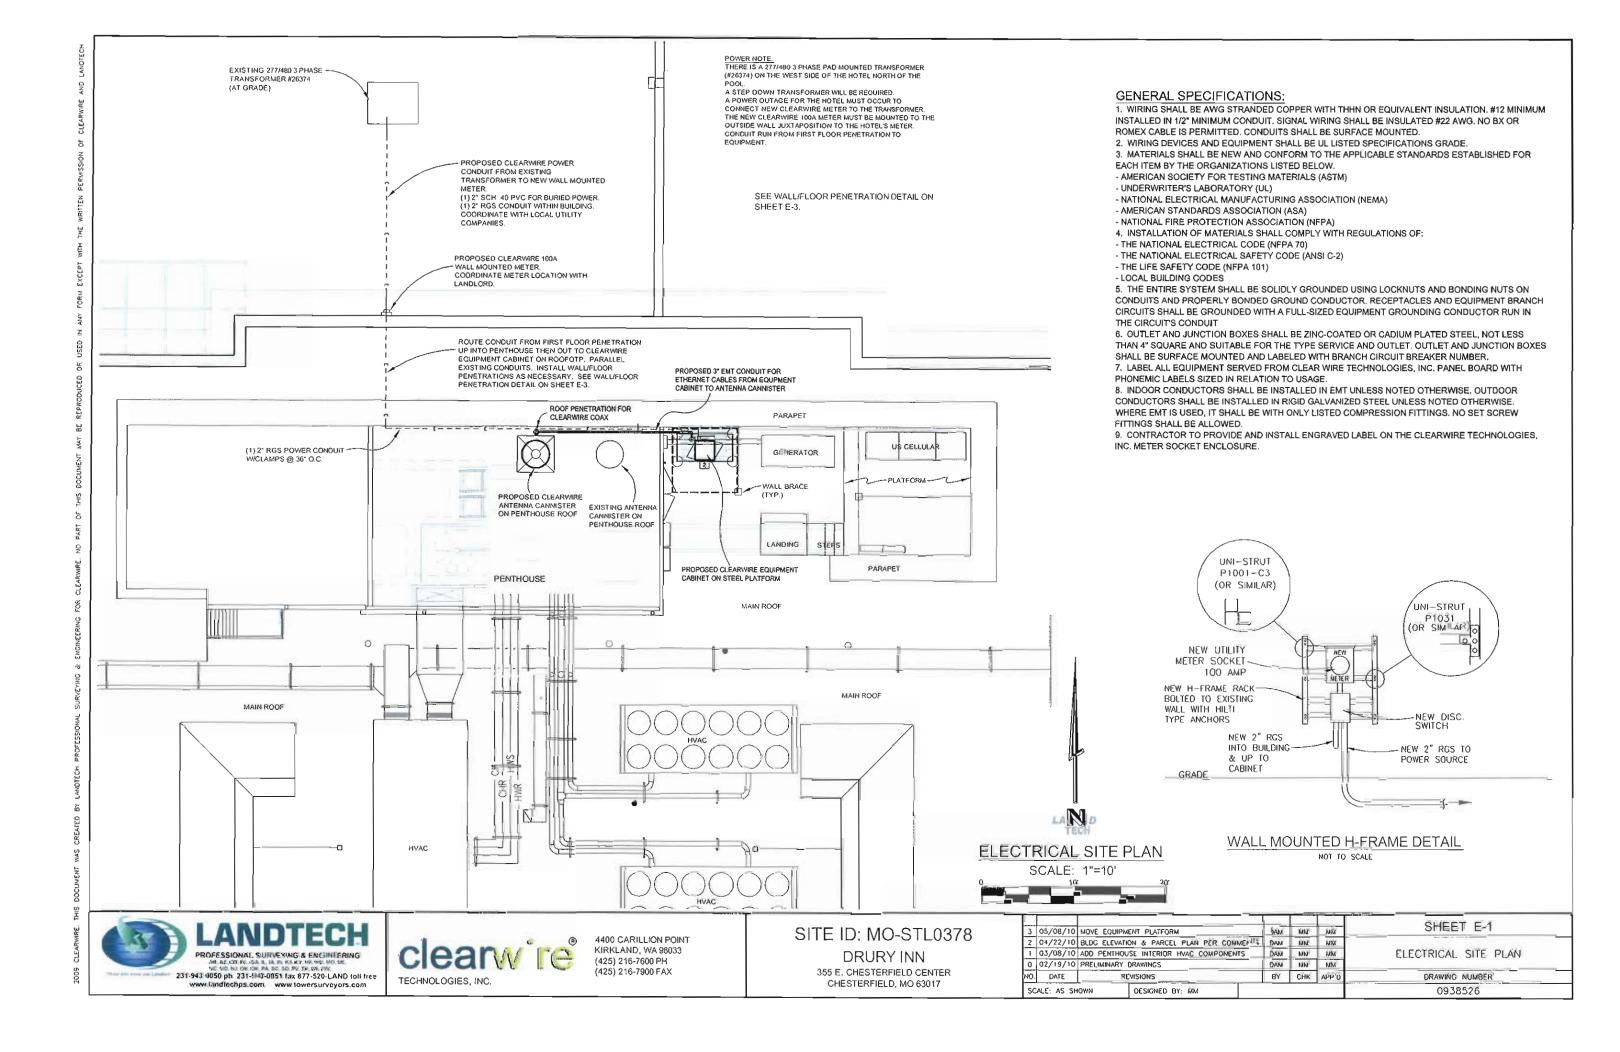

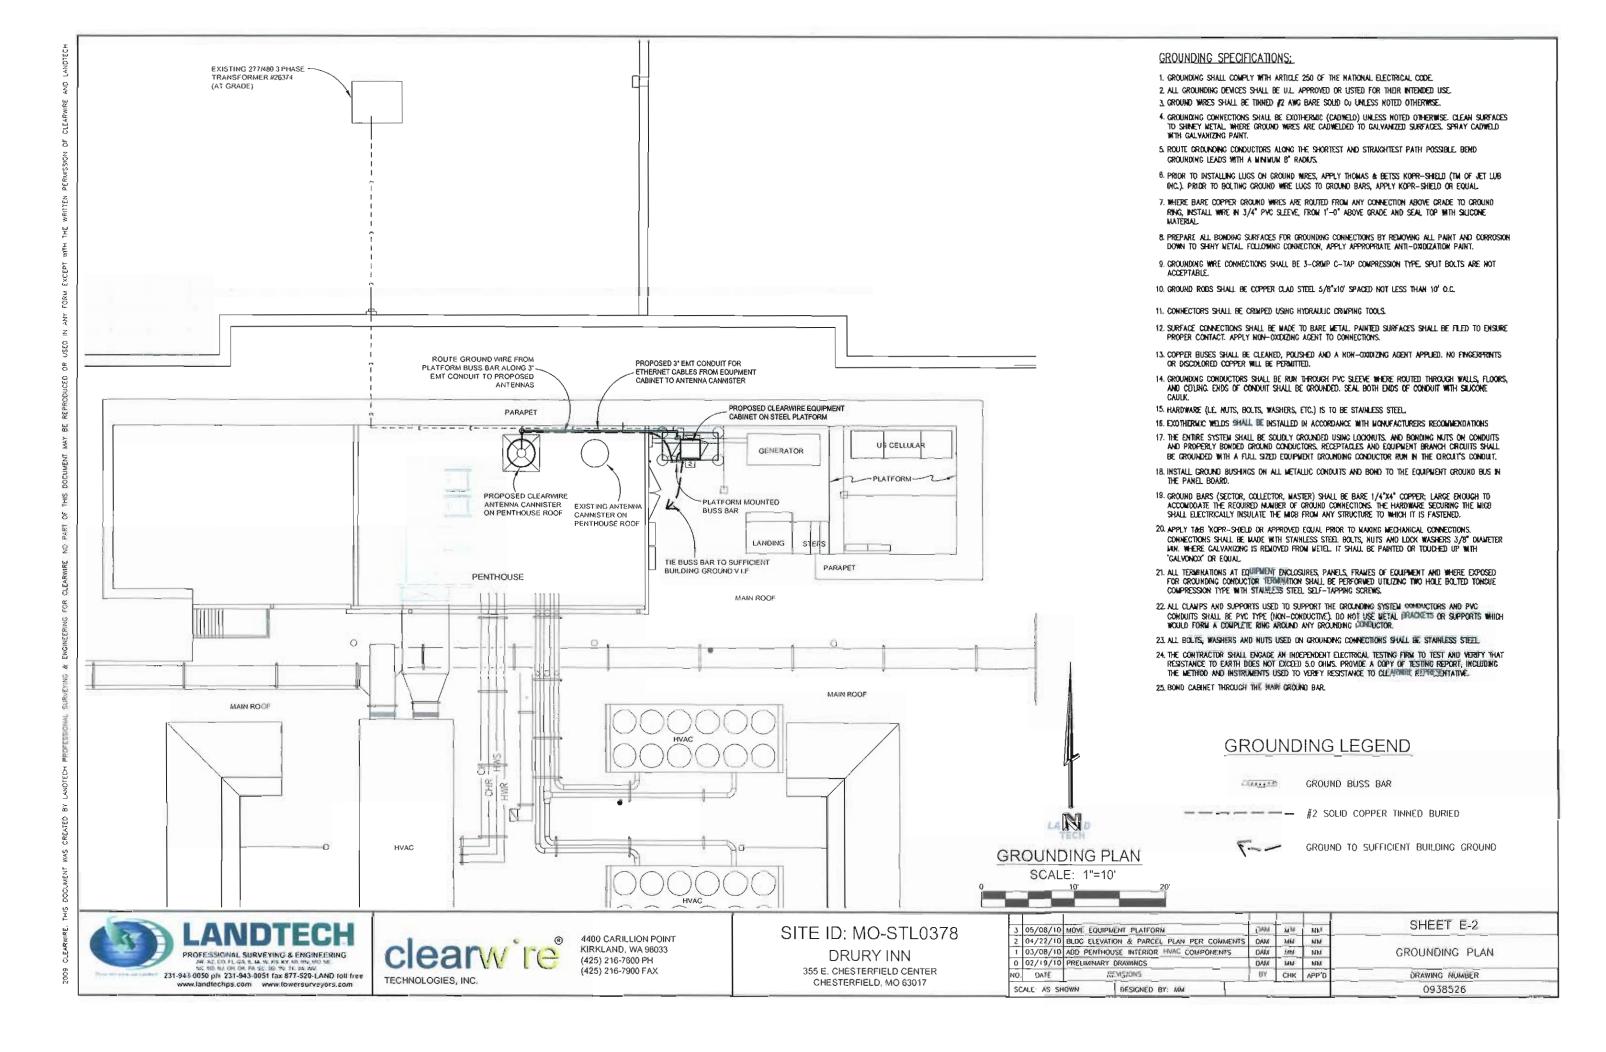


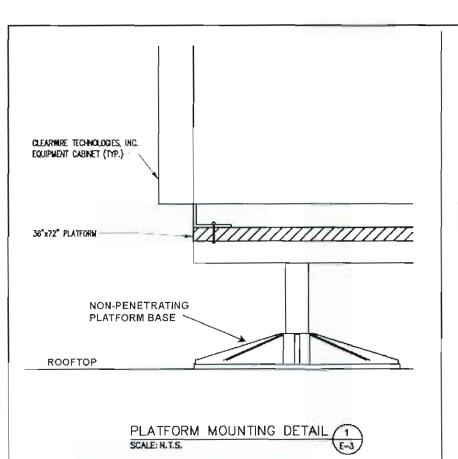

OPTIONAL GROUNDING DETAIL

E4-10-539 DIE MIRA

NOTE: FIELD VERIFY EXACT LOCATION OF LITHLITY SERVICE, WAX, 3/0 CONDUCTOR LENGTH OF 350' FROM EXISTING UTILITY

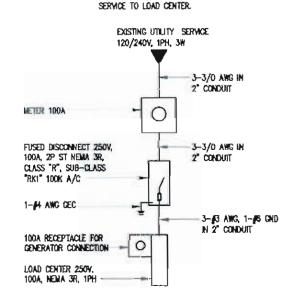

ONE LINE DIAGRAM (E-3)

> R TECHNOLOGIES, INC.

4400 CARILLION POINT KIRKLAND, WA 98033 (425) 216-7600 PH (425) 216-7900 FAX

THROUGH PENETRATION FIRE SIOP SYSTEMS

UL SYSTEMS NO. W-J-1005 (F RATING - 2 HR)

UL FIRE RESISTANCE DIRECTORY -1998 VOL. II, PAGE 693

WALL/FLOOR PENETRATION DETAIL

NOT TO SCALE

EXISTING ~ WALL OR

FLOOR

MIN 3" THICKNESS MINERAL WOOL BATT INSULATION FIRMLY-

PACKED INTO OPENING

SITE ID: MO-STL0378

CORE DRILL (1)-3"0 OPENING FOR (1)-2" DIA. CONDUIT

CORE DRILL (1)-4"0 OPENING FOR (1)-3" DIA CONDUIT

CONTINUOUS SEALANT BOTH

CONTRACTOR SHALL PROVIDE

1" MIN. THICKNESS OF FSP

(NELSON FIRE STOP, TULSA

(1-800-331-7325)). (TYP'L)

**OKLAHOMA** 


PUTTY BETWEEN CONDUIT AND PERIPHERY OF OPENING

SIDES

355 E. CHESTERFIELD CENTER CHESTERFIELD, MO 63017

#### GENERAL NOTES:


- 1. DETAIN PERMITS AND PAY FEES RELATED TO ELECTRICAL WORK PERFORMED ON THIS PROJECT, DELIVER COPIES OF ALL PERMITS TO CLEARWIPE TECHNOLOGIES, INC.
- 2. SCHEDULE AND ATTEND INSPECTIONS RELATED TO ELECTRICAL WORK REQUIRED BY JURISDICTION HAVING AUTHORITY, CORRECT AND PAY FOR ANY WORK REQUIRED TO PASS ANY FALLED INSPECTION.
- 3. REDUNED AS-BUILTS ARE TO BE DELIVERED TO CLEARWIRE TECHNOLOGIES, INC. REPRESENTATIVE.
- 4. PROVIDE TWO COPIES OF OPERATION AND MAINTENANCE MANUALS IN THREE-RING BINDER.
- 5. FURNISH AND INSTALL THE COMPLETE ELECTRICAL SYSTEM, TELCO SYSTEM, AND THE GROUNDING SYSTEM AS SHOWN ON THESE DRAWINGS.
- 8. ALL WORK SHALL BE PERFORMED IN STRICT ACCORDANCE WITH ALL APPLICABLE BUILDING CODES AND LOCAL ORDINANCES, INSTALLED IN A NEAT MANNER AND SHALL BE SUBJECT TO APPROVAL BY CLEARWIRE TECHNOLOGIES, INC. REPRESENTATIVE.
- Conduct a pre-construction site visit and verify existing site conditions affecting this work.
   Report any obsissions or discrepancies for clarification prior to the start of construction.
- 8. PROTECT ADJACENT STRUCTURES AND FINISHES FROM DAMAGE, REPAIR TO ORIGINAL CONDITION ANY DAMAGED AREA.
- Remove debris on a daily basis. Debris not removed in a timely fashkin will be removed by others and the responsible subcontractor shall be charged accordingly. Removal of Debris SHALL BE COORDINATED WITH THE SITE OWNERS REPRESENTATIVE DEBRIS SHALL BE REMOVED FROM THE PROPERTY AND DISPOSED OF LEGALLY, USE OF THE PROPERTY'S DUMPSTER IS PROHIBITED.
- 10. CONTRACTOR TO CONFIRM AVAILABLE CAPACITY AT EXISTING UTILITY PEDESTAL AND ADVISE ENGINEER OF SERVICE SIZE AND FAULT CURRENT LEVEL.
- 1). IF PEDESTAL DOES NOT HAVE ADEQUATE CAPACITY, CONTRACTOR TO SUBMIT COST QUOTATION TO UPGRADE, UPON APPROVAL OF SUBMITTED COST QUOTATION, THE CONTRACTOR SHALL PROVIDE NEW SERVICE AND/OR UPGRADE SERVICE. FEEDERS AND EQUIPMENT/ELECTRODE GROUNDING CONDUCTORS SIZE. ACCORDINGLY.
- 12. CONTRACTOR SHALL YERIFY SEPERATION DIMENSION BETWEEN POWER COMPANY ELECTRICAL CONDUITS AND LP GAS PIPES AS PER UTILITY COMPANY, LOCAL CODES, NEC. NEPA, AND GAS TANK MANUFACTURER'S SPECIFICATION
- 13. CONTRACTOR SHALL VERIFY THAT THE TOTAL NUMBER OF SERVICE ENTRANCE DISCONNECTS IN THE EOSTING UTILITY COMPANY PEDESTAL MUST NOT EXCEED SIX. IF THE NEW SERVICE ADDED EXCEEDS THIS VALUE, CONTRACTOR MUST COORDINATE WITH THE UTILITY COMPANY AND AUTHORITY HAVING JURISDICTION. THE RUNNING OF AN ADDITIONAL EXCLUSIVE AND DEDICATED SERVICE LATERAL SET FOR THE NEW LOAD ADDED TO THE COMPOUND AS PER NEC ARTICLE 230-2(B).
- 14. THE EQUIPMENT/PROTECTIONS MUST BE RATED FOR STANDARD ALC RATE HIGHER THAN INCOMING EQUIPMENT AND/OR UTILITY COMPANY AIC RATE.

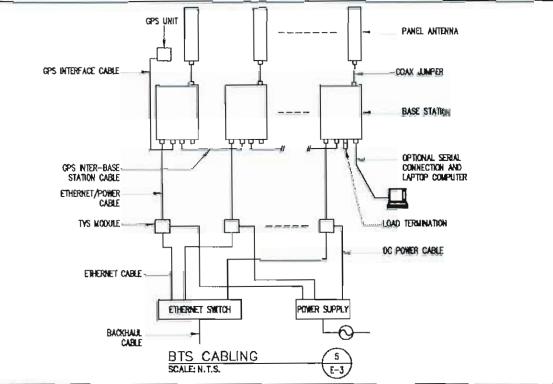



DRURY INN


SHEET E-3 05/08/10 MOVE EQUIPMENT PLATFORM DAM MM MX 2 04/22/10 BLDC ELEVATION & PARCEL PLAN PER COMMENTS DAM MM MM 03/08/10 ADD PENTHOUSE INTERIOR HVAC COMPONENTS DAM MM NIM ELECTRICAL DETAILS DAM MM MM 02/19/10 PRELIMINARY DRAWINGS NO. DATE REVISIONS BY CHK APP'O DRAWING NUMBER 0938526 DESIGNED BY: MM SCALE: AS SHOWN

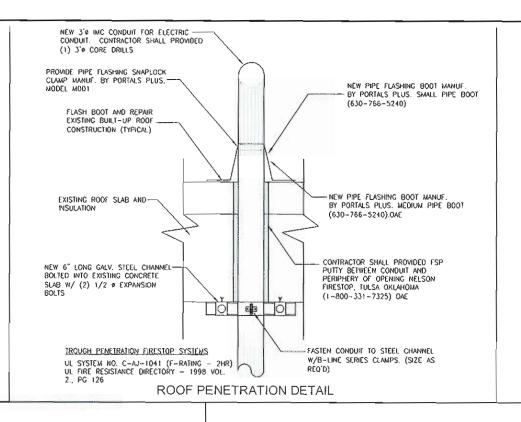

NOTES:

FIELD POSITION ANTENNA CANISTER ON PENTHOUSE ROOF SO THAT BASE PLATE SPANS UNDERLYING STRUCTURAL STEEL MEMBERS. SEE SHEET A-3.5 FOR BASE PLATE INSTALLATION DETAILS.

ORIGINAL ROOF CONTRACTOR TO INSTALL ANTENNA CANISTER BASE PLATE AND ROOF PENETRATION SO AS TO NOT VOID ROOF WARRANTY. SEE ROOF COAX PENETRATION DETAIL ON SHEET E-4.

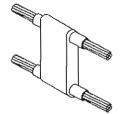

PARALLEL HORIZONTAL CONDUCTORS
PARALLEL THROUGH CONNECTION OF HORIZONTAL CABLES

TYPE PT




YERRICAL PIPE CABLE DOWN AT 45' TO RANGE OF VERTICAL PIPES TYPE VS



HORIZONTAL STEEL SURFACE TO FLAT STEEL SURFACE

OR HORIZONTAL PIPE

BOND JUMPER FIELD FABRICATED GREEN STRANDED INSULATED TYPE 2-YA-2

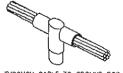

THROUGH CASIF TO GROWN ROD THROUGH CABLE TO TOP OF GROUND ROD




VERTICAL STEEL SURFACE CABLE DOWN AT 45' TO VERTICAL STEEL SURFACE INCLUDING PIPE TYPE VS



COPPER LUGS TWO HOLE-LONG BARREL LENGTH TYPE YA-2

TYP. CADWELD TYPES SCALE: N.T.S.

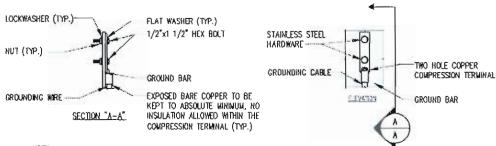

1. "DOUBLING UP" OR "STACKING" OF CONNECTIONS IS NOT PERMITTED.

2. OXIDE INHIBITING COMPOUND TO BE USED AT ALL LOCATIONS AND TO BE APPLIED PRIOR TO ADDING HARDWARE.









4400 CARILLION POINT KIRKLAND, WA 98033 (425) 216-7600 PH (425) 216-7900 FAX

SITE ID: MO-STL0378 DRURY INN


DITOITINIT	
355 E. CHESTERFIELD CENTER	
CHESTERFIELD, MO 63017	


<u> </u>				74.37	-	SHEFT E-4
3	05/08/10	MOVE EQUIPMENT PLATFORM	DAM	MM	MM	
2	04/22/10	SLDC ELEVATION & PARCEL PLAN PER COMMENTS	DAM	MM	MM	
1	03/08/10	ADD PENTHOUSE INTERIOR HVAC COMPONENTS	DAM	MM	MM	GROUNDING DETAILS & NOTES
0	02/19/10	PRELIMINARY DRAWINGS	DAM	ММ	MM	
NO	DATE	REVISIONS	BY	CHK	APP'D	DRAWING NUMBER
so	CALE: AS SH	OWN DESIGNED BY: MM		11		0938526

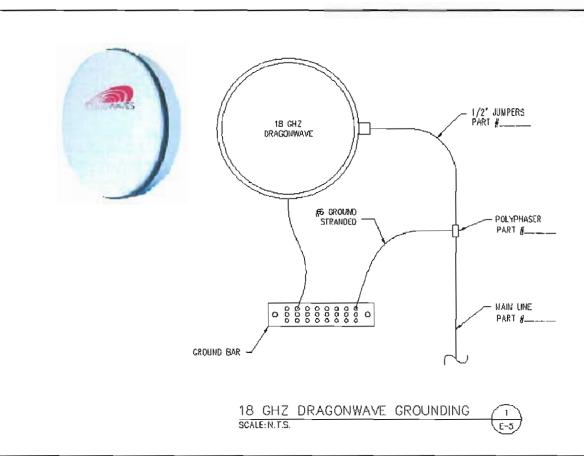

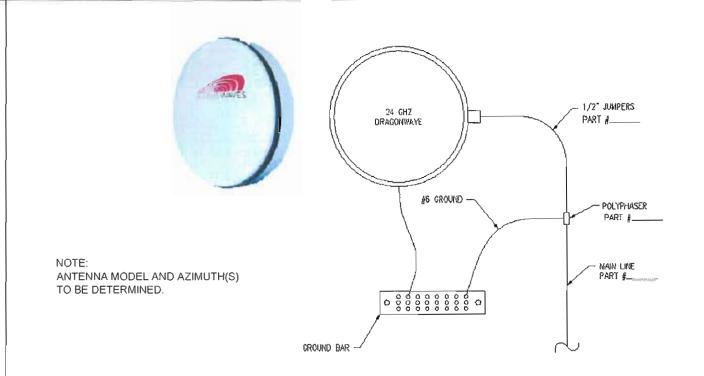

24 GHZ DRAGONWAVE GROUNDING 2 SCALE: N.T.S. E-S

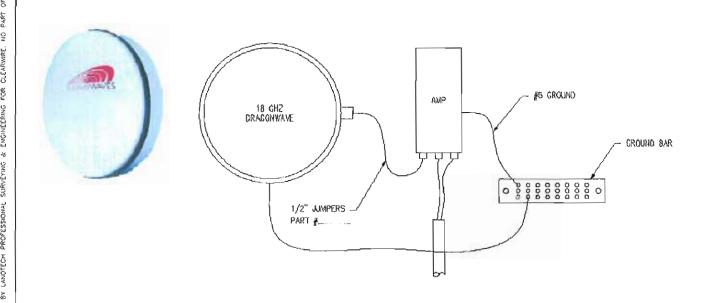

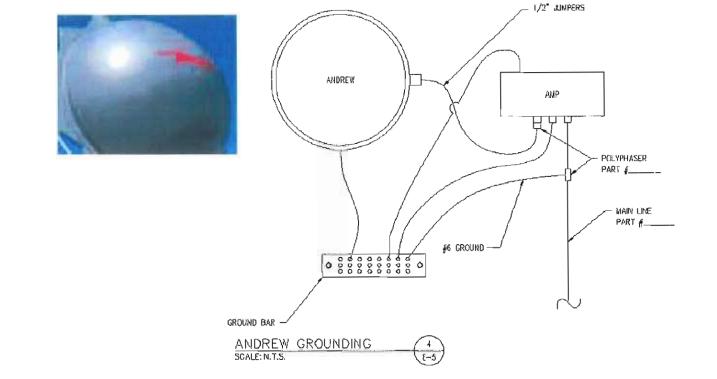

18 GHZ DRAGONWAVE/AMP GROUNDING 3
SCALE: N. T.S.





4400 CARILLION POINT KIRKLAND, WA 98033 (425) 216-7600 PH (425) 216-7900 FAX SITE ID: MO-STL0378

DRURY INN

2110111
355 E. CHESTERFIELD CENTER
CHESTERFIELD, MO 63017

		and the second s	8/05			SHEET E-5
3	05/08/10	MOVE EQUIPMENT PLATFORM	DAM	ММ	MAX	SHEET E-S
2	04/22/10	BLOG ELEVATION & PARCEL PLAN PER COMMENTS	DAM	MM	MM	
ī	03/08/10	ADD PENTHOUSE INTERIOR HVAC COMPONENTS	DAM	MM	MM	GROUNDING ANTENNA DETAILS
)	02/19/10	PRELIMINARY DRAWINGS	DAM	MM	MM	
0.	DATE	REVISIONS	BY	CHK	APP'D	DRAYING NUMBER
SC	ALE: AS SH	OWN DESIGNED BY: MM				0938526