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July 18, 2007

Planning Commission City of Chesterfield 690 Chesterfield Parkway West Chesterfield, MO 63017

The Planning Commission agenda for **July 23, 2007** will include the following item for your consideration:

<u>1 Georgetown Road (Georgetown Estates)</u>: A request for an increase in building height for new residential construction "NU" Non-Urban District located at 1 Georgetown Road in the Georgetown Estates Subdivision.

Dear Planning Commission:

Phillip Vincent has submitted for your review, a request for the height of new construction to exceed two (2) stories with a maximum of thirty-five (35) feet in height. The Department of Planning has reviewed this submittal and submits the following report.

BACKGROUND

- 1. The petitioner is the owner of the property at 1 Georgetown Road.
- 2. The petitioner plans to build a new residential structure on the site that would be two (2) stories and forty-one (41) feet

CITY OF CHESTERFIELD PROCEDURE

1. Section 1003.126A "Regulations for New Construction in Established Districts" states that the height of any new construction shall not exceed 2 stories with a maximum height of 35 feet. This section also states the following:

"Height is calculated from grade at front elevation to the top of the roof. If the height exceeds this requirement it shall be reviewed by the Planning Commission."

- 2. If the height request is approved, the building of this structure will be reviewed for approval by the Departments of Planning and Public Works and then forwarded to St. Louis County for permits and inspections.
- 3. If the height request is not approved, the Petitioner may apply for a variance before the Board of Adjustment. If approved, the building of this structure will be reviewed for approval by the Departments of Planning and Public Works and then forwarded to St. Louis County for permits and inspections.

DEPARTMENTAL INPUT

The submittal was reviewed for compliance with all City of Chesterfield ordinances. The Department of Planning requests approval of the Residential Addition.

Respectfully submitted,

Mara M. Perry, AICP

Senior Planner of Plan Review

Cc: City Administrator

City Attorney

Department of Public Works

Attachments:

Site Plan

Architectural Elevations

Letter From Petitioner

Chesterfield Building Commission


This Letter is to inform the Chesterfield Building Commission that I, Phillip Vincent Need to apply for a variance on the over all height of my home. My plans come in at 41 feet and the regulation calls for 35 feet.

I also have informed all of my adjacent neighbors of my plans to tear down the old home and build a new home. All of the neighbors were in favor of my plans.

Thank you.

Phillip Vincent



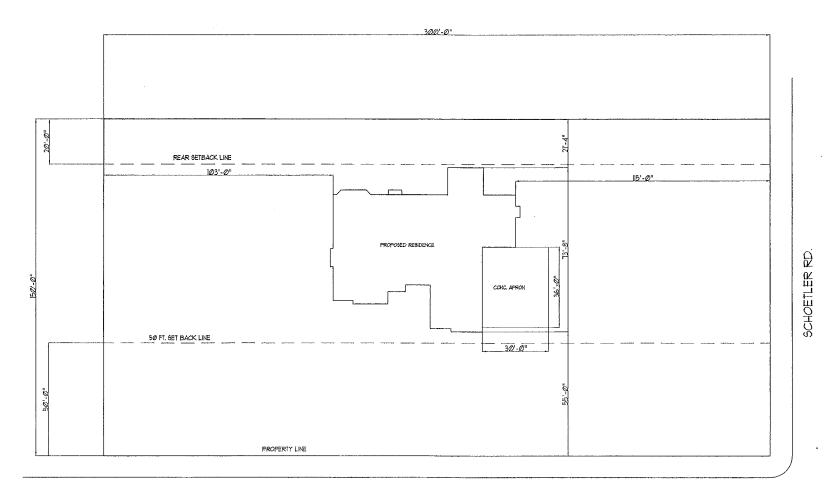

GEORGETOWN

RECEIVED JUN 27 2007
PLANNING DEPARTMENT

DESIGN CONCEPTS

29 Tiger Dr.

WENTZVILLE MO. 63385 636/332/5760

VINCENT BUILDERS


GEORGETOWN & SCHOETTLER

LOCATION

CHESTERFIELD MO.

Date

SHEET NO.

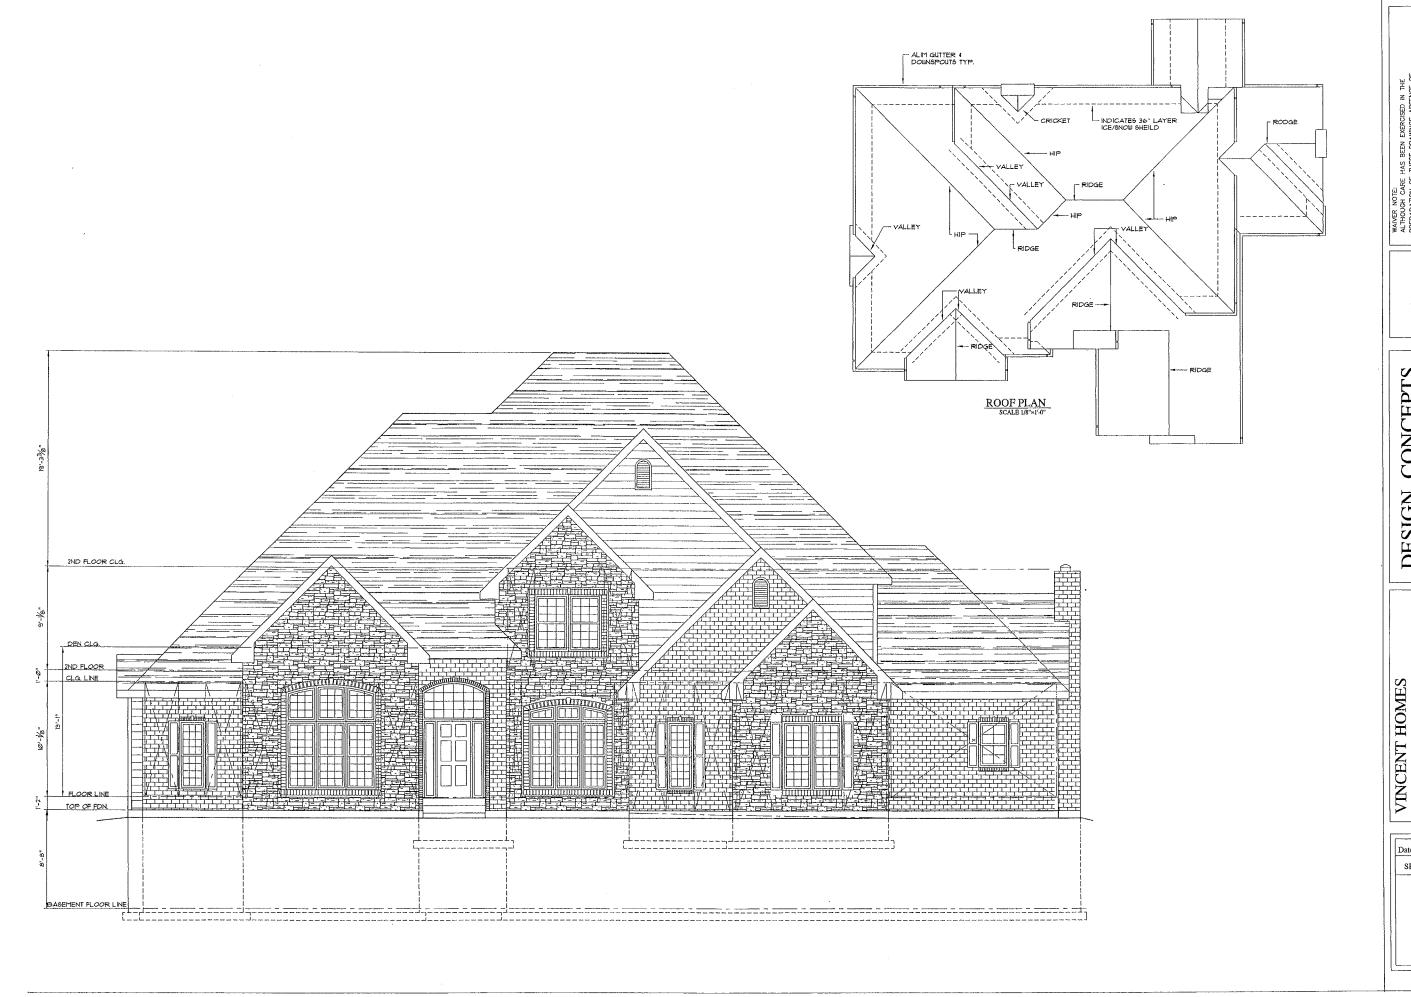

DESIGN CONCEPTS

29 TIGER DR.
WENTZVILLE MO. 63385
636-332-5760
314-971-2536

PHONE 314-713-2363 ST. LOUIS CO. MISSOURI

Date 6/20/07 SHEET NO.

FIED BRACING METHOD FOR ONE (IWO FAMILT DWELLINGS WHEN THE ENTIRE STRUCTURE IS SHEATHED WITH WOOD STRUCTURE I ASSE ום אבעיט דבא אשענטג THE INTERIOR & EXTERIOR WALL CONFIGURATION BRACES THE STRUCTURE IN ACCORDANCE WITH OR EQUIVILENT TO THE SHEATHING FILLER ESIGN PROFESSIONAL DOES NOT HAVE TO DEFINE THE BRACED WALL LOCATIONS (IDENTIFY THE PERCENTAGE OF THE BRACED WALL PANELS WITH ECT TO THE BRACED WALL LINE IF THE FOLLOWING CRITERIA ARE MET. LATERAL BRACING PROVISIONS OF SECTION R60210 EDITION OF THE IRC OR SECTION 2305 OF THE 2003 EDITION IF NEEDED MIN. 3 1/4" × 11 1/4 VL. HEADER BUILDING WALLS ARE SHEATHED WITH THE OR THICKER WOOD STRUCTURAL PANELS (PLYWOOD OR 05B), THE WOOD STRUCTURAL PANELS SHALL SPLIED TO ALL EXTERIOR WALLS, GABLE ENS, 4 BAND BOARDS. ALL VERTICAL JOINTS BETWEEN PANELS SHALL BE BLOCKED, HORIZONTAL JOINTS EN PANELS ON DETACHED DWELLINGS MAY REMAIN WISLOCKED.

ACED WALL PANELS ARE LOCATED IN EVERY EXTERIOR BRACED WALL LINE IN ACCORDANCE WITH THE FOLLOWING CRITERIA.

HE EDGE OF THE FIRST BRACED WALL, PANEL MEETING THE WIDTH ESTABLISHED IN THE TABLE BELOW IS LOCATED 12'6" OR LESS FROM EACH END BY THE PROPERTY OF THE WIDTH ESTABLISHED IN THE TABLE BELOW IS LOCATED 12'6" OR LESS FROM EACH END BY THE PROPERTY OF THE WIDTH ESTABLISHED IN THE TABLE BELOW IS LOCATED 12'6" OR LESS FROM EACH END BY THE PROPERTY OF THE WIDTH ESTABLISHED IN THE TABLE BELOW IS LOCATED 12'6" OR LESS FROM EACH END BY THE PROPERTY OF THE WIDTH ESTABLISHED IN THE TABLE BELOW IS LOCATED 12'6" OR LESS FROM EACH END BY THE PROPERTY OF THE WIDTH ESTABLISHED IN THE TABLE BELOW IS LOCATED 12'6" OR LESS FROM EACH END BY THE PROPERTY OF THE WIDTH ESTABLISHED IN THE TABLE BELOW IS LOCATED 12'6" OR LESS FROM EACH END BY THE PROPERTY OF THE WIDTH ESTABLISHED IN THE TABLE BELOW IS LOCATED 12'6" OR LESS FROM EACH END BY THE PROPERTY OF THE WIDTH ESTABLISHED IN THE TABLE BELOW IS LOCATED 12'6" OR LESS FROM EACH END BY THE PROPERTY OF THE WIDTH ESTABLISHED IN THE TABLE BELOW IS LOCATED 12'6" OR LESS FROM EACH END BY THE PROPERTY OF THE WIDTH ESTABLISHED IN THE WIDTH ESTABLISHED WAIVER NOTE:

ALTHOUGH CARE HAS BEEN EXERCISED IN THE PREPARATION OF THESE DRAWNIGS ABSENCE OF ALL HUMAN ERRORS AND/OR OMISSIONS CANNOT BE GUARANTED. ALL CONDITIONS & DIMENSIONS SHALL BE VERFIED IN THE FIELD.

THESE DRAWNIGS DO NOT PURPORT TO COVER ALL THE DETAILS ENCOUNTERED IN THE FIELD. IN THE ABSENCE OF SUCH DETAIL THE ACCEPTED TO TANDARD PRANTICE OF THE PARTICULAR TRADE WHICH SHALL MEET ALL APPLICABLE CODE REC. SHALL BE ADAPTED TO THIS PROJECT. 2' TO 16' FINISHED WIDTH IIIALL BRACING METHOD: IF THE BRACED WALL LINE.

FINE BRACED WALL LINE.

EPTION, THE EDGE OF THE FIRST BRACED WALL PANEL MAY BE LOCATED MORE THAN 12"-6" AND UP TO 20"--0" FROM THE END OF THE BRACED WALL

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FITHE COLLECTOR SYSTEM "PANEL OFFSET" CRITERIA ON P. 9 OF APPENDIX "A" ONE 4 TWO FAMILY WIND BRACING GUIDELEINES IS ADHERED TO

DETAILED ON THE CONSTRUCTION DOCUMENTS OR WHEN THE ENGINEER OR ARCHITECT PROVIDES CALCULATIONS AND DETAILS FOR AN ALTERNATE WALL BRACING HETHOD:
SIMPLIFIED WALL BRACING METHOD IS USED ON THIS
STRUCTURE.
HE BUILDING EXTERIOR WALLS ARE SHEATHED
WITH 1/16 OSB PANELS, AND MEET THE GUIDELINES
OF THE IRC AND ST. LOWIS COUNTY APPENDIX "A"
FOR ONE I TWO FAMILY WIND BRACING GUIDELINES. FASTEN SHEATHING TO HOR, WITH BD COM, NAILS IN 3" GRID PATTERN PER TABLE 1000 LB. HDR. TO JACK STRAP ON BOTH SIDES OF OPENING R5025 142) AS SHOUN 4 3" O.C. IN ALL STUDS, SILLS TYP 1000 LB. HDR. TO JACK STUD STRAP ON BOTH SIDES OF OPMG. (INSTALL AS SHOWN ON SIDE ELEVATION LECTOR \$19TEM.

ECOTOR \$19TEM.

HE CENTERLINE SPACING OF BRACED WALL PANELS IN A BRACED WALL LINE MAY NOT EXCEED 25'.

HE CENTERLINE SPACING OF BRACED WALL PANELS IN A BRACED WALL LINE MAY NOT EXCEED 25'.

ACED WALL PANELS LOCATIONS ARE SHOWN ON THE FLOOR FLANS OR THE ELEVATION VIEWS AND MEET THE WIDTH ESTABLISHED IN THE FOLLOWING TABLE. THE INTERIOR 1 EXTERIOR WALL CONFIGURATION BRACES THE STRUCTURE IN ACCORDANCE WITH OR EQUIVILENT TO THE LATERAL BRACING PROVISIONS OF SECTION R602.10 EDITION OF THE IRC OR SECTION 2305 OF THE 2003 EDITION OF THE IBC. WIDTH OF SOLID PANEL IF PANEL SPLICE IS NEEDED IT SHALL OCCUR WITHIN 24" OF MID-HEIGHT BLOCKING IS NOT REQUIRED 3/8 MIN. THICKNESS WOOD STRUCTURAL PANEL SHEATHING 8' WALL HEIGHT 9' WALL HEIGHT 10' WALL HEIGHT 12' WALL HEIGHT WOOD/OSB PANEL 3:1 48" 32× 36 40" 24" 0 NARROW PORTAL 6:1 16" 200" MIN. WIDTH BASE ON 6:1 HEIGHT TO WIDTH RATIO FOR EXAMPLE 16" MIN. FOR 8' HEIGHT AR INTERPOLATION 18 PERMITTED.

LL HEIGHT 16 THE VERTICAL DISTANCE FROM THE BOTTOM OF THE SOLE/BILL PLATE TO THE TOP OF THE DOUBLE PLATE, AN ADDITIONAL 2" VARIATION IN IGHT 16 ALLOWED FOR PRE CUIT STUD FRAMING.

E APA NARROW WALL PANEL, IF APPLICABLE, SHALL BE CONSTRUCTED IN ACCORDANCE WITH FIGURE 11 IN THE ST LOUIS COUNTY APPENDIX "A" ONE I TWO MILLY WIND BRACING GUIDELINE. THE DESIGN PROFESSIONAL SHALL PROVIDE THE DETAIL ON THE CONSTRUCTION DOCUMENTS.

19 APA NARROW PORTAL WALL WIDTH ASSIMES THE BEAM 15 PLACED INDER THE TOP PLATE OF THE WALL. ONE MAY COMPUTE THE THE ROUIRED WIDTH 195ED ON THE 6-1 HEIGHT TO WIDTH RATIO FOR A TOP OF BEAM 18 IGHT OR LOCATED LOWER THAN THE WALL. (IELD® "PORATL WALL CAN BE USED WHEN THE POR FITHE BEAM 15 IG "O". IN A 12"-Y JALL WALL.)

10 PC THE SEAM 15 IG "O". IN A 12"-Y JALL WALL.)

11 E EXTERIOR WALL CORNERS SHALL BE CONSTRUCTED IN ACCORDANCE WITH FIGURES IG 12 IN THE ST LOUIS COUNTY APPENDIX "A" ONE AND TWO FAMILY BRACING GUIDELINE. THE DESIGN PROFESSIONAL SHALL PROVIDE THESE DETAILS ON THE CONSTRUCTION DOCUMENTS.

12 IN THE PERPENDICULAR DISTANCE BETWEEN THE EXTERIOR BRACED WALL LINES EXCEED 50", THE DESIGN PROFESSIONAL SHALL INCLUDE THE FOLLOWING IFICATION ON THE DOCUMENTS. AR INTERPOLATION IS PERMITTED. GARAGE FOUNDATION TYP, TWO OPENINGS AT GARAGE OVER CONCRETE OR MASONRY BLOCK FOUNDATION ALL HEIGHT MAY NOT EXCEED 12' (12'-12" ACTUAL) WALLS GREATER THAN 12' SHALL BE DESIGNED AND DETAILED BY THE ENGINEER OR ARCHITECT ESIST WIND LOADS IN BOTH THE LONGITUDINAL AND TRANSVERSE DIRECTIONS. - NAILS SOLE PLATE TO BAND JOIST PER TABLE R6023 (1) NAIL SOLE PLATE TO JOIST PER TABLE — R6013(1) FRAMING ANCHORS 610 I B 670 LB APPROVED BAND JOIST -3/8 MIN. THICKNESS WOOD STRUCTURAL PANEL OVER APPROVED BANDJOIST W/ TIE DOWNS WOOD STRUCTURAL PANEL SHEATHING CONCEPT 63385 - NAILS SOLE PLATE TO BAND JOIST PER TABLE R6023 (I) NAIL SOLE 3/LATE TO JOIST PER TABLE _____ R6/013(1) 29 TIGER DR.
WENTZVILLE MO. 6
636-332-5760
314-971-2536 APPROVED BAND JOIST ONE OFING, LOWER FRONT BEDROOM WOOD STRUCTURAL PANEL OVER APPROVED BANDJOIST DESIGN OVER RAISED WOOD FLOOR OR SECOND FLOOR-WOOD STRUCTURAL PANEL OVERLAP PORTAL WALL FRAMING DETAIL 10'-4" 2 /3/4" = 1'-0" (2) IGD NAILS AT 24" O.C. 8D NAILS 6" O.C. IN ALL PANEL EDGES NOT PART OF PORTAL FRAME 0 o (/ FRAMING FOR GYPSUM WALL BOARD (OPTIONAL) CORNER FRAMING USED IN CONNECTION WITH 6:1 ASPECT RATIO VINCENT HOMES WOOD STRUCTURAL PANEL 8D NAILS 4 4" O/C ALL PANELS EDGES VINTL SIDING VINTL SIDIN 000 VINYL SIDING VINTL/ BILDING PHONE 314-713-2363 ST. LOUIS C MISSOURI 2 - 16D NAILS 24" O/C EXTERIOR CORNER VINTE STOING VINTL SIDING 2 - 16D NAILS 24" O/C Date 6/20/07 UCOD STRUCTURAL PANEL INSTALLED IN ACCORDANCE U/ TABLE 6023 (1) INSTALLED IN ACCORDANCE SHEET NO. BD NAILS . 4" O/C ALL PANELS EDGES

REAR ELEVATION

CORNER DETAILS SCALE 3/4" . I' @"

INTERIOR CORNER

