

Memorandum Department of Planning & Public Works

To: Planning and Public Works Committee

From: Shawn Seymour, AICP Senior Planner

Date: June 21, 2010

RE: T.S.P. 20-2010 Clearwire US LLC. (14550 South Outer 40 Road): A request to obtain approval for a Telecommunication Facility Siting Permit for the location of antennas and equipment on an existing AmerenUE transmission tower in a "NU" Non-Urban District-zoned rightof-way located southeast of the US Highway 40 and Timberlake Manor interchange (19R540055).

<u>Summary</u>

Clearwire US LLC, has requested a telecommunications facilities siting permit to allow the following on an existing AmerenUE transmission line tower located along the right-of-way of South Outer 40 Road north of the Suburbia Gardens Landscaping business:

- Location of antennas to facilitate a broadband internet service on an existing AmerenUE transmission tower.
- > Addition of ground located equipment located at the base of the transmission tower.

City of Chesterfield Ordinance 2391, which governs telecommunications and facilities siting, requires that the Planning Commission provide a venue for public hearing of requests for Telecommunications Siting Permits. Please note, the Commission does not provide a recommendation to the City Council, but rather generates a list of issues during the hearing. At the public hearing on June 14, 2010, no outstanding issues were identified.

Attached are copies of the materials submitted to the Planning Commission.

Respectfully submitted,

Shawn Seymour, AICP Senior Planner

CC: Michael G. Herring, City Administrator Rob Heggie, City Attorney Michael O. Geisel, Director of Planning & Public Works Aimee Nassif, Planning & Development Services Director





690 Chesterfield Pkwy W • Chesterfield MO 63017-0760 Phone: 636-537-4000 • Fax 636-537-4798 • www.chesterfield.mo.us

Department of Planning & Public Works Public Hearing Summary Report

T.S.P. 20-2010 Clearwire US LLC. (14550 South Outer 40 Road): A

request to obtain approval for a Telecommunication Facility Siting Permit for the location of antennas and equipment on an existing AmerenUE transmission tower in a "NU" Non-Urban District-zoned right-of-way located southeast of the US Highway 40 and Timberlake Manor interchange (19R540055).

<u>Summary</u>

The above-referenced project is a request for a Telecommunications Siting Permit (T.S.P.). If the request is approved, the Permit will allow placement of antennas from a new user, Clearwire US, on an existing AmerenUE transmission line tower located at 14550 South Outer 40 Road. Equipment to support the antennas is proposed to be placed at the base of the AmerenUE tower.

City of Chesterfield Ordinance 2391, which now governs telecommunications and facilities siting, requires a public hearing before the City of Chesterfield Planning Commission when a request is made for T.S.P. Please note, the Commission does not provide a recommendation to the City Council, but rather a list of issues generated during the hearing. City Council is the decision-making body for all requests for Telecommunications Siting Permits. A public hearing further addressing the request will be held at the June 14, 2010 City of Chesterfield Planning Commission meeting. Attached please find a copy of the Public Hearing Notice and an application packet detailing the Petitioner's request.

Respectfully submitted,

Shawn Seymour, AICP Senior Planner

Cc: Michael G. Herring, City Administrator Rob Heggie, City Attorney Michael O. Geisel, Director of Planning and Public Works Aimee Nassif, Planning and Development Services Director



Existing Structure

NOTICE OF PUBLIC HEARING CITY OF CHESTERFIELD PLANNING COMMISSION

NOTICE IS HEREBY GIVEN that the Planning Commission of the City of Chesterfield will hold a Public Hearing on Monday, June 14, 2010, at 7:00 PM, in the Council Chambers at the City Hall, 690 Chesterfield Parkway West, Chesterfield, Missouri 63017. Said hearing will be as follows:

T.S.P. 20-2010 Clearwire US LLC. (14550 South Outer 40 Road): A request to obtain approval for a Telecommunication Facility Siting Permit for the location of additional antennas and equipment on an existing AmerenUE transmission tower in a "NU" Non-Urban District-zoned right-of-way located southeast of the US Highway 40 and Timberlake Manor interchange (19R540055).



Anyone interested in the proceedings will be given an opportunity to be heard. Copies of the request are available for review in the Department of Planning and Public Works at the Chesterfield City Hall, 690 Chesterfield Parkway West during weekdays between the hours of 8:30 a.m. and 4:30 p.m. If you should need additional information about this project, please contact Mr. Shawn P. Seymour, Senior Planner, by telephone at 636-537-4741 or by email at sseymour@chesterfield.mo.us


CITY OF CHESTERFIELD Maurice L. Hirsch, Jr., Chair Chesterfield Planning Commission

Description of Area

Part of Lot 2 of the Subdivision of land of Samuel Conway, deceased, in partition in U.S. Survey 366 and Section 13 and 14, Township 45 North, Range 4 East, in St. Louis County, Missouri, according to the Plat thereof recorded in Plat Book 9 Page 77 of the St. Louis City (former County) Records.


MO-STL0379 Coverage Analysis



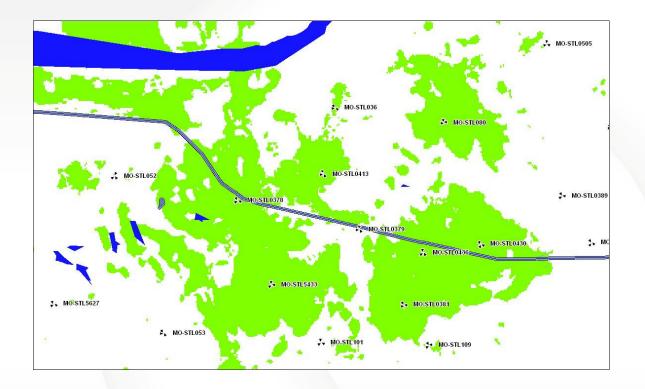

Indoor Coverage without MO-STL0379



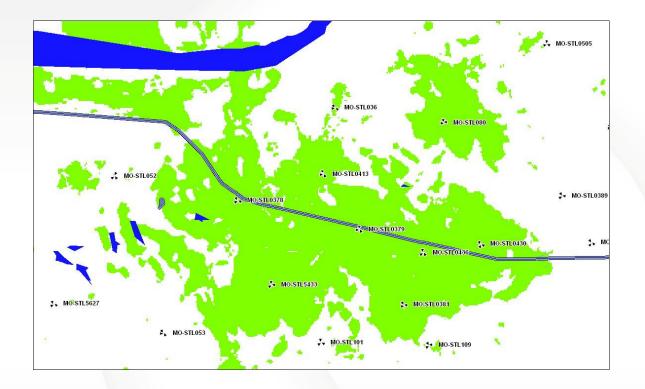

Indoor Coverage with MO-STL0379



CLEARWIRE PROJECT MANAGEMENT	DATE
CLEARWIRE CONSTRUCTION MANAGEMENT	DATE
CLEARWIRE ENGINEERING	DATE
BACKHAUL ENGINEERING	DATE
LANDLORD	DATE




SITE ID: MO-STL0379

MASON GRAY SUMMIT #25

MASON GRAY SUMMIT #25

14550 S. OUTER 40 RD.

CHESTERFIELD, MO 63017

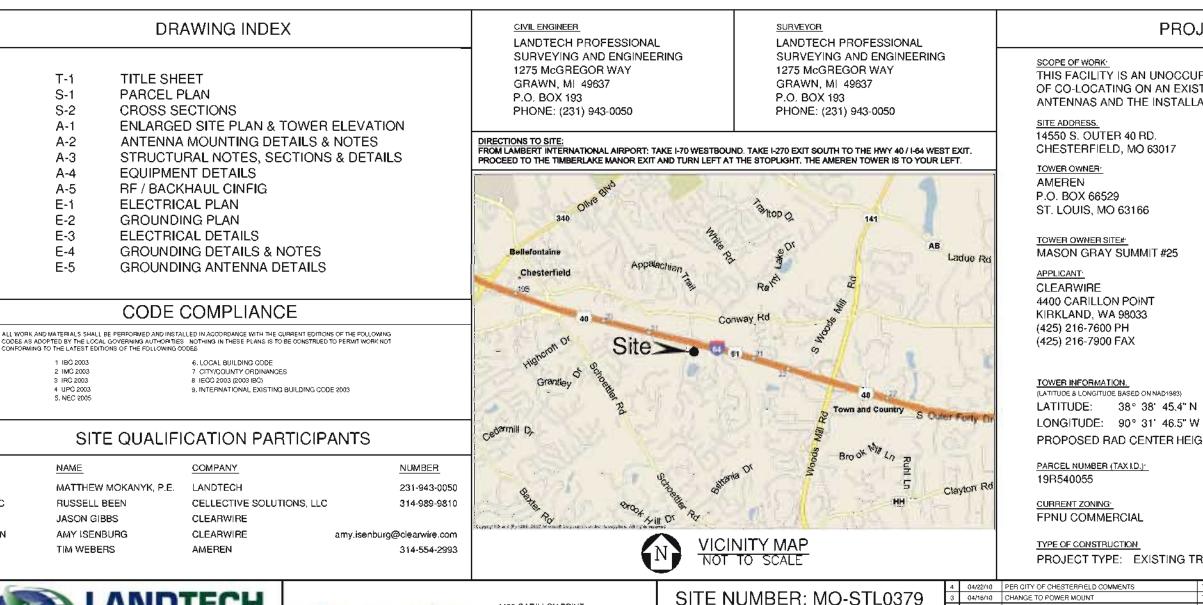

4400 CARILLON POINT

KIRKLAND WA 98033

(425) 216-7600 PH

(425) 216-7900 FAX

T-1

S-1

S-2

A-1

A-2

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1 IBC 2003

2 IMC 2003 3 IBC 2003

4 UPC 2003

5, NEC 2005

NAME

RUSSELL BEEN

AMY ISENBURG

PROFESSIONAL SURVEYING & ENGINEERING

231-943-0050 ph 231-943-0051 fax 877-520-LAND toll free

www.landtechps.com www.towersurveyors.com

TECHNOLOGIES, INC

JASON GIBBS

TIM WEBERS



PROJECT INFORMATION

THIS FACILITY IS AN UNOCCUPIED TELECOMMUNICATIONS FACILITY CONSISTING. OF CO-LOCATING ON AN EXISTING TRANSMISSION TOWER WITH MICROWAVE ANTENNAS AND THE INSTALLATION OF NEW OUTDOOR EQUIPMENT ON GRADE.

CONTACT. AMY ISENBURG

PROPOSED RAD CENTER HEIGHT: 140' AGL



01/07/10 NEW ANTENNA CONFIG

06/01/09

DATE

SCALE: AS SHOWN

11/02/09 PRELIMINABLY CONSTRUCTION DR

PRELIMINARY DRAWING

REVISIONS

DESIGNED BY

PROJECT TYPE: EXISTING TRANSMISSION TOWER

IMENTS		тсм	MM	MM	SHEET T-1
		тсм	MM	ММ	SHEET 1-1
		TCM	мм	мм	
AWINGS		TCM	мм	мм	TITLE SHEET
		CJL	MM	ММ	
		BY	СНК	APP'D	DRAWING NUMBER
мм					0938527

SITE ADDRESS:

14550 S. OUTER 40 RD. CHESTERFIELD, MO 63017

LAND OWNER:

40-TIMBERLAKE SE LLC 36 BRIARCLIFF STREET ST. LOUIS, MO 63124

TOWER OWNER:

AMEREN P.O. BOX 66529 ST. LOUIS, MO 63166

ZONING:

SUBJECT SITE: FPNU COMMERCIAL NORTH OF SITE: HIGHWAY SOUTH OF SITE: NU RESIDENTIAL EAST OF SITE: R3 RESIDENTIAL WEST OF SITE: HIGHWAY

AREA DATA:

PARENT PARCEL AREA: 8.71 ACRES LEASE AREA: 49 SQ.FT. AREA OF CONSTRUCTION: 49 SQ.FT.


PARENT PARCEL DESCRIPTION

Part of Lot 2 of the Subdivision of land of Samuel Conway, deceased, in partition in U.S. Survey 366 and Sections 13 and 14, Township 45 North, Range 4 East, in St. Louis County, Missouri, according to the Plat thereof recorded in Plat Book 9 Page 77 of the St. Louis City (former County) Records, being described as:

Beginning at a railroad spike at the intersection of the South line of T.R. Highway No. 40 with the West line of said Lot 2, thence South 4 degrees 35-1/2 minutes West 439.38 feet, thence South 14 degrees 58 minutes East 152.33 feet; thence South 64 degrees 18 minutes East 27.72 feet, thence North 14 degrees 54 minutes East 84.10 feet, thence North 35 degrees 25 minutes West 57.80 feet, thence North 83 degrees 6 minutes East 65.62 feet, thence South 65 degrees 54 minutes East 155.03 feet, thence North 89 degrees 19 minutes East 47.49 feet, thence North 73 degrees 22 minutes East 50.63 feet, thence South 49 degrees 51 minutes East 47.50 $\,$ feet, thence South 14 degrees 51 minutes West 144.90 feet, thence South 13 degrees 28 minutes East 33.81 feet, thence South 74 degrees 10 minutes East 80.14 feet, thence South 87 degrees 17 minutes East 205 feet, thence North 22 degrees 19 minutes East 24.28 feet, thence North 85 degrees 53 minutes East 248 feet to an old iron stone at the Northeast corner of Lot 4 of said Subdivision, thence North 4 degrees 7 minutes West to the South line of said T.R. Highway No. 40, thence North 76 degrees 46 minutes West along the South line of said Highway a distance of 856.43 feet, more or less, to the point of beginning, according to Survey made by Elbring Surveying Company during the Month of April, 1960, EXCEPTING THEREFROM that part thereof condemned for new right-of-way T.R. Highway No. 40, in Condemnation Suit No. 276693 in the Circuit Court of St. Louis County, Missouri.

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3	04/16/10	CHANGE TO POWER MOUNT
2	01/07/10	NEW ANTENNA CONFIG
1	11/02/09	PRELIMINARY CONSTRUCTION DRA
0	06/01/09	PRELIMINARY DRAWINGS
NO.	DATE	REVISIONS
SC	ALE: AS SHO	DWN DESIGNED BY:

SITE ADDRESS:

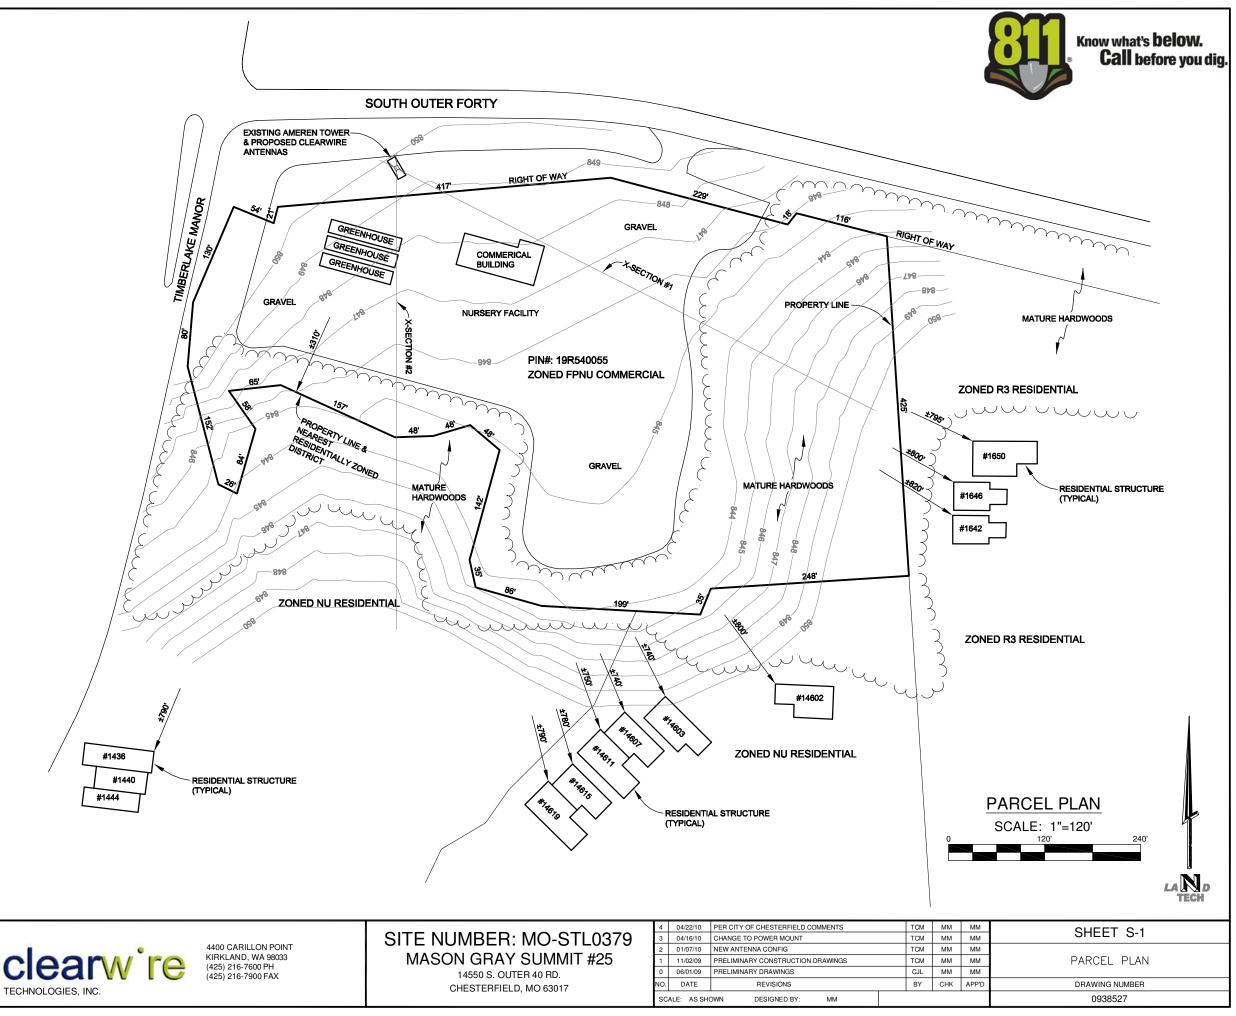14550 S. OUTER 40 RD. CHESTERFIELD, MO 63017

LAND OWNER:

40-TIMBERLAKE SE LLC 36 BRIARCLIFF STREET ST. LOUIS, MO 63124

TOWER OWNER:


AMEREN P.O. BOX 66529 ST. LOUIS, MO 63166


ZONING:

SUBJECT SITE:FPNU COMMERCIALNORTH OF SITE:HIGHWAYSOUTH OF SITE:NU RESIDENTIALEAST OF SITE:R3 RESIDENTIALWEST OF SITE:HIGHWAY

AREA DATA:

PARENT PARCEL AREA: 8.71 ACRES LEASE AREA: 49 SQ.FT. AREA OF CONSTRUCTION: 49 SQ.FT.

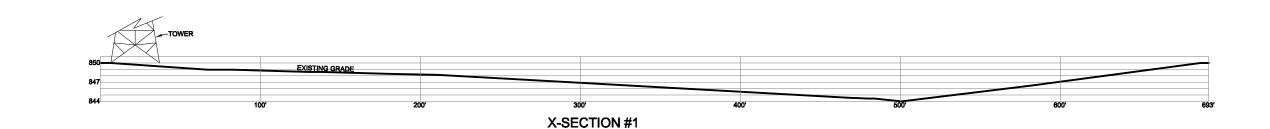

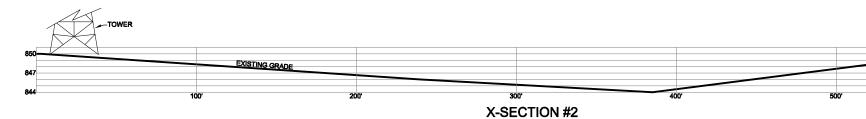

4400 CARILLON POINT KIRKLAND, WA 98033 (425) 216-7600 PH

(425) 216-7900 FAX

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TECHNOLOGIES, INC.

EHH ELECTRIC HANDHOLE IRON FOUND IRON FOUND IRON SET PK: NAIL FOUND PK: NAIL SET GPS MONUMENT MONUMENT FOUND < -----GUY GUY WATER VALVE HYDRANT GAS METER GAS MARKER OSTS STORM MANHOLE UTEL TELEPHONE PEDESTAL • SIGN POST B SQUARE CATCH BASI - FENCE LINE O SNS SANITARY MANHOLE BENCHMARK SANITARY CLEAN-OUT LEGEND MONITOR WELL TELCO. MANHOLE L UTILITIES AS SHOWN ARE APPROXIMATE CATIONS DERIVED FROM ACTUAL MEASUF LIGHT POLE ELECTRIC T ELECTRIC METER



CROSS SECTIONS HORIZONTAL SCALE: 1"=60'

VERTICAL SCALE: 1"=15'


SITE NUMBER: MO-STL0379 MASON GRAY SUMMIT #25 14550 S. OUTER 40 RD. CHESTERFIELD, MO 63017


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	3	04/16/10	CHANGE TO POWER MOUNT	TCM	MM	MM	SHEET 3-2
	2	01/07/10	NEW ANTENNA CONFIG	TCM	MM	MM	
	1	11/02/09	PRELIMINARY CONSTRUCTION DRAWINGS	TCM	MM	MM	CROSS SECTIONS
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SCALE: AS SHOWN DESIGNED BY: MM					0938527		




Know what's **below. Call** before you dig.

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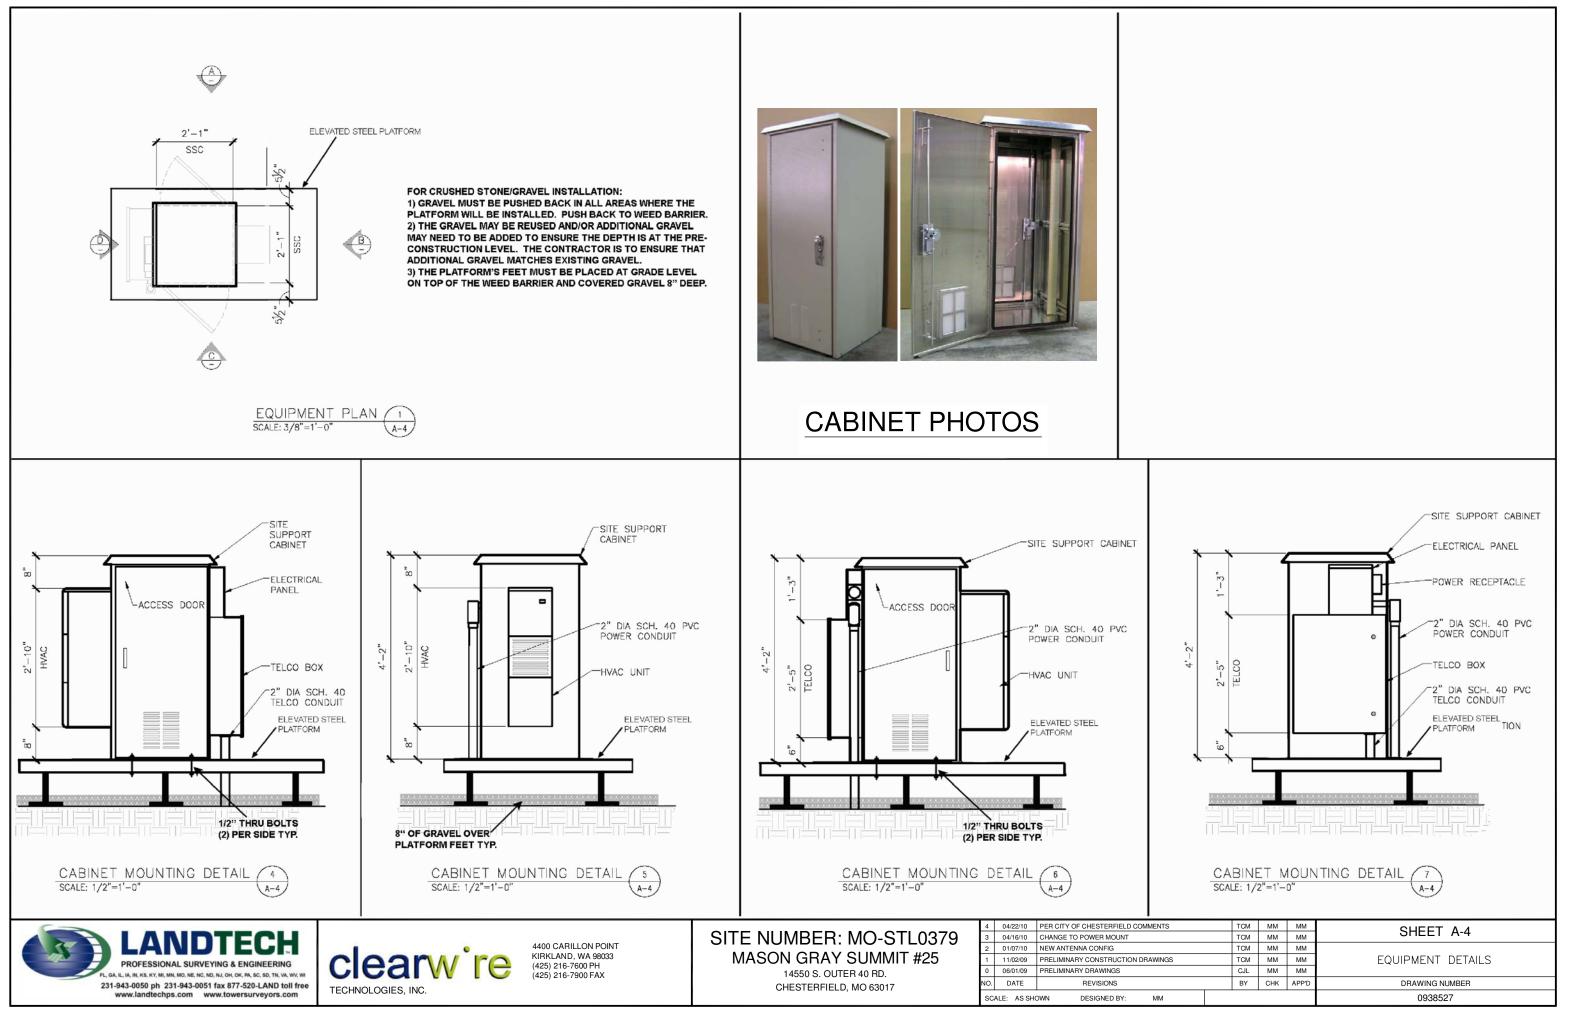
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MENTS	TCM	MM	MM	SHEET A-2
	TCM	MM	MM	
AWINGS	TCM TCM	MM	MM	ANTENNA MOUNTING DETAILS & NOTES
	CJL	MM	MM	
	BY	СНК	APP'D	DRAWING NUMBER
MM				0938527

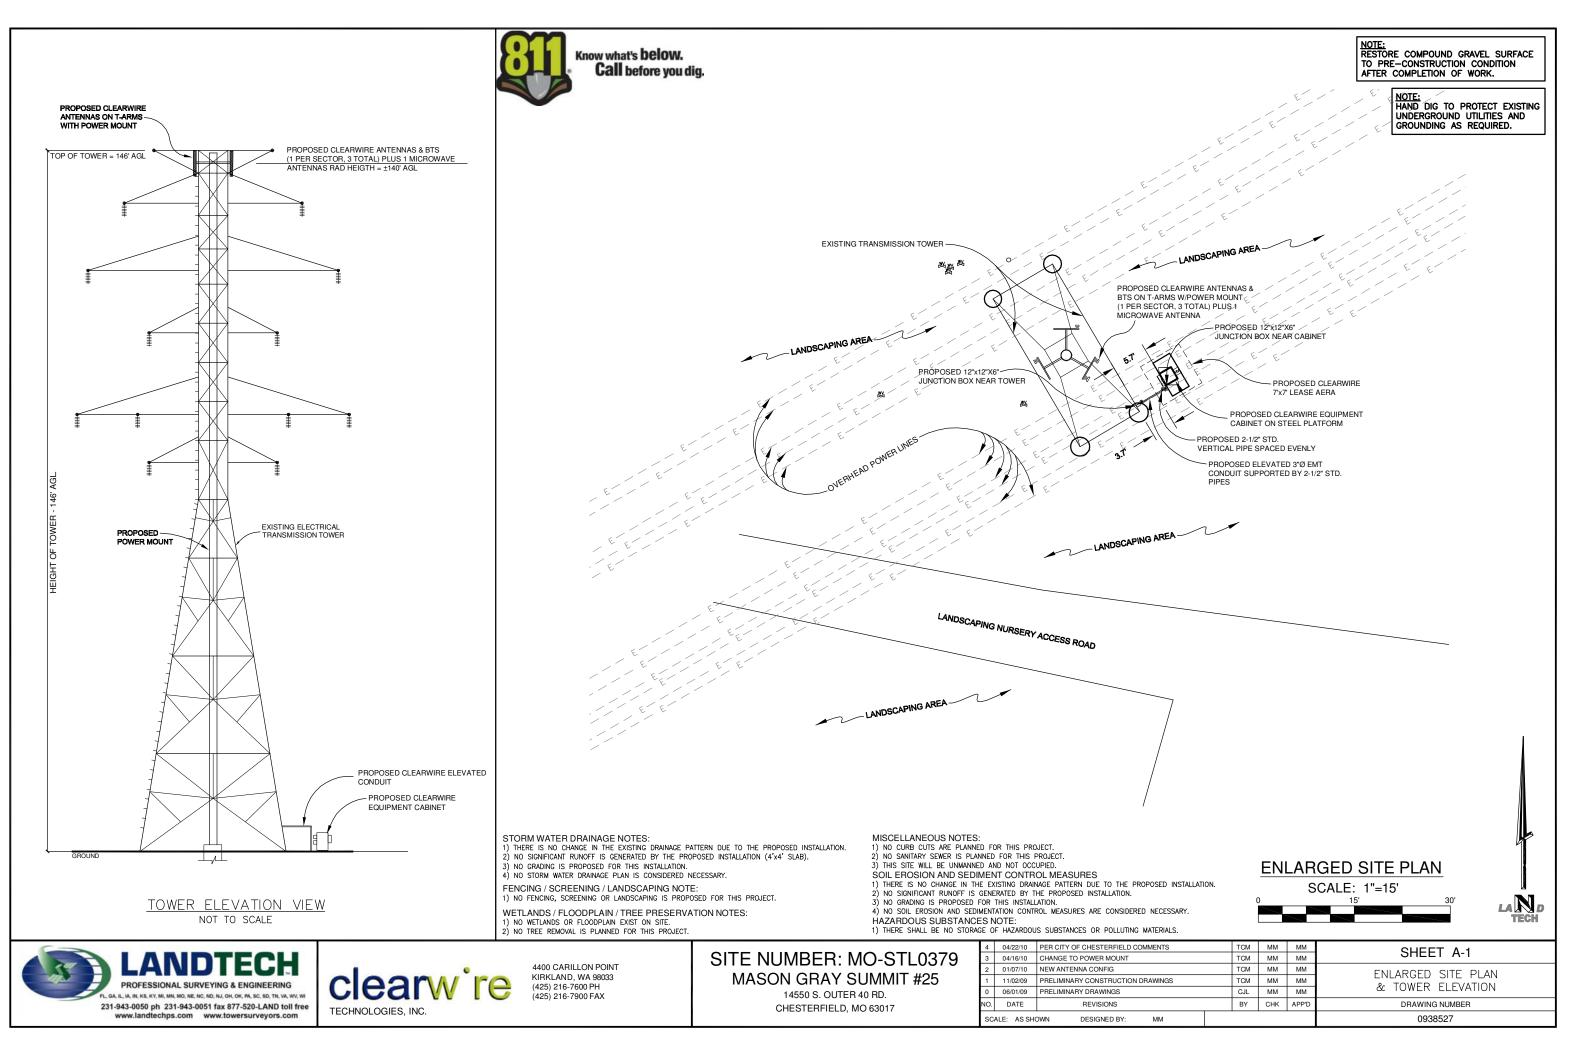

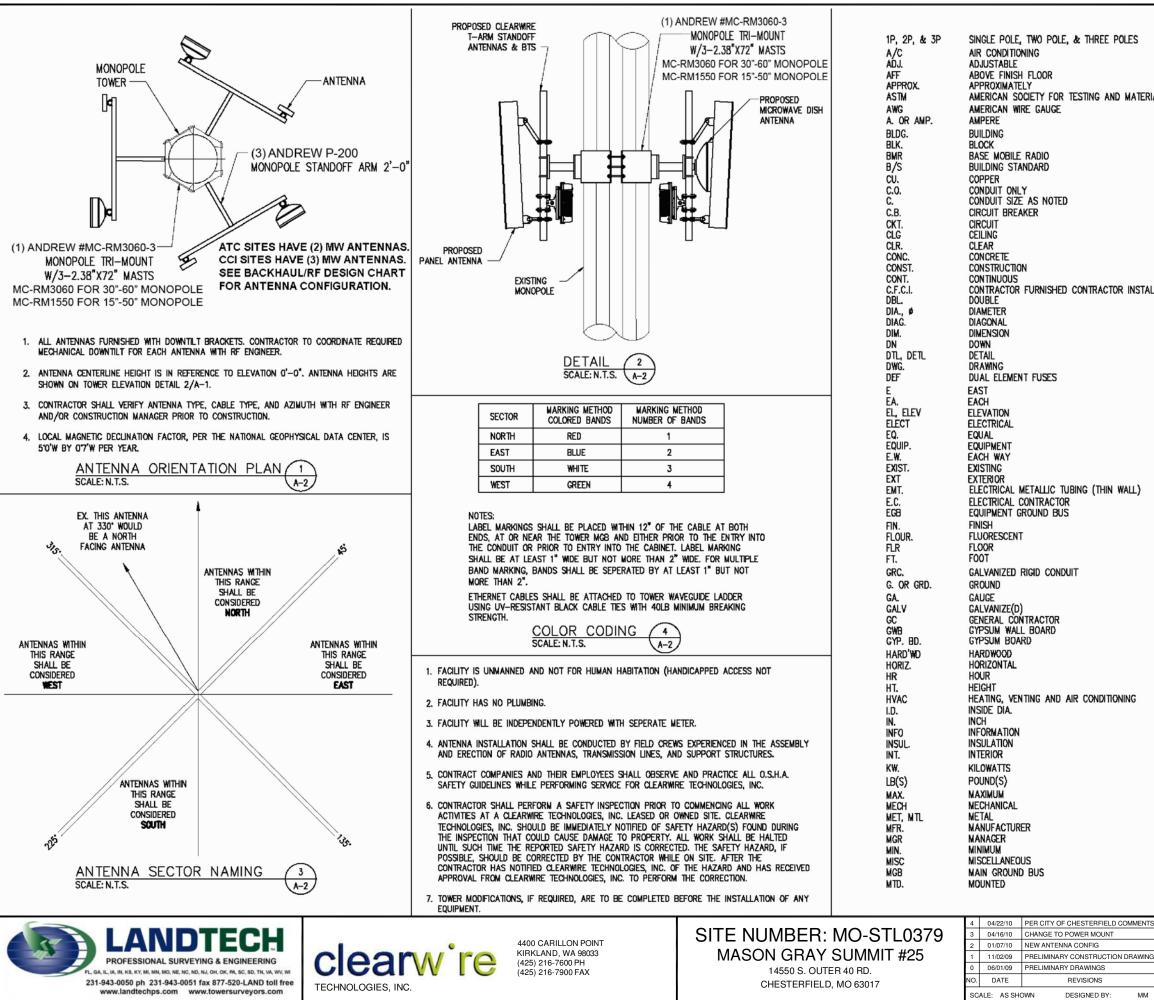GENERAL NOTES:

- 1. THE BASIC WIND SPEED UTILIZED FOR OUTDOOR EQUIPMENT CABINETS IS 90 MPH PER IBC (LATEST EDITION)
- 2. INFORMATION SHOWN ON THESE DRAWINGS WAS OBTAINED BY FIELD MEASUREMENTS. THE GENERAL CONTRACOTR SHALL VERIFY ALL EXISTING CONDITIONS AND NOTIFY THE ENGINEER OF ANY DISCREPANCIES PROOR TO ORDERING MATERIALS OR PROCEEDING WITH CONSTRUCTION.
- 3. THE GENERAL CONTRACTOR AND HIS SUBCONSULTANTS SHALL BE RESPONSIBLE FOR OBTAINING ALL PERMITS AND INSPECTIONS WHICH MAY BE REQUIRED FOR THE WORK.
- 4. STRUCTURAL STEEL SHALL CONFORM TO THE LATEST EDITION OF THE AISC SPECIFICATIONS FOR STRUCTURAL STEEL BUILDINGS, ALLOWABLE STRESS DESIGN AND PLASTIC DESIGN INCLUDING THE COMMENTARY AND THE AISC CODE OF STANDARD PRACTICE.
- 5. STRUCTURAL STEEL PLATES AND SHAPES SHALL CONFORM TO ASTM A36. ALL STRUCTURAL STEEL PIPES SHALL CONFORM TO ASTM A53 GRADE B. ALL STRUCTURAL STEEL TUBING SHALL CONFORM TO ASTM A500 GRADE B. ALL STRUCTURAL STEEL COMPONENTS AND FABRICATED ASSEMBLIES SHALL BE HOT DIP GALVINIZED AFTER FABRICATION.
- 6. WELDING SHALL BE IN ACCORDANCE WITH THE AMERICAN WELDING SOCIETY (AWS) D.1.1.96. STRUCTURAL WELDING CODE-STEEL WELD ELECTRODES SHALL BE E70XX. FIELD TOUCH-UP WITH ZINC RICH PAINT (ALL EXISTING AND NEW AREAS) AFTER WELDING IS COMPLETE.
- 7. ALL THREADED STRUCTURAL FASTEMERS FOR ANTENNA SUPPORT ASSEMBLIES SHALL CONFORM TO ASTM A307 OR ASTM A36. ALL STRUCTURAL FASTEMERS FOR STRUCTURAL STEEL FRAMING SHALL CONFORM TO ASTM A325. FASTEMERS SHALL BE 5/8" MIN. DUAMETER BEARING TYPE CONNECTIONS WITH THREADS EXCLUDED IN THE SHEAR PLANE. ALL EXPOSED FASTEMERS, NUTS, AND WASHERS SHALL BE GALVANIZED UNLESS NOTED OTHERWISE. CONCRETE EXPANSION ANCHORS SHALL BE HILTI KWIK BOLTS UNLESS NOTED OTHERWISE. ALL ANCHORS INTO CONCRETE SHALL BE STAINLESS STEEL.
- 8. All coaxial cable connectors and transmitter equipment shall be as specified by the owner and is not included in these construction documents. The contractor shall furnish all connection hardware required to secure the cables, ethernet cables shall be attached to the tower waveguide ladder using uv-resistant tie wraps or stainless steel hardware.
- 9. NORTH ARROW SHOWN ON PLANS REFERS TO TRUE NORTH. CONTRACTOR SHALL VERIFY NORTH AND INFORM ENGINEER ANY DISCREPANCY BEFORE STARTING CONSTRUCTION.
- 10. ALL REINFORCING STEEL SHALL CONFORM TO ASTM 615 GRADE 60, DEFORMED BILLET STEEL BARS.
- 11. CONCRETE FOR THE EQUIPMENT PAD SHALL BE 4000 PSI NORMAL WEIGHT CONCRETE WITH FIBERMESH ADMIXTURE. CONTRACTOR MAY USE APPROVED PRECAST EQUIVALENT.
- 12. LUMBER SHALL COMPLY WITH THE REQUIREMENTS OF AMERICAN INSTITUTE OF TIMBER CONSTRUCTION AND THE NATIONAL FOREST PRODUCTS ASSOCIATION'S NATIONAL DESIGN SPECIFICATION FOR WOOD CONSTRUCTION. ALL LUMBER SHALL BE PRESSURE TREATED AND SHALL BE STRUCTURAL GRADE NO. 2 OR BETTER.
- 13. IT IS THE OWNERS RESPONSIBILITY TO VERIFY THE STRUCTURAL CAPACITY OF THE EXISTING TOWER AND ITS FOUNDATION TO RESIST THE WIND/GRAVITY LOADS FROM THE PROPOSED ANTENNAS.
- 14. ALL FIELD CUT METAL WILL BE SCRAPED OF ANY RUST AND COLD GALVANIZED.
- 15. RUBBER CAPS WILL BE PLACED ON ALL EXPOSED UNISTRUT ENDS.

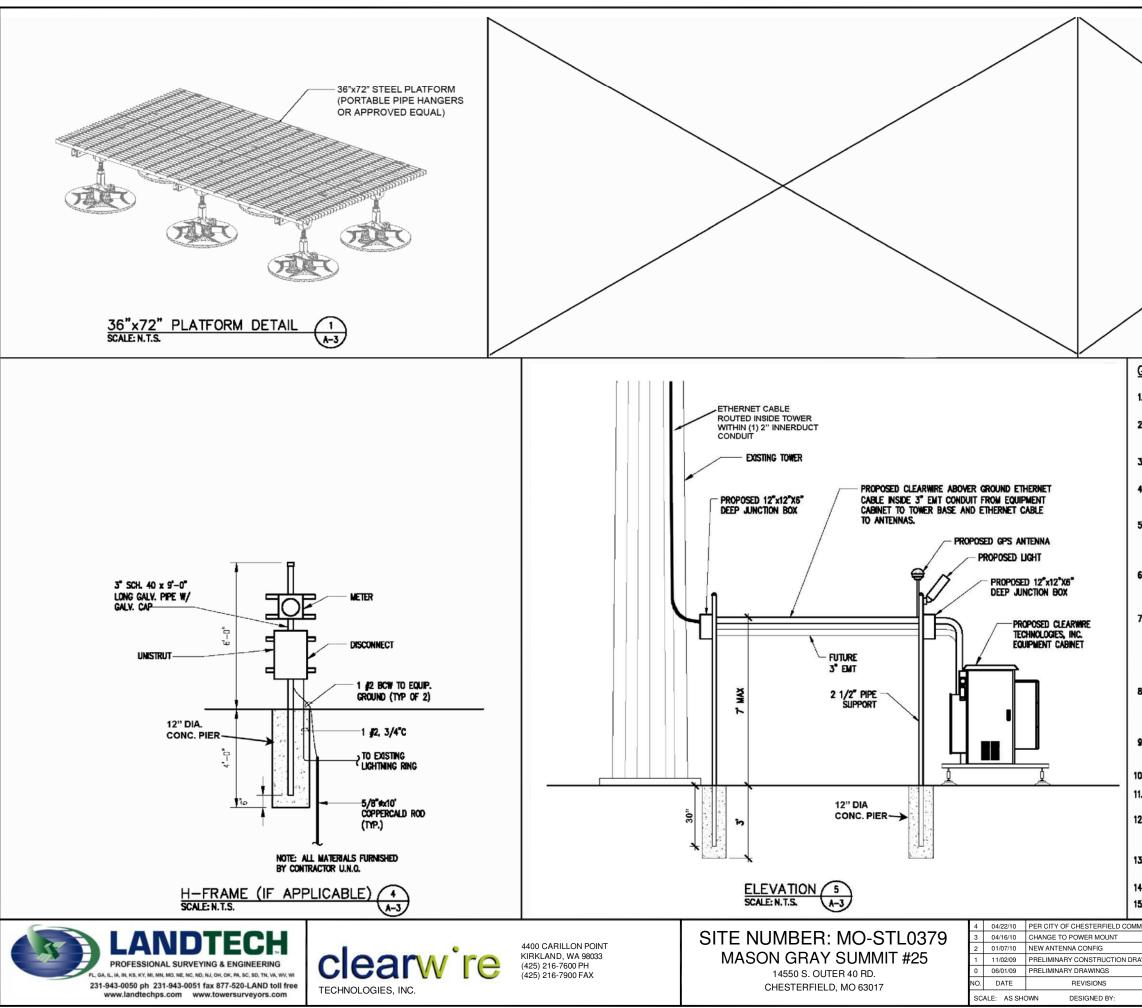TCM	MM	MM	SHEET A-3	
TCM	MM	MM	SHEET A-3	
TCM	MM	MM	STRUCTURAL NOTES.	
TCM	MM	MM	SECTIONS & DETAILS	
CJL	MM	MM	SECTIONS & DETAILS	
BY	CHK	APP'D	DRAWING NUMBER	
			0938527	
	TCM TCM TCM CJL	TCM MM TCM MM TCM MM CJL MM	TCM MM MM TCM MM MM TCM MM MM CJL MM MM	



MW ANTENNA SCHEDULE

CONTRACTOR TO INSTALL ANTENNAS AT CENTERLINE AND AZIMUTH AS SHOWN ON THE FINAL RF CONFIGURATION SHEET. CABLE ROUTING ON, IN, OR ABOUT SUPPORT STRUCTURES TO BE AS DETAILED IN THE STRUCTURAL ANALYSIS. THESE DOCUMENTS PROVIDED BY CLEARWIRE FIELD REPRESENTATIVE AT PRE-CONSTRUCTION WALK.

MW PATHS	STD MW CONFIG	ADDITIONAL/ALTERNATE MW
1	1 – VHLP1–23	N/A

*ANTENNA VHLP1 DIAMETER = 12" *ANTENNA VHLP2 DIAMETER = 26" *ANTENNA VHLP2.5 DIAMETER = 35"

RF ANTENNA SCHEDULE

CONTRACTOR TO INSTALL ANTENNAS AT CENTERLINE AND AZIMUTH AS SHOWN ON THE FINAL RF CONFIGURATION SHEET. CABLE ROUTING ON, IN, OR ABOUT SUPPORT STRUCTURES TO BE AS DETAILED IN THE STRUCTURAL ANALYSIS. THESE DOCUMENTS PROVIDED BY CLEARWIRE FIELD REPRESENTATIVE AT PRE-CONSTRUCTION WALK.

SECTOR	sector a (alpha)	SECTOR B (BETA)	SECTOR C (
RF MODEL	ARGUS LLPX310R	ARGUS LLPX310R	ARGUS LLP
RF AZIMUTH	15°	150°	270°



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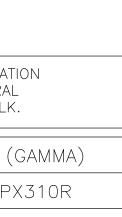
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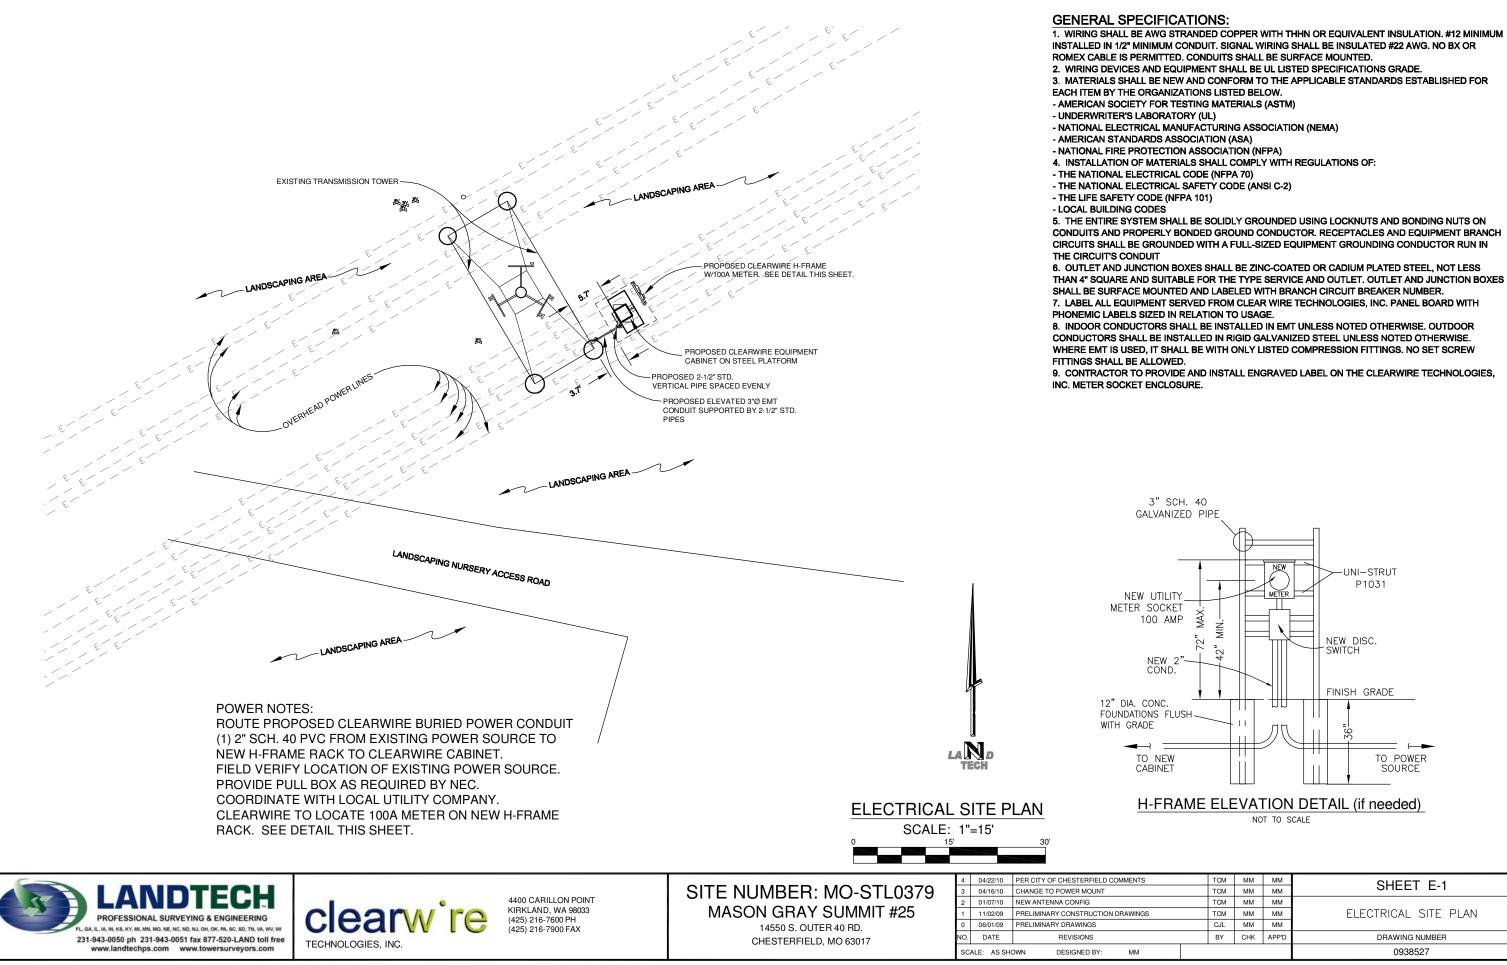
TECHNOLOGIES, INC.

SITE NUMBER: MO-STL0379 MASON GRAY SUMMIT #25 14550 S. OUTER 40 RD. CHESTERFIELD, MO 63017


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L	4	04/22/10	PER CITY OF CHESTERFIELD COMMENTS	TCM	MM	MM	SHEET A-5
	3	04/16/10	CHANGE TO POWER MOUNT	TCM	MM	MM	SHEET A-D
- [2	01/07/10	NEW ANTENNA CONFIG	TCM	MM	MM	
- [1	11/02/09	PRELIMINARY CONSTRUCTION DRAWINGS	TCM	MM	MM	MATERIAL LIST
ſ	0	06/01/09	PRELIMINARY DRAWINGS	CJL	MM	MM	
r	۷O.	DATE	REVISIONS	BY	СНК	APP'D	DRAWING NUMBER
SCALE: AS SHOWN DESIGNED BY: MM			·			0938527	

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MENTS	TCM	MM	MM	SHEET E-1
	TCM	MM	MM	SHEET E-T
	TCM	MM	MM	
AWINGS	TCM	MM	MM	ELECTRICAL SITE PLAN
	CJL	MM	MM	
	BY	СНК	APP'D	DRAWING NUMBER
MM				0938527



GROUNDING SPECIFICATIONS:

1. Grounding shall comply with article 250 of the national electrical code. 2. All grounding devices shall be U.L. Approved or listed for their intended use. 3. Ground wires shall be tinned #2 awg bare solid CJ unless noted otherwise.

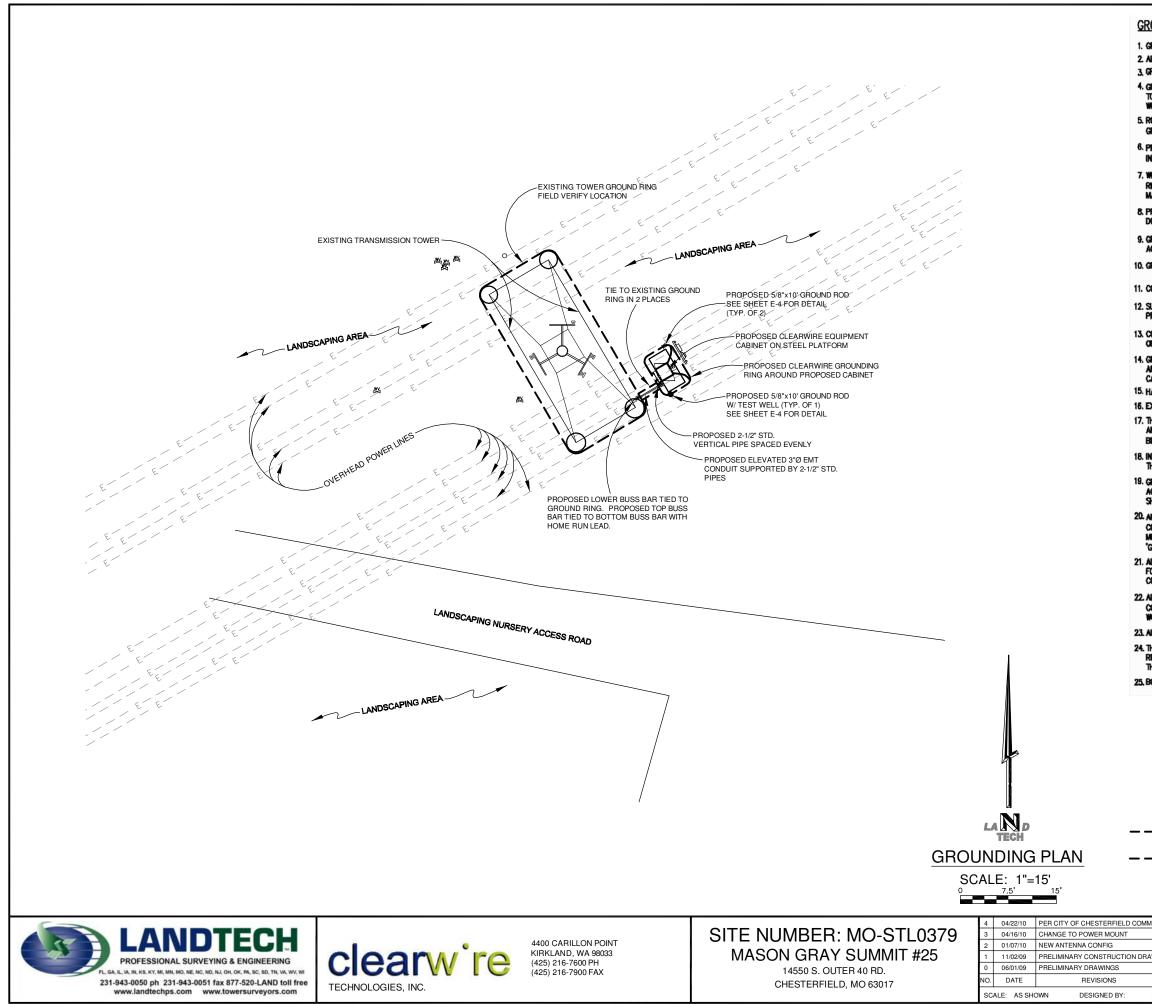4. GROUNDING CONNECTIONS SHALL BE EXOTHERMIC (CADWELD) UNLESS NOTED OTHERWISE. CLEAN SURFACES TO SHINEY NETAL. WHERE GROUND WIRES ARE CADWELDED TO GALVANIZED SURFACES. SPRAY CADWELD WITH GALVANIZING PAINT.

5. ROUTE GROUNDING CONDUCTORS ALONG THE SHORTEST AND STRAIGHTEST PATH POSSIBLE. BEND GROUNDING LEADS WITH A MINIMUM 8" RADIUS.

6. PRIOR TO INSTALLING LUGS ON GROUND WIRES, APPLY THOMAS & BETSS KOPR-SHELD (TM OF JET LUB INC.). PRIOR TO BOLTING GROUND WIRE LUGS TO GROUND BARS, APPLY KOPR-SHELD OR EQUAL.

 WHERE BARE COPPER GROUND WIRES ARE ROUTED FROM ANY CONNECTION ABOVE GRADE TO GROUND RING, INSTALL WIRE IN 3/4" PVC SLEEVE, FROM 1'-0" ABOVE GRADE AND SEAL TOP WITH SILICONE MATERIAL.

8. PREPARE ALL BONDING SURFACES FOR GROUNDING CONNECTIONS BY REMOVING ALL PAINT AND CORROSION DOWN TO SHINY NETAL. FOLLOWING CONNECTION, APPLY APPROPRIATE ANTI-OXIDIZATION PAINT.

9. GROUNDING WIRE CONNECTIONS SHALL BE 3-CRIMP C-TAP COMPRESSION TYPE. SPLIT BOLTS ARE NOT ACCEPTABLE.

10. GROUND RODS SHALL BE COPPER CLAD STEEL 5/8"x10' SPACED NOT LESS THAN 10' O.C.

11. CONNECTORS SHALL BE CRIMPED USING HYDRAULIC CRIMPING TOOLS.

 SURFACE CONNECTIONS SHALL BE MADE TO BARE METAL. PAINTED SURFACES SHALL BE FILED TO ENSURE PROPER CONTACT. APPLY NON-OXIDIZING AGENT TO CONNECTIONS.

13. COPPER BUSES SHALL BE CLEANED, POLISHED AND A NON-COOLDING AGENT APPLIED. NO FINGERPRINTS OR DISCOLORED COPPER WILL BE PERMITTED.

14. GROUNDING CONDUCTORS SHALL BE RUN THROUGH PVC SLEEVE WHERE ROUTED THROUGH WALLS, FLOORS, AND CEILING, ENDS OF CONDUIT SHALL BE GROUNDED. SEAL BOTH ENDS OF CONDUIT WITH SLICONE CAULK.

15. HARDWARE (I.E. NUTS, BOLTS, WASHERS, ETC.) IS TO BE STAINLESS STEEL.

16. EXOTHERMIC WELDS SHALL BE INSTALLED IN ACCORDANCE WITH MONUFACTURERS RECOMMENDATIONS

17. The entire system shall be solidly grounded using locknuts. And bonding nuts on conduits and properly bonded ground conductors. Receptacles and equipment branch circuits shall be grounded with a full sized equipment grounding conductor run in the circuit's conduit.

18. INSTALL GROUND BUSHINGS ON ALL METALLIC CONDUITS AND BOND TO THE EQUIPMENT GROUND BUS IN THE PANEL BOARD.

19. Ground Bars (sector, collector, master) shall be bare 1/4"X4" copper; large enough to accomodate the required number of ground connections. The hardware securing the migb shall electrically insulate the migb from any structure to which it is fastened.

20. APPLY T&B 'KOPR-SHIELD OR APPROVED EQUAL PRIOR TO MAKING MECHANICAL CONNECTIONS. CONNECTIONS SHALL BE MADE WITH STAINLESS STEEL BOLTS, NUTS AND LOCK WASHERS 3/8" DIAMETER MIN. WHERE GALVANIZING IS REMOVED FROM METEL IT SHALL BE PAINTED OR TOUCHED UP WITH 'GALVONG' OR EQUAL

21. ALL TERMINATIONS AT EQUIPMENT ENCLOSURES, PANELS, FRAMES OF EQUIPMENT AND WHERE EXPOSED FOR GROUNDING CONDUCTOR TERMINATION SHALL BE PERFORMED UTILIZING TWO HOLE BOLTED TONGUE COMPRESSION TYPE WITH STAINLESS STEEL SELF-TAPPING SCREWS.

22. ALL CLAMPS AND SUPPORTS USED TO SUPPORT THE GROUNDING SYSTEM CONDUCTORS AND PVC CONDUITS SHALL BE PVC TYPE (NON-CONDUCTIVE). DO NOT USE METAL BRACKETS OR SUPPORTS WHICH WOULD FORM A COMPLETE RING AROUND ANY GROUNDING CONDUCTOR.

23. ALL BOLTS, WASHERS AND NUTS USED ON GROUNDING CONNECTIONS SHALL BE STAINLESS STEEL

24. THE CONTRACTOR SHALL ENGAGE AN INDEPENDENT ELECTRICAL TESTING FIRM TO TEST AND VERIFY THAT RESISTANCE TO EARTH DOES NOT EXCEED 5.0 OHMS. PROVIDE A COPY OF TESTING REPORT, INCLUDING THE METHOD AND INSTRUMENTS USED TO VERIFY RESISTANCE TO CLEARWIRE REPRESENTATIVE. 25, BOND CABINET THROUGH THE MAIN GROUND BAR.

GROUNDING LEGEND

INSPECTION WELL

VERIFY LOCATION W/CONSTR. MGR.

%"x10' COPPER CLAD, STEEL GROUND ROD. USE EXOTHERMIC CONNECTION TO GROUND CABLE.

- - #2 SOLID COPPER TINNED BURIED

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BURIED GROUNDING CABLE TO CABLE CONNECTION USING EXOTHERMIC PROCESS.

ENTS		TCM	MM	MM	SHEET E-2
		TCM	MM	MM	
		TCM	MM	MM	
WINGS		TCM	MM	MM	GROUNDING PLAN
		CJL	MM	MM	
		BY	СНК	APP'D	DRAWING NUMBER
мм					0938527

