



690 Chesterfield Pkwy W • Chesterfield MO 63017-0760 Phone: 636-537-4000 • Fax 636-537-4798 • www.chesterfield.mo.us

Department of Planning & Public Works Public Hearing Summary Report

T.S.P. 20-2010 Clearwire US LLC. (14550 South Outer 40 Road): A request to obtain approval for a Telecommunication Facility Siting Permit for the location of antennas and equipment on an existing AmerenUE transmission tower in a "NU" Non-Urban District-zoned right-of-way located southeast of the US Highway 40 and Timberlake Manor interchange (19R540055).

Summary

The above-referenced project is a request for a Telecommunications Siting Permit (T.S.P.). If the request is approved, the Permit will allow placement of antennas from a new user, Clearwire US, on an existing AmerenUE transmission line tower located at 14550 South Outer 40 Road. Equipment to support the antennas is proposed to be placed at the base of the AmerenUE tower.

City of Chesterfield Ordinance 2391, which now governs telecommunications and facilities siting, requires a public hearing before the City of Chesterfield Planning Commission when a request is made for T.S.P. Please note, the Commission does not provide a recommendation to the City Council, but rather a list of issues generated during the hearing. City Council is the decision-making body for all requests for Telecommunications Siting Permits. A public hearing further addressing the request will be held at the June 14, 2010 City of Chesterfield Planning Commission meeting. Attached please find a copy of the Public Hearing Notice and an application packet detailing the Petitioner's request.

Respectfully submitted,

Shawn Seymour, AICP Senior Planner

Cc: Michael G. Herring, City Administrator Rob Heggie, City Attorney Michael O. Geisel, Director of Planning and Public Works Aimee Nassif, Planning and Development Services Director



Existing Structure

NOTICE OF PUBLIC HEARING CITY OF CHESTERFIELD PLANNING COMMISSION

NOTICE IS HEREBY GIVEN that the Planning Commission of the City of Chesterfield will hold a Public Hearing on Monday, June 14, 2010, at 7:00 PM, in the Council Chambers at the City Hall, 690 Chesterfield Parkway West, Chesterfield, Missouri 63017. Said hearing will be as follows:

T.S.P. 20-2010 Clearwire US LLC. (14550 South Outer 40 Road): A request to obtain approval for a Telecommunication Facility Siting Permit for the location of additional antennas and equipment on an existing AmerenUE transmission tower in a "NU" Non-Urban District-zoned right-of-way located southeast of the US Highway 40 and Timberlake Manor interchange (19R540055).



Anyone interested in the proceedings will be given an opportunity to be heard. Copies of the request are available for review in the Department of Planning and Public Works at the Chesterfield City Hall, 690 Chesterfield Parkway West during weekdays between the hours of 8:30 a.m. and 4:30 p.m. If you should need additional information about this project, please contact Mr. Shawn P. Seymour, Senior Planner, by telephone at 636-537-4741 or by email at sseymour@chesterfield.mo.us


CITY OF CHESTERFIELD Maurice L. Hirsch, Jr., Chair Chesterfield Planning Commission

Description of Area

Part of Lot 2 of the Subdivision of land of Samuel Conway, deceased, in partition in U.S. Survey 366 and Section 13 and 14, Township 45 North, Range 4 East, in St. Louis County, Missouri, according to the Plat thereof recorded in Plat Book 9 Page 77 of the St. Louis City (former County) Records.


MO-STL0379 Coverage Analysis



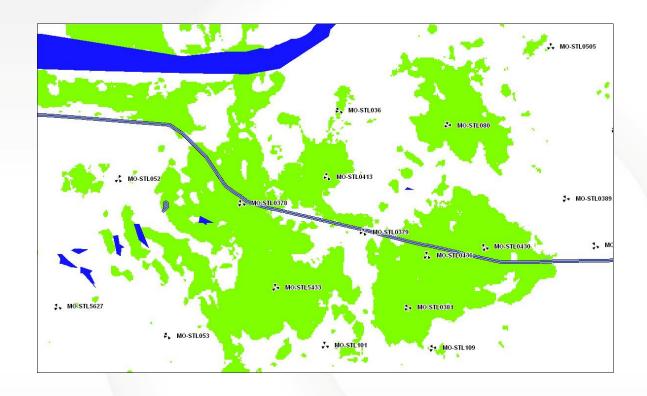

Indoor Coverage without MO-STL0379



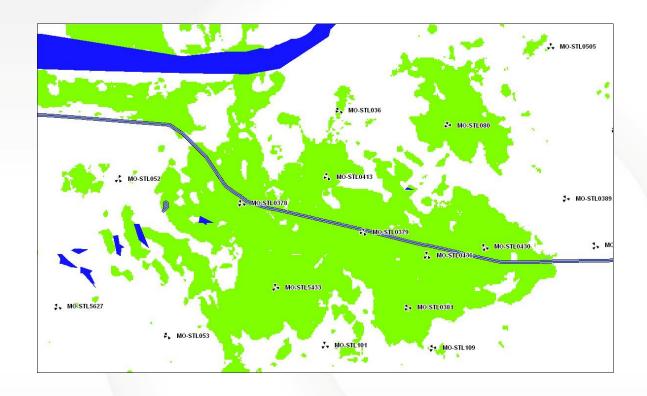

Indoor Coverage with MO-STL0379



CLEARWIRE PROJECT MANAGEMENT	DATE
CLEARWIRE CONSTRUCTION MANAGEMENT	DATE
CLEARWIRE ENGINEERING	DATE
BACKHAUL ENGINEERING	DATE
LANDLORD	DATE



SITE ID: MO-STL0379

MASON GRAY SUMMIT #25



DRAWING INDEX

- T-1 TITLE SHEET S-1 PARCEL PLAN
- S-2 CROSS SECTIONS
- A-1 **ENLARGED SITE PLAN & TOWER ELEVATION**
- A-2 ANTENNA MOUNTING DETAILS & NOTES
- A-3 STRUCTURAL NOTES, SECTIONS & DETAILS
- A-4 **EQUIPMENT DETAILS**
- RF / BACKHAUL CINFIG A-5
- E-1 **ELECTRICAL PLAN**
- E-2 GROUNDING PLAN
- E-3 **ELECTRICAL DETAILS**
- E-4 **GROUNDING DETAILS & NOTES**
- **GROUNDING ANTENNA DETAILS**

CODE COMPLIANCE

ALL WORK AND MATERIALS SHALL BE PERFORMED AND INSTALLED IN ACCORDANCE WITH THE CURRENT EDITIONS OF THE FOLLOWING CODES AS ADOPTED BY THE LOCAL GOVERNING AUTHOR/TIES. MOTHING IN THESE PLANS IS TO BE CONSTRUED TO PERMIT WORK NOT ORMING TO THE LATEST EDITIONS OF THE FOLLOWING CODES

1 IBC 2003

6. LOCAL BUILDING CODE

3 IRC 2003

8 JECC 2003 (2003 JEC)

9, INTERNATIONAL EXISTING BUILDING CODE 2003

SITE QUALIFICATION PARTICIPANTS

NAME

COMPANY

MATTHEW MOKANYK, P.E. SAC RUSSELL BEEN

JASON GIBBS

LANDTECH CELLECTIVE SOLUTIONS, LLC

CLEARWIRE

CON AMY ISENBURG TIM WEBERS

AMEREN

CLEARWIRE amv.isenburo@clearwire.com

314-554-2993

NUMBER

231-943-0050


314-989-9810

LANDTECH PROFESSIONAL SURVEYING AND ENGINEERING 1275 McGREGOR WAY GRAWN, MI 49637 P.O. BOX 193

PHONE: (231) 943-0050

LANDTECH PROFESSIONAL SURVEYING AND ENGINEERING 1275 McGREGOR WAY GRAWN, MI 49637 P.O. BOX 193 PHONE: (231) 943-0050

DIRECTIONS TO SITE:
FROM LAMBERT INTERNATIONAL AIRPORT: TAKE I-70 WESTBOUND, TAKE I-270 EXIT SOUTH TO THE HWY 40 / I-84 WEST EXIT. PROCEED TO THE TIMBERLAKE MANOR EXIT AND TURN LEFT AT THE STOPLIGHT. THE AMEREN TOWER IS TO YOUR LEFT.

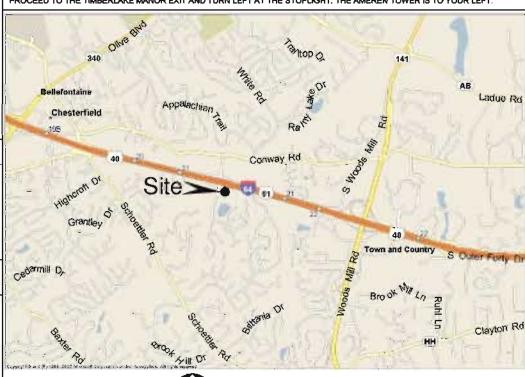



VICINITY MAP

SITE NUMBER: MO-STL0379 MASON GRAY SUMMIT #25

CHESTERFIELD, MO 63017

CONTACT. AMY ISENBURG

MISSOURI

PROJECT INFORMATION

THIS FACILITY IS AN UNOCCUPIED TELECOMMUNICATIONS FACILITY CONSISTING OF CO-LOCATING ON AN EXISTING TRANSMISSION TOWER WITH MICROWAVE ANTENNAS AND THE INSTALLATION OF NEW OUTDOOR EQUIPMENT ON GRADE.

SITE ADDRESS.

14550 S. OUTER 40 RD. CHESTERFIELD, MO 63017

TOWER OWNER: **AMEREN**

P.O. BOX 66529 ST. LOUIS, MO 63166

TOWER OWNER SITE#

MASON GRAY SUMMIT #25

APPLICANT¹

CLEARWIRE

4400 CARILLON POINT

KIRKLAND, WA 98033

(425) 216-7600 PH

(425) 216-7900 FAX

TOWER INFORMATION.

(LATITUDE & LONGITUDE BASED ON NAD1983)

LATITUDE: 38° 38' 45,4" N LONGITUDE: 90° 31' 46.5" W


PROPOSED RAD CENTER HEIGHT: 140' AGL.

PARCEL NUMBER (TAX I.D.)* 19R540055

FPNU COMMERCIAL

TYPE OF CONSTRUCTION

PROJECT TYPE: EXISTING TRANSMISSION TOWER

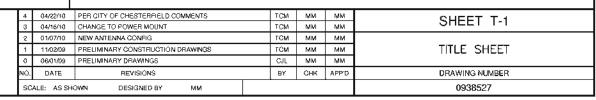

RF





4400 CARILLON POINT KIRKLAND WA 98033 (425) 216-7600 PH

14550 S. OUTER 40 RD.

LAND OWNER:

40-TIMBERLAKE SE LLC 36 BRIARCLIFF STREET ST. LOUIS, MO 63124

TOWER OWNER:

P.O. BOX 66529 ST. LOUIS, MO 63166

ZONING:

SUBJECT SITE: FPNU COMMERCIAL NORTH OF SITE: HIGHWAY SOUTH OF SITE: NU RESIDENTIAL EAST OF SITE: R3 RESIDENTIAL WEST OF SITE: HIGHWAY


AREA DATA:


PARENT PARCEL AREA: 8.71 ACRES LEASE AREA: 49 SQ.FT. AREA OF CONSTRUCTION: 49 SQ.FT.

PARENT PARCEL DESCRIPTION

Part of Lot 2 of the Subdivision of land of Samuel Conway, deceased, in partition in U.S. Survey 366 and Sections 13 and 14, Township 45 North, Range 4 East, in St. Louis County, Missouri, according to the Plat thereof recorded in Plat Book 9 Page 77 of the St. Louis City (former County) Records, being described as:

Beginning at a railroad spike at the intersection of the South line of T.R. Highway No. 40 with the West line of said Lot 2, thence South 4 degrees 35-1/2 minutes West 439.38 feet, thence South 14 degrees 58 minutes East 152.33 feet; thence South 64 degrees 18 minutes East 27.72 feet, thence North 14 degrees 54 minutes East 84.10 feet, thence North 35 degrees 25 minutes West 57.80 feet, thence North 83 degrees 6 minutes East 65.62 feet, thence South 65 degrees 54 minutes East 155.03 feet, thence North 89 degrees 19 minutes East 47.49 feet, thence North 73 degrees 22 minutes East 50.63 feet, thence South 49 degrees 51 minutes East 47.50feet, thence South 14 degrees 51 minutes West 144.90 feet, thence South 13 degrees 28 minutes East 33.81 feet, thence South 74 degrees 10 minutes East 80.14 feet, thence South 87 degrees 17 minutes East 205 feet, thence North 22 degrees 19 minutes East 24.28 feet, thence North 85 degrees 53 minutes East 248 feet to an old iron stone at the Northeast corner of Lot 4 of said Subdivision, thence North 4 degrees 7 minutes West to the South line of said T.R. Highway No. 40, thence North 76 degrees 46 minutes West along the South line of said Highway a distance of 856.43 feet, more or less, to the point of beginning, according to Survey made by Elbring Surveying Company during the Month of April, 1960, EXCEPTING THEREFROM that part thereof condemned for new right-of-way T.R. Highway No. 40, in Condemnation Suit No. 276693 in the Circuit Court of St. Louis County, Missouri.

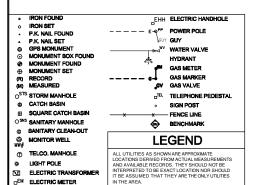

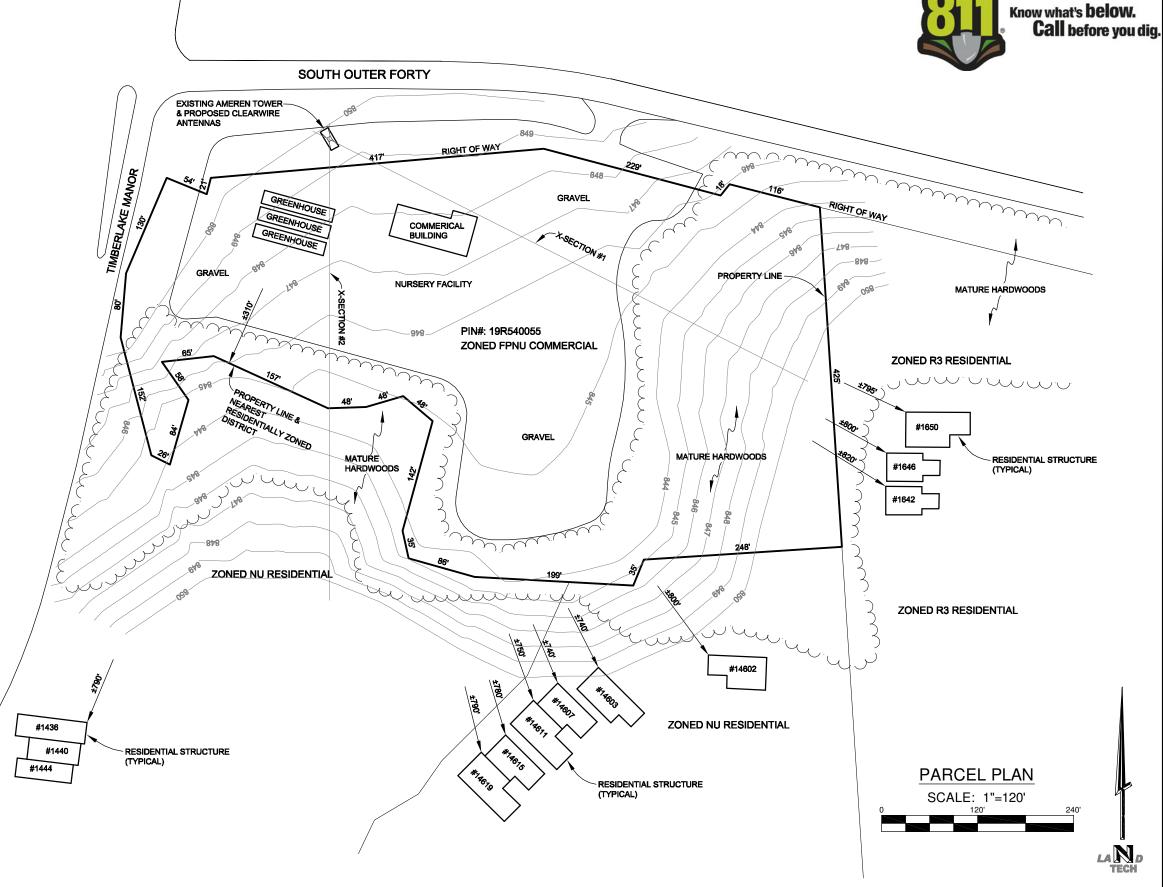





KIRKLAND WA 98033 (425) 216-7600 PH

SITE NUMBER: MO-STL0379 MASON GRAY SUMMIT #25 14550 S. OUTER 40 RD.

CHESTERFIELD, MO 63017

	4	04/22/10	PER CITY OF CHESTERFIELD COMMENTS	TCM	MM	MM	SHEET S-1
	3	04/16/10	CHANGE TO POWER MOUNT	TCM	MM	MM	SHEET 3-1
	2	01/07/10	NEW ANTENNA CONFIG	TCM	MM	MM	
	1	11/02/09	PRELIMINARY CONSTRUCTION DRAWINGS	TCM	MM	MM	PARCEL PLAN
-	0	06/01/09	PRELIMINARY DRAWINGS	CJL	MM	MM	
-	NO.	DATE	REVISIONS	BY	СНК	APP'D	DRAWING NUMBER
	SCALE: AS SHOWN DESIGNED BY: MM					0938527	

LAND OWNER:

40-TIMBERLAKE SE LLC 36 BRIARCLIFF STREET ST. LOUIS, MO 63124

TOWER OWNER:


AMEREN P.O. BOX 66529 ST. LOUIS, MO 63166


ZONING:


SUBJECT SITE: FPNU COMMERCIAL NORTH OF SITE: HIGHWAY SOUTH OF SITE: NU RESIDENTIAL EAST OF SITE: R3 RESIDENTIAL WEST OF SITE: HIGHWAY

AREA DATA:

PARENT PARCEL AREA: 8.71 ACRES LEASE AREA: 49 SQ.FT. AREA OF CONSTRUCTION: 49 SQ.FT.

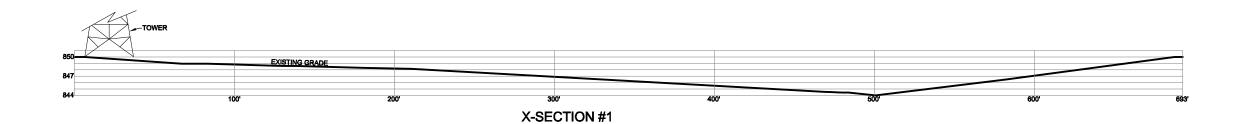

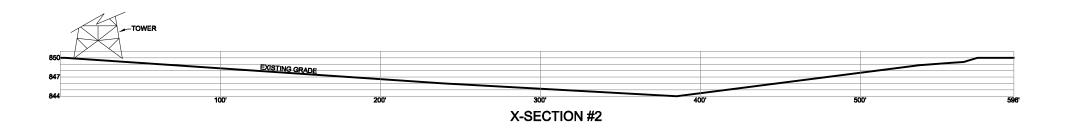

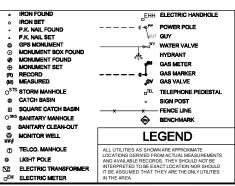

CROSS SECTIONS

HORIZONTAL SCALE: 1"=60' VERTICAL SCALE: 1"=15'





4400 CARILLON POINT KIRKLAND, WA 98033 (425) 216-7600 PH

SITE NUMBER: MO-STL0379 MASON GRAY SUMMIT #25

011 011/11 00	
14550 S. OUTER 40	RD.
CHESTERFIELD, MO	63017

Ι	4	04/22/10	PER CITY OF CHESTERFIELD COMMENTS	TCM	MM	MM	SHEET S-2
L	3	04/16/10	CHANGE TO POWER MOUNT	TCM	MM	MM	SHEET 3-2
L	2	01/07/10	NEW ANTENNA CONFIG	TCM	MM	MM	
	1	11/02/09	PRELIMINARY CONSTRUCTION DRAWINGS		MM	MM	CROSS SECTIONS
I	0	06/01/09	1/09 PRELIMINARY DRAWINGS		MM	MM	
ľ	10.	D. DATE REVISIONS		BY	CHK	APP'D	DRAWING NUMBER
SCALE: AS SHOWN DESIGNED BY: MM						0938527	

Know what's **below**.

Call before you dig.


TOWER ELEVATION VIEW NOT TO SCALE

www.landtechps.com www.towersurveyors.com

Know what's **below**. Call before you dig.

NOTE: RESTORE COMPOUND GRAVEL SURFACE TO PRE-CONSTRUCTION CONDITION AFTER COMPLETION OF WORK.

NOTE: HAND DIG TO PROTECT EXISTING UNDERGROUND UTILITIES AND GROUNDING AS REQUIRED.

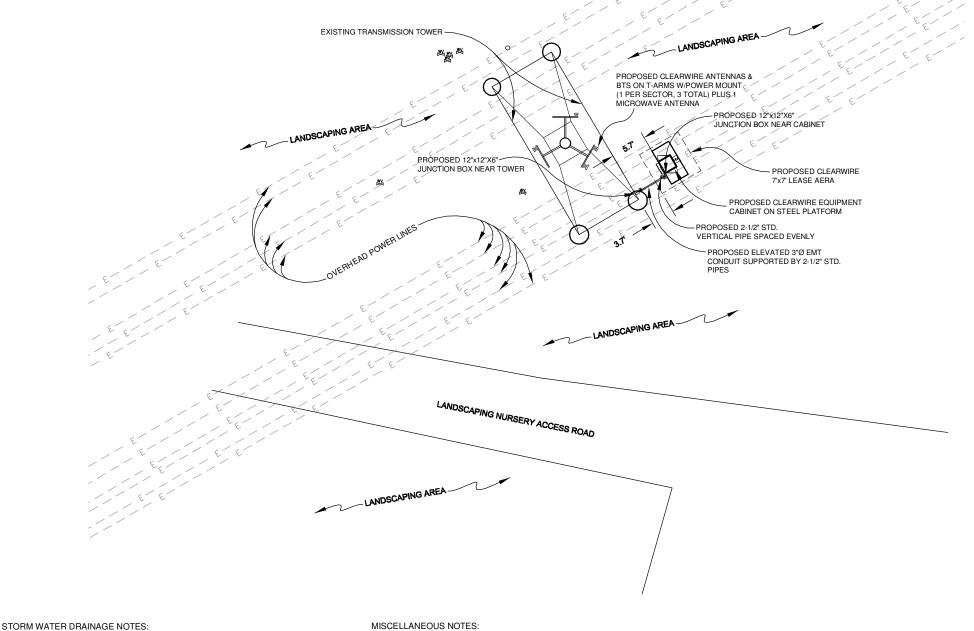

1) THERE IS NO CHANGE IN THE EXISTING DRAINAGE PATTERN DUE TO THE PROPOSED INSTALLATION.
2) NO SIGNIFICANT RUNOFF IS GENERATED BY THE PROPOSED INSTALLATION (4'x4' SLAB).

3) NO GRADING IS PROPOSED FOR THIS INSTALLATION.

4) NO STORM WATER DRAINAGE PLAN IS CONSIDERED NECESSARY.

FENCING / SCREENING / LANDSCAPING NOTE: 1) NO FENCING, SCREENING OR LANDSCAPING IS PROPOSED FOR THIS PROJECT.

WETLANDS / FLOODPLAIN / TREE PRESERVATION NOTES:

NO WETLANDS OR FLOODPLAIN EXIST ON SITE.
 NO TREE REMOVAL IS PLANNED FOR THIS PROJECT.

4400 CARILLON POINT KIRKLAND, WA 98033

(425) 216-7600 PH

MISCELLANEOUS NOTES:

NO CURB CUTS ARE PLANNED FOR THIS PROJECT.
 NO SANITARY SEWER IS PLANNED FOR THIS PROJECT.

2) NO SANITARY SEWER IS PLANNED FOR THIS PROJECT.
3) THIS STEE WILL BE UNMANNED AND NOT OCCUPIED.
SOIL EROSION AND SEDIMENT CONTROL MEASURES
1) THERE IS NO CHANGE IN THE EXISTING DRAINAGE PATTERN DUE TO THE PROPOSED INSTALLATION.
2) NO SIGNIFICANT RUNOFF IS GENERATED BY THE PROPOSED INSTALLATION.
3) NO GRADING IS PROPOSED FOR THIS INSTALLATION.

4) NO SOIL EROSION AND SEDIMENTATION CONTROL MEASURES ARE CONSIDERED NECESSARY.

HAZARDOUS SUBSTANCES NOTE:

1) THERE SHALL BE NO STORAGE OF HAZARDOUS SUBSTANCES OR POLLUTING MATERIALS.






SITE NUMBER: MO-STL0379 MASON GRAY SUMMIT #25

14550 S. OUTER 40 RD. CHESTERFIELD, MO 63017


I	4	04/22/10	PER CITY OF CHESTERFIELD COMMENTS	TCM	MM	MM	SHEET A-1
I	3	04/16/10	CHANGE TO POWER MOUNT	TCM	MM	MM	SHEET A-T
I	2	01/07/10	NEW ANTENNA CONFIG	TCM	MM	MM	ENLARGED SITE PLAN
I	1	11/02/09	PRELIMINARY CONSTRUCTION DRAWINGS	TCM	MM	MM	& TOWER FLEVATION
I	0	06/01/09	PRELIMINARY DRAWINGS	CJL	MM	MM	& IUWER ELEVATION
Ī	NO.	DATE	REVISIONS	BY	СНК	APP'D	DRAWING NUMBER
	SCALE: AS SHOWN DESIGNED BY: MM						0938527


ENLARGED SITE PLAN

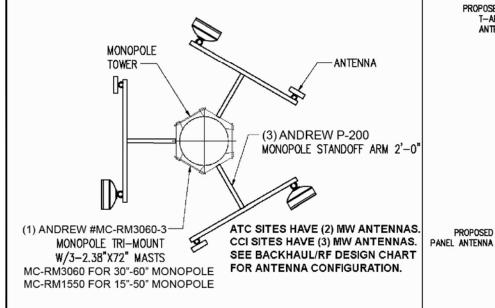

- 1. ALL ANTENNAS FURNISHED WITH DOWNTILT BRACKETS. CONTRACTOR TO COORDINATE REQUIRED MECHANICAL DOWNTILT FOR EACH ANTENNA WITH RF ENGINEER.
- 2. ANTENNA CENTERLINE HEIGHT IS IN REFERENCE TO ELEVATION 0'-0". ANTENNA HEIGHTS ARE SHOWN ON TOWER ELEVATION DETAIL 2/A-1.
- 3. CONTRACTOR SHALL VERIFY ANTENNA TYPE, CABLE TYPE, AND AZIMUTH WITH RF ENGINEER AND/OR CONSTRUCTION MANAGER PRIOR TO CONSTRUCTION.
- 4. LOCAL MAGNETIC DECLINATION FACTOR, PER THE NATIONAL GEOPHYSICAL DATA CENTER, IS 5'0'W BY 07'W PER YEAR.



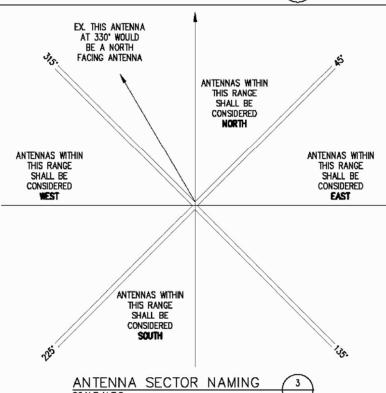

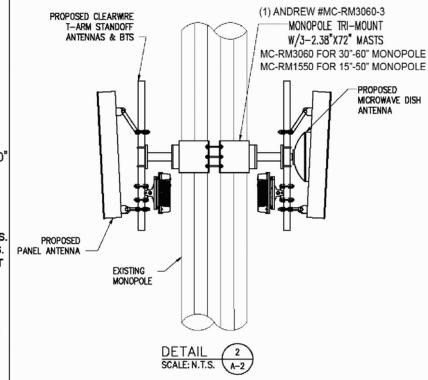

SECTOR	MARKING METHOD COLORED BANDS	MARKING METHOD NUMBER OF BANDS
NORTH	RED	1
EAST	BLUE	2
SOUTH	WHITE	3
WEST	GREEN	4

LABEL MARKINGS SHALL BE PLACED WITHIN 12" OF THE CABLE AT BOTH ENDS, AT OR NEAR THE TOWER MGB AND EITHER PRIOR TO THE ENTRY INTO THE CONDUIT OR PRIOR TO ENTRY INTO THE CABINET. LABEL MARKING SHALL BE AT LEAST 1" WIDE BUT NOT MORE THAN 2" WIDE. FOR MULTIPLE BAND MARKING, BANDS SHALL BE SEPERATED BY AT LEAST 1" BUT NOT

ETHERNET CABLES SHALL BE ATTACHED TO TOWER WAVEGUIDE LADDER USING UV-RESISTANT BLACK CABLE TIES WITH 40LB MINIMUM BREAKING

SCALE: N.T.S.

- 1. FACILITY IS UNMANNED AND NOT FOR HUMAN HABITATION (HANDICAPPED ACCESS NOT REQUIRED).
- 2, FACILITY HAS NO PLUMBING.
- 3. FACILITY WILL BE INDEPENDENTLY POWERED WITH SEPERATE METER.
- 4. ANTENNA INSTALLATION SHALL BE CONDUCTED BY FIELD CREWS EXPERIENCED IN THE ASSEMBLY AND ERECTION OF RADIO ANTENNAS, TRANSMISSION LINES, AND SUPPORT STRUCTURES.
- 5. CONTRACT COMPANIES AND THEIR EMPLOYEES SHALL OBSERVE AND PRACTICE ALL O.S.H.A. SAFETY GUIDELINES WHILE PERFORMING SERVICE FOR CLEARWIRE TECHNOLOGIES, INC.
- 6. CONTRACTOR SHALL PERFORM A SAFETY INSPECTION PRIOR TO COMMENCING ALL WORK ACTIVITIES AT A CLEARWIRE TECHNOLOGIES, INC. LEASED OR OWNED SITE. CLEARWIRE TECHNOLOGIES, INC. SHOULD BE IMMEDIATELY NOTIFIED OF SAFETY HAZARD(S) FOUND DURING THE INSPECTION THAT COULD CAUSE DAMAGE TO PROPERTY. ALL WORK SHALL BE HALTED UNTIL SUCH TIME THE REPORTED SAFETY HAZARD IS CORRECTED. THE SAFETY HAZARD, IF POSSIBLE, SHOULD BE CORRECTED BY THE CONTRACTOR WHILE ON SITE, AFTER THE CONTRACTOR HAS NOTIFIED CLEARWIRE TECHNOLOGIES, INC. OF THE HAZARD AND HAS RECEIVED APPROVAL FROM CLEARWIRE TECHNOLOGIES, INC. TO PERFORM THE CORRECTION.
- 7. TOWER MODIFICATIONS, IF REQUIRED, ARE TO BE COMPLETED BEFORE THE INSTALLATION OF ANY EQUIPMENT.

1P, 2P, & 3P	SINGLE POLE, TWO POLE, & THREE POLES	NEU'	T.	NEUTRAL
A/C	AIR CONDITIONING	N		NORTH
ADJ.	ADJUSTABLE	NA		NOT APPLICABLE
AFF	ABOVE FINISH FLOOR	NIC		NOT IN CONTRACT
		NTS		NOT TO SCALE
APPROX.	APPROXIMATELY			OWNER FURNISHED, CONTRACTOR INSTALLED
ASTM	AMERICAN SOCIETY FOR TESTING AND MATER			ON CENTER
AWG	AMERICAN WIRE GAUGE	OC,	0/c	
A. OR AMP.	AMPERE	OD		OUTSIDE DIAMETER
BLDG.	BUILDING	OPG.		OPENING
BLK.	BLOCK	OPP		OPPOSITE
		OHT	/OHP	OVERHEAD TELEPHONE/OVERHEAD POWER
BMR	BASE MOBILE RADIO	OHP		OVERHEAD POWER
B/S	BUILDING STANDARD	OHT		OVERHEAD TELEPHONE
CU.	COPPER	PVC.		SCHEDULE 40 PLASTIC CONDUIT.
C.O.	CONDUIT ONLY	PLY		PLYWOOD
C.	CONDUIT SIZE AS NOTED		MD.	
C.B.	CIRCUIT BREAKER	PR		PAIR
CKT.	CIRCUIT	PRO		PROJECT
CLG	CEILING	PRO	P	PROPERTY
CLR.		PT		PRESSURE TREATED
	CLEAR	RECE	PT.	RECEPTACLE
CONC.	CONCRETE	REQ'	'n	REQUIRED
CONST.	CONSTRUCTION	RM	=	ROOM
CONT.	CONTINUOUS	D.O.		ROUGH OPENING
C.F.C.I.	CONTRACTOR FURNISHED CONTRACTOR INSTA			
DBL.	DOUBLE	S		SOUTH
DIA., Ø	DIAMETER	SW.		SWITCH
DIAG.	DIAGONAL	SHT		SHEET
DIM.	DIMENSION	SIM.		SIMILAR
DN	DOWN	SPEC	C.	SPECIFICATION
DTL, DETL	DETAIL	SQ.		SQUARE
DWG.	DRAWING	SS		STAINLESS STEEL
		STL		STEEL
DEF	DUAL ELEMENT FUSES	STRU		STRUCTURAL
E	EAST	SUSI		SUSPENDED
EA.	EACH			SHEET VINYL
EL, ELEV	ELEVATION	S.V.		
ELECT	ELECTRICAL	THRU		THROUGH
EQ.	EQUAL	TNNI		TINNED
EQUIP.	EQUIPMENT	T.0.0		TOP OF CONCRETE
E.W.	EACH WAY	T.O.T	W.	TOP OF MASONRY
		TYP		TYPICAL
EXIST.	EXISTING	U.O.I	N.	UNLESS OTHERWISE NOTED
EXT	EXTERIOR	UBC		UNIFORM BUILDING CODE
EMT.	ELECTRICAL METALLIC TUBING (THIN WALL)	UGP		UNDERGROUND POWER
E.C.	ELECTRICAL CONTRACTOR			
EGB	EQUIPMENT GROUND BUS	UGT		UNDERGROUND TELEPHONE
FIN.	FINISH	VERT	l.	VERTICAL
FLOUR.	FLUORESCENT	VIF		VERIFY IN FIELD
FLR	FLOOR	VT		MNYL TILE
FT.	FOOT	W		WEST
		W/		WITH
GRC.	GALYANIZED RIGID CONDUIT	WIN		WINDOW
G. OR GRD.	GROUND	W/0		WITHOUT
GA.	GAUGE	W.		WATTS
GALV	GALVANIZE(D)			
GC	GENERAL CONTRACTOR	W.P.		WEATHERPROOF
GWB	GYPSUM WALL BOARD	XFMF	₹	TRANSFORMER
GYP. BD.	GYPSUM BOARD			
			孝 − ANGLE	
HARD' W D	HARDWOOD			
HORIZ.	HORIZONTAL		& - AND	
HR	HOUR		G — CENTE	RINE
HT.	HEIGHT		d origin	IN LINE
HVAC	HEATING, VENTING AND AIR CONDITIONING		R - PROPE	PTY LINE
I.D.	INSIDE DIA.		T - FINORE	INTT LINE
IN.	INCH			
			-	-0
INFO	INFORMATION		# — NUMBE	.N
INSUL.	INSULATION			
INT.	INTERIOR			A
KW.	KILOWATTS			
LB(S)	POUND(S)	1 = REVISION		1 = ELEVATION
	• •	- KENIZION		A-1 REFERENCE
MAX.	MAXIMUM			
MECH	MECHANICAL	(1) = KEY NOTES		•
MET, MTL	METAL	•		
MFR.	MANUFACTURER	1		1 = SECTION
MGR	MANAGER	= DETAIL		A-1 REFERENCE
MIN.	MINIMUM	A-1 REFERENCE		
MICC.	MICCELLANEOUS			





4400 CARILLON POINT KIRKLAND, WA 98033 (425) 216-7600 PH

SITE NUMBER: MO-STL0379 MASON GRAY SUMMIT #25

14550 S. OUTER 40 RD. CHESTERFIELD, MO 63017

MISC

MGB

MTD.

MISCELLANEOUS


MOUNTED

MAIN GROUND BUS


							norm
	04/22/10	PER CITY OF CHESTERFIELD COMMENTS	T	СМ	MM	MM	SHEET A-2
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	DATE	REVISIONS		BY	CHK	APP'D	DRAWING NUMBER
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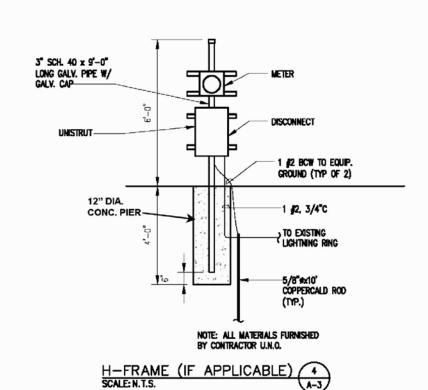
1 = KEYED NOTES


= NORTH ARROW

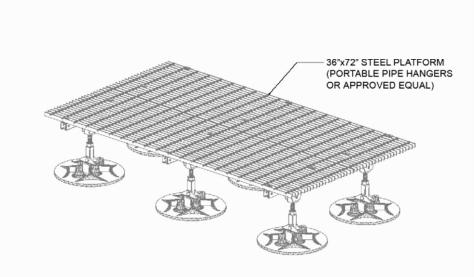

36"x72" PLATFORM DETAIL SCALE: N.T.S.



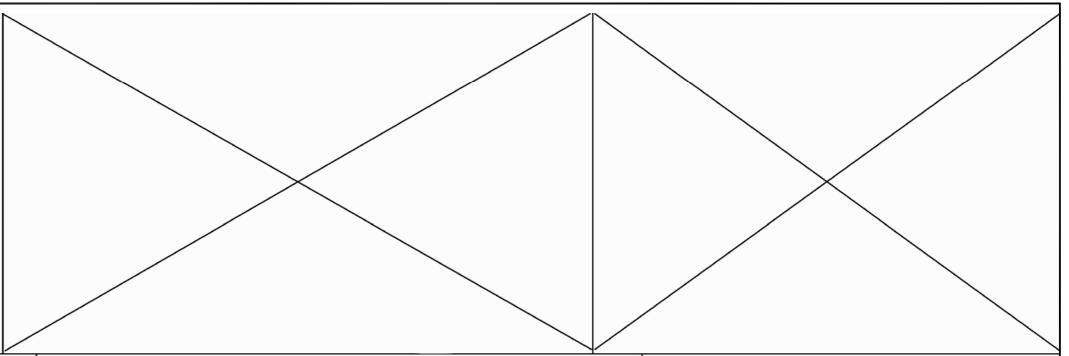

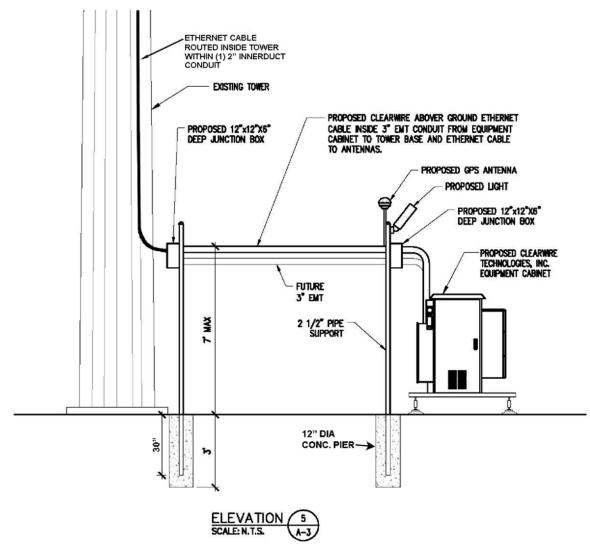

GENERAL NOTES:

- 1. THE BASIC WIND SPEED UTILIZED FOR OUTDOOR EQUIPMENT CABINETS IS 90 MPH PER IBC (LATEST EDITION)
- 2. INFORMATION SHOWN ON THESE DRAWINGS WAS OBTAINED BY FIELD MEASUREMENTS. THE GENERAL CONTRACOTR SHALL VERIFY ALL EXISTING CONDITIONS AND NOTIFY THE ENGINEER OF ANY DISCREPANCIES PRIOR TO ORDERING MATERIALS OR PROCEEDING WITH CONSTRUCTION.
- 3. THE GENERAL CONTRACTOR AND HIS SUBCONSULTANTS SHALL BE RESPONSIBLE FOR OBTAINING ALL PERMITS AND INSPECTIONS WHICH MAY BE REQUIRED FOR THE WORK.
- 4. STRUCTURAL STEEL SHALL CONFORM TO THE LATEST EDITION OF THE AISC SPECIFICATIONS FOR STRUCTURAL STEEL BUILDINGS, ALLOWABLE STRESS DESIGN AND PLASTIC DESIGN INCLUDING THE COMMENTARY AND THE AISC CODE OF STANDARD PRACTICE.
- 5. STRUCTURAL STEEL PLATES AND SHAPES SHALL CONFORM TO ASTM A36. ALL STRUCTURAL STEEL PIPES SHALL CONFORM TO ASTM A53 GRADE B. ALL STRUCTURAL STEEL TUBING SHALL CONFORM TO ASTM A500 GRADE B. ALL STRUCTURAL STEEL COMPONENTS AND FABRICATED ASSEMBLIES SHALL BE HOT DIP GALVINIZED AFTER FABRICATION.
- 6. WELDING SHALL BE IN ACCORDANCE WITH THE AMERICAN WELDING SOCIETY (AWS) D.1.1.96. STRUCTURAL WELDING CODE—STEEL WELD ELECTRODES SHALL BE E70XX. FIELD TOUCH—UP WITH ZINC RICH PAINT (ALL EXISTING AND NEW AREAS) AFTER WELDING IS COMPLETE.
- 7. ALL THREADED STRUCTURAL FASTENERS FOR ANTENNA SUPPORT ASSEMBLIES SHALL CONFORM TO ASTM A307 OR ASTM A36. ALL STRUCTURAL FASTENERS FOR STRUCTURAL STEEL FRAMING SHALL CONFORM TO ASTM A325. FASTENERS SHALL BE 5/8" MIN. DIAMETER BEARING TYPE CONNECTIONS WITH THREADS EXCLUDED IN THE SHEAR PLANE. ALL EXPOSED FASTENERS, NUTS, AND WASHERS SHALL BE GALVANIZED UNLESS NOTED OTHERWISE. CONCRETE EXPANSION ANCHORS SHALL BE HILTI KWIK BOLTS UNLESS NOTED OTHERWISE. ALL ANCHORS INTO CONCRETE SHALL BE STAINLESS STEEL.
- 8. ALL COAXIAL CABLE CONNECTORS AND TRANSMITTER EQUIPMENT SHALL BE AS SPECIFIED BY THE OWNER AND IS NOT INCLUDED IN THESE CONSTRUCTION DOCUMENTS. THE CONTRACTOR SHALL FURNISH ALL CONNECTION HARDWARE REQUIRED TO SECURE THE CABLES, ETHERNET CABLES SHALL BE ATTACHED TO THE TOWER WAVEGUIDE LADDER USING UV-RESISTANT TIE WRAPS OR STAINLESS STEEL HARDWARE.
- NORTH ARROW SHOWN ON PLANS REFERS TO TRUE NORTH. CONTRACTOR SHALL VERIFY NORTH AND INFORM ENGINEER ANY DISCREPANCY BEFORE STARTING CONSTRUCTION.
- 10. ALL REINFORCING STEEL SHALL CONFORM TO ASTM 615 GRADE 80, DEFORMED BILLET STEEL BARS.
- CONCRETE FOR THE EQUIPMENT PAD SHALL BE 4000 PSI MORMAL WEIGHT CONCRETE WITH FIBERMESH ADMIXTURE. CONTRACTOR MAY USE APPROVED PRECAST EQUIVALENT.
- 12. LUMBER SHALL COMPLY WITH THE REQUIREMENTS OF AMERICAN INSTITUTE OF TIMBER CONSTRUCTION AND THE NATIONAL FOREST PRODUCTS ASSOCIATION'S NATIONAL DESIGN SPECIFICATION FOR WOOD CONSTRUCTION. ALL LUMBER SHALL BE PRESSURE TREATED AND SHALL BE STRUCTURAL GRADE NO. 2 OR BETTER.
- 13. IT IS THE OWNERS RESPONSIBILITY TO VERIFY THE STRUCTURAL CAPACITY OF THE EXISTING TOWER AND ITS FOUNDATION TO RESIST THE WIND/GRAVITY LOADS FROM THE PROPOSED ANTENNAS.
- 14. ALL FIELD CUT METAL WILL BE SCRAPED OF ANY RUST AND COLD GALVANIZED.
- 15. RUBBER CAPS WILL BE PLACED ON ALL EXPOSED UNISTRUT ENDS.






4400 CARILLON POINT KIRKLAND, WA 98033 (425) 216-7600 PH (425) 216-7900 FAX

SITE NUMBER: MO-STL0379 MASON GRAY SUMMIT #25

	4	04/22/10	PER CITY OF CHESTERFIELD COMMENTS	TCM	MM	MM	SHEET A-3
	3	04/16/10	CHANGE TO POWER MOUNT	TCM	MM	MM	SHEET A-S
	2	01/07/10	NEW ANTENNA CONFIG	TCM	MM	MM	STRUCTURAL NOTES,
	1	11/02/09	PRELIMINARY CONSTRUCTION DRAWINGS	TCM	MM	MM	SECTIONS & DETAILS
	0	06/01/09	PRELIMINARY DRAWINGS	CJL	MM	MM	SECTIONS & DETAILS
	NO.	DATE	REVISIONS	BY	CHK	APP'D	DRAWING NUMBER
	SCALE: AS SHOWN DESIGNED BY: MM					0938527	

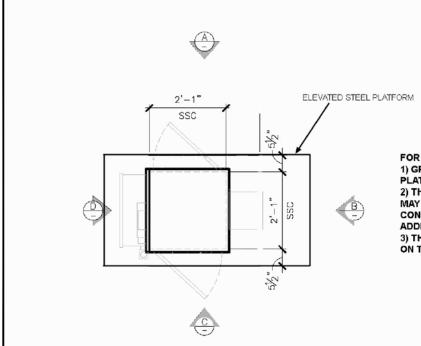

EQUIPMENT PLAN 1 SCALE: 3/8"=1'-0" A-4

FOR CRUSHED STONE/GRAVEL INSTALLATION:


1) GRAVEL MUST BE PUSHED BACK IN ALL AREAS WHERE THE PLATFORM WILL BE INSTALLED. PUSH BACK TO WEED BARRIER.


2) THE GRAVEL MAY BE REUSED AND/OR ADDITIONAL GRAVEL MAY NEED TO BE ADDED TO ENSURE THE DEPTH IS AT THE PRECONSTRUCTION LEVEL. THE CONTRACTOR IS TO ENSURE THAT ADDITIONAL GRAVEL MATCHES EXISTING GRAVEL.


3) THE PLATFORM'S FEET MUST BE PLACED AT GRADE LEVEL ON TOP OF THE WEED BARRIER AND COVERED GRAVEL 8" DEEP.




CABINET PHOTOS

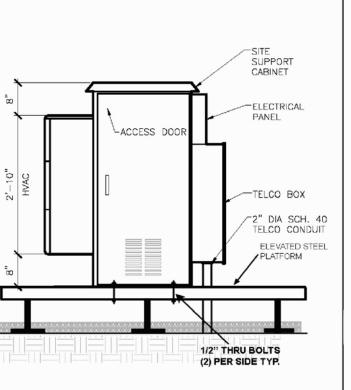

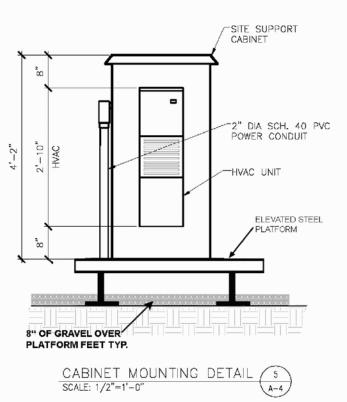

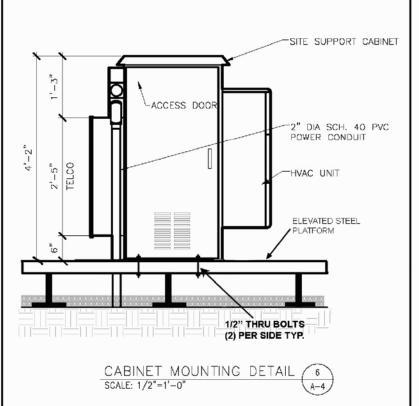

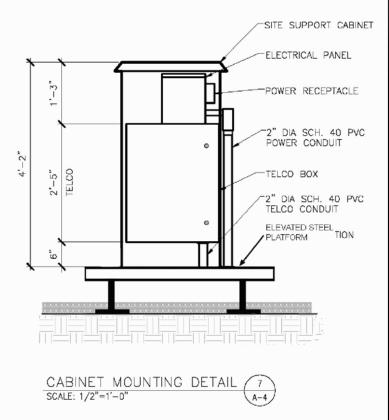



CABINET MOUNTING DETAIL (4
SCALE: 1/2"=1'-0"



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SITE NUMBER: MO-STL0379 MASON GRAY SUMMIT #25

4	04/22/10	PER CITY OF CHESTERFIELD COMMENTS	TCM	MM	MM	SHEET A-4	
3	04/16/10	CHANGE TO POWER MOUNT	TCM	MM	MM	SHEEL A-4	
2	01/07/10	NEW ANTENNA CONFIG	TCM	MM	MM		
1	11/02/09	PRELIMINARY CONSTRUCTION DRAWINGS		MM	MM	EQUIPMENT DETAILS	
0	06/01/09	PRELIMINARY DRAWINGS	CJL	MM	MM		
NO.	DATE	TE REVISIONS		CHK	APP'D	DRAWING NUMBER	
SCA	ALE: AS SHO	DWN DESIGNED BY: MM				0938527	

CONTRACTOR TO INSTALL ANTENNAS AT CENTERLINE AND AZIMUTH AS SHOWN ON THE FINAL RF CONFIGURATION SHEET. CABLE ROUTING ON, IN, OR ABOUT SUPPORT STRUCTURES TO BE AS DETAILED IN THE STRUCTURAL ANALYSIS. THESE DOCUMENTS PROVIDED BY CLEARWIRE FIELD REPRESENTATIVE AT PRE-CONSTRUCTION WALK.

MW PATHS	STD MW CONFIG	ADDITIONAL/ALTERNATE MW
1	1 - VHLP1-23	N/A

*ANTENNA VHLP1 DIAMETER = 12"

*ANTENNA VHLP2 DIAMETER = 26"

*ANTENNA VHLP2.5 DIAMETER = 35"

RF ANTENNA SCHEDULE

CONTRACTOR TO INSTALL ANTENNAS AT CENTERLINE AND AZIMUTH AS SHOWN ON THE FINAL RF CONFIGURATION SHEET. CABLE ROUTING ON, IN, OR ABOUT SUPPORT STRUCTURES TO BE AS DETAILED IN THE STRUCTURAL ANALYSIS. THESE DOCUMENTS PROVIDED BY CLEARWIRE FIELD REPRESENTATIVE AT PRE-CONSTRUCTION WALK.

SECTOR	SECTOR A (ALPHA)	SECTOR B (BETA)	SECTOR C (GAMMA)
RF MODEL	ARGUS LLPX310R	ARGUS LLPX310R	ARGUS LLPX310R
RF AZIMUTH	15°	150°	270°





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SITE NUMBER: MO-STL0379 MASON GRAY SUMMI 14550 S. OUTER 40 RD.


CHESTERFIELD, MO 63017

T "05		
II #25	1	
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	NO.	

4	04/22/10	PER CITY OF CHESTERFIELD COMMENTS	TCN	MM	MM	SHEET A-5
3	04/16/10	CHANGE TO POWER MOUNT	TCM	MM	MM	SHEET A-3
2	01/07/10	NEW ANTENNA CONFIG	TCM	MM	MM	
1	11/02/09	PRELIMINARY CONSTRUCTION DRAWINGS	TCM	MM	MM	MATERIAL LIST
0	06/01/09	PRELIMINARY DRAWINGS	CJL	MM	MM	
10.	DATE	REVISIONS	BY	СНК	APP'D	DRAWING NUMBER
SCALE: AS SHOWN DESIGNED BY: MM						0938527

GENERAL SPECIFICATIONS:

- 1. WIRING SHALL BE AWG STRANDED COPPER WITH THHN OR EQUIVALENT INSULATION. #12 MINIMUM INSTALLED IN 1/2" MINIMUM CONDUIT. SIGNAL WIRING SHALL BE INSULATED #22 AWG. NO BX OR ROMEX CABLE IS PERMITTED. CONDUITS SHALL BE SURFACE MOUNTED.
- 2. WIRING DEVICES AND EQUIPMENT SHALL BE UL LISTED SPECIFICATIONS GRADE.
- 3. MATERIALS SHALL BE NEW AND CONFORM TO THE APPLICABLE STANDARDS ESTABLISHED FOR EACH ITEM BY THE ORGANIZATIONS LISTED BELOW.
- AMERICAN SOCIETY FOR TESTING MATERIALS (ASTM)
- UNDERWRITER'S LABORATORY (UL)
- NATIONAL ELECTRICAL MANUFACTURING ASSOCIATION (NEMA)
- AMERICAN STANDARDS ASSOCIATION (ASA)
- NATIONAL FIRE PROTECTION ASSOCIATION (NFPA)
- 4. INSTALLATION OF MATERIALS SHALL COMPLY WITH REGULATIONS OF:
- THE NATIONAL ELECTRICAL CODE (NFPA 70)
- THE NATIONAL ELECTRICAL SAFETY CODE (ANSI C-2)
- THE LIFE SAFETY CODE (NFPA 101)
- LOCAL BUILDING CODES
- 5. THE ENTIRE SYSTEM SHALL BE SOLIDLY GROUNDED USING LOCKNUTS AND BONDING NUTS ON CONDUITS AND PROPERLY BONDED GROUND CONDUCTOR. RECEPTACLES AND EQUIPMENT BRANCH CIRCUITS SHALL BE GROUNDED WITH A FULL-SIZED EQUIPMENT GROUNDING CONDUCTOR RUN IN THE CIRCUIT'S CONDUIT
- 6. OUTLET AND JUNCTION BOXES SHALL BE ZINC-COATED OR CADIUM PLATED STEEL, NOT LESS THAN 4" SQUARE AND SUITABLE FOR THE TYPE SERVICE AND OUTLET. OUTLET AND JUNCTION BOXES SHALL BE SURFACE MOUNTED AND LABELED WITH BRANCH CIRCUIT BREAKER NUMBER.
- 7. LABEL ALL EQUIPMENT SERVED FROM CLEAR WIRE TECHNOLOGIES, INC. PANEL BOARD WITH PHONEMIC LABELS SIZED IN RELATION TO USAGE.
- 8. INDOOR CONDUCTORS SHALL BE INSTALLED IN EMT UNLESS NOTED OTHERWISE. OUTDOOR CONDUCTORS SHALL BE INSTALLED IN RIGID GALVANIZED STEEL UNLESS NOTED OTHERWISE. WHERE EMT IS USED, IT SHALL BE WITH ONLY LISTED COMPRESSION FITTINGS. NO SET SCREW FITTINGS SHALL BE ALLOWED.
- 9. CONTRACTOR TO PROVIDE AND INSTALL ENGRAVED LABEL ON THE CLEARWIRE TECHNOLOGIES, INC. METER SOCKET ENCLOSURE.

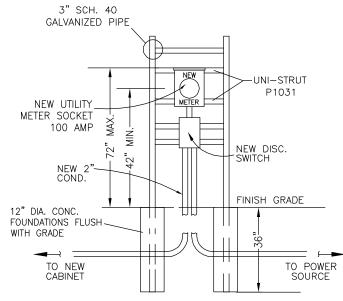

H-FRAME ELEVATION DETAIL (if needed)

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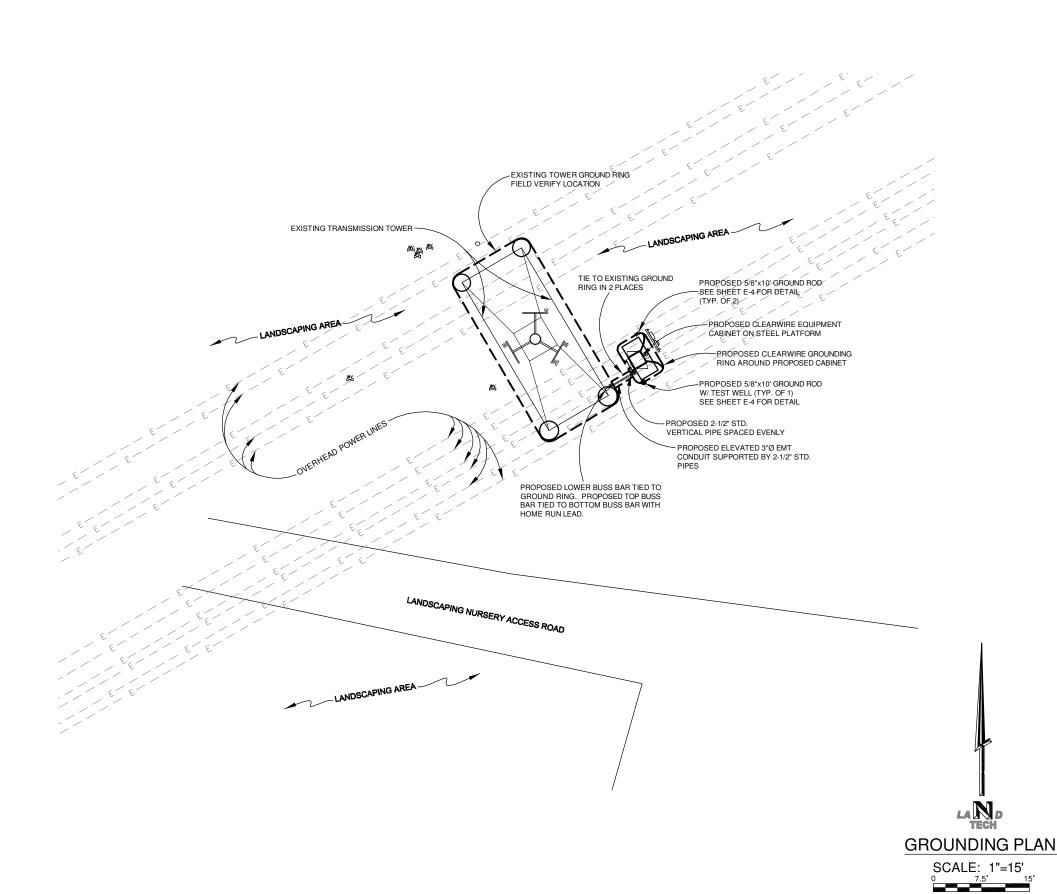
RACK. SEE DETAIL THIS SHEET.

4400 CARILLON POINT KIRKLAND, WA 98033 (425) 216-7600 PH (425) 216-7900 FAX

SITE NUMBER: MO-STL0379 MASON GRAY SUMMIT #25

SCALE: 1"=15'

4	04/22/10	PER CITY OF CHESTERFIELD COMMENTS	TCM	MM	MM	SHEET E-1		
3	04/16/10	CHANGE TO POWER MOUNT	TCM	MM	MM	SUEE1 E-1		
2	01/07/10	NEW ANTENNA CONFIG	TCM	MM	MM			
1	11/02/09	PRELIMINARY CONSTRUCTION DRAWINGS	TCM	MM	MM	ELECTRICAL SITE PLAN		
0	06/01/09	PRELIMINARY DRAWINGS	CJL	MM	MM			
NO.	DATE	REVISIONS	BY	СНК	APP'D	DRAWING NUMBER		
SCALE: AS SHOWN DESIGNED BY: MM						0938527		



GROUNDING SPECIFICATIONS:

- 1. GROUNDING SHALL COMPLY WITH ARTICLE 250 OF THE NATIONAL ELECTRICAL CODE.
- 2. ALL GROUNDING DEVICES SHALL BE U.L. APPROVED OR LISTED FOR THEIR INTENDED USE.
- 3, GROUND WIRES SHALL BE TINNED #2 AWG BARE SOLID Co UNLESS NOTED OTHERWISE.
- 4. GROUNDING CONNECTIONS SHALL BE EXOTHERMIC (CADWELD) UNLESS NOTED OTHERWISE. CLEAN SURFACES TO SHINEY METAL. WHERE GROUND WIRES ARE CADWELDED TO GALVANIZED SURFACES. SPRAY CADWELD
- 5. ROUTE GROUNDING CONDUCTORS ALONG THE SHORTEST AND STRAIGHTEST PATH POSSIBLE. BEND GROUNDING LEADS WITH A MINIMUM 8" RADIUS.
- 6. PRIOR TO INSTALLING LUGS ON GROUND WIRES, APPLY THOMAS & BETSS KOPR-SHELD (TM OF JET LUB INC.). PRIOR TO BOLTING GROUND WIRE LUGS TO GROUND BARS, APPLY KOPR-SHIELD OR EQUAL.
- 7. WHERE BARE COPPER GROUND WIRES ARE ROUTED FROM ANY CONNECTION ABOVE GRADE TO GROUND RING, INSTALL WIRE IN 3/4" PVC SLEEVE, FROM 1'-0" ABOVE GRADE AND SEAL TOP WITH SILICONE
- 8. PREPARE ALL BONDING SURFACES FOR GROUNDING CONNECTIONS BY REMOVING ALL PAINT AND CORROSION DOWN TO SHINY NETAL FOLLOWING CONNECTION, APPLY APPROPRIATE ANTI-OXIDIZATION PAINT.
- 9. GROUNDING WIRE CONNECTIONS SHALL BE 3-CRIMP C-TAP COMPRESSION TYPE. SPLIT BOLTS ARE NOT ACCEPTABLE.
- 10. GROUND RODS SHALL BE COPPER CLAD STEEL 5/8"x10' SPACED NOT LESS THAN 10' O.C.
- 11. CONNECTORS SHALL BE CRIMPED USING HYDRAULIC CRIMPING TOOLS.
- 12. SURFACE CONNECTIONS SHALL BE MADE TO BARE METAL. PAINTED SURFACES SHALL BE FILED TO ENSURE PROPER CONTACT, APPLY NON-OXIDIZING AGENT TO CONNECTIONS.
- 13. COPPER BUSES SHALL BE CLEANED, POLISHED AND A NON-OXIDIZING AGENT APPLIED. NO FINGERPRINTS OR DISCOLORED COPPER WILL BE PERMITTED.
- 14. GROUNDING CONDUCTORS SHALL BE RUN THROUGH PVC SLEEVE WHERE ROUTED THROUGH WALLS, FLOORS, AND CEILING. ENDS OF CONDUIT SHALL BE GROUNDED. SEAL BOTH ENDS OF CONDUIT WITH SILICONE
- 15. HARDWARE (I.E. NUTS, BOLTS, WASHERS, ETC.) IS TO BE STAINLESS STEEL.
- 16. EXOTHERMIC WELDS SHALL BE INSTALLED IN ACCORDANCE WITH MONUFACTURERS RECOMMENDATIONS
- 17. THE ENTIRE SYSTEM SHALL BE SOLIDLY GROUNDED USING LOCKNUTS. AND BONDING NUTS ON CONDUITS AND PROPERLY BONDED GROUND CONDUCTORS. RECEPTACLES AND EQUIPMENT BRANCH CIRCUITS SHALL BE GROUNDED WITH A FULL SIZED EQUIPMENT GROUNDING CONDUCTOR RUN IN THE CIRCUIT'S CONDUIT.
- 18. INSTALL GROUND BUSHINGS ON ALL METALLIC CONDUITS AND BOND TO THE EQUIPMENT GROUND BUS IN
- 19. GROUND BARS (SECTOR, COLLECTOR, MASTER) SHALL BE BARE 1/4"X4" COPPER; LARGE ENOUGH TO ACCOMPOSATE THE REQUIRED NUMBER OF GROUND CONNECTIONS. THE HARDWARE SECURING THE MIGB SHALL ELECTRICALLY INSULATE THE MIGB FROM ANY STRUCTURE TO WHICH IT IS FASTENED.
- 20. APPLY TAB 'KOPR-SHIELD OR APPROVED EQUAL PRIOR TO MAKING MECHANICAL CONNECTIONS. Connections shall be made with stainless steel bolts, nuts and lock washers 3/8" diameter min. Where galvanizing is removed from metel it shall be painted or touched up with "GALVONOX" DR EQUAL.
- 21. ALL TERMINATIONS AT EQUIPMENT ENCLOSURES, PANELS, FRAMES OF EQUIPMENT AND WHERE EXPOSED FOR GROUNDING CONDUCTOR TERMINATION SHALL BE PERFORMED UTILIZING TWO HOLE BOLTED TONGUE COMPRESSION TYPE WITH STAINLESS STEEL SELF-TAPPING SCREWS.
- 22. ALL CLAMPS AND SUPPORTS USED TO SUPPORT THE GROUNDING SYSTEM CONDUCTORS AND PVC CONDUITS SHALL BE PVC TYPE (NON-CONDUCTIVE). DO NOT USE METAL BRACKETS OR SUPPORTS WHICH WOULD FORM A COMPLETE RING AROUND ANY GROUNDING CONDUCTOR.
- 23. ALL BOLTS, WASHERS AND NUTS USED ON GROUNDING CONNECTIONS SHALL BE STAINLESS STEEL.
- 24. THE CONTRACTOR SHALL ENGAGE AN INDEPENDENT ELECTRICAL TESTING FIRM TO TEST AND VERIFY THAT RESISTANCE TO EARTH DOES NOT EXCEED 5.0 OHMS. PROVIDE A COPY OF TESTING REPORT, INCLUDING THE METHOD AND INSTRUMENTS USED TO VERIFY RESISTANCE TO CLEARWIRE REPRESENTATIVE.
- 25, BOND CABINET THROUGH THE MAIN GROUND BAR.


GROUNDING LEGEND

VERIFY LOCATION W/CONSTR. MGR.

%"x10' COPPER CLAD, STEEL GROUND ROD. USE EXOTHERMIC CONNECTION TO GROUND CABLE.

#2 SOLID COPPER TINNED BURIED

BURIED GROUNDING CABLE TO CABLE CONNECTION

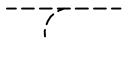

USING EXOTHERMIC PROCESS.

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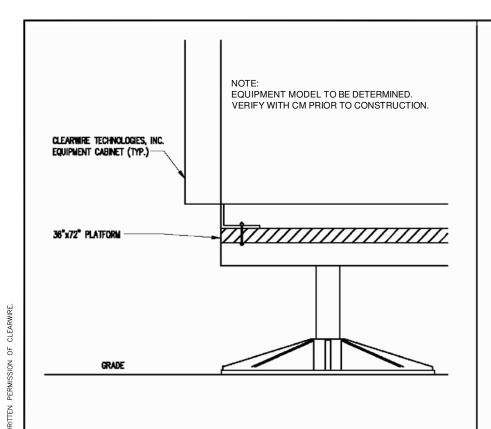
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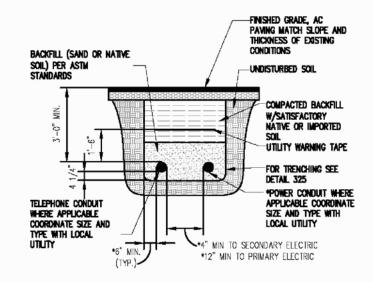
TECHNOLOGIES, INC.

4400 CARILLON POINT KIRKLAND WA 98033 (425) 216-7600 PH

SITE NUMBER: MO-STL0379 MASON GRAY SUMMIT #25

I	4	04/22/10	PER CITY OF CHESTERFIELD COMMENTS	TCM	MM	MM	SHEET E-2
I	3	04/16/10	CHANGE TO POWER MOUNT	TCM	MM	MM	SHEET E-2
I	2	01/07/10	NEW ANTENNA CONFIG	TCM	MM	MM	
	1	11/02/09	PRELIMINARY CONSTRUCTION DRAWINGS	TCM	MM	MM	GROUNDING PLAN
ſ	0	06/01/09	PRELIMINARY DRAWINGS	CJL	MM	MM	
I	NO.	DATE	REVISIONS	BY	СНК	APP'D	DRAWING NUMBER
	SCALE: AS SHOWN DESIGNED BY: MM					0938527	







JOINT SERVICE TRENCH BURIED CONDUIT ELECT/TELEPHONE

TYPICAL TRENCH SECTION

PLATFORM MOUNTING DETAIL SCALE: N.T.S.


> NOTE: FIELD VERIFY EXACT LOCATION OF UTILITY SERVICE. MAX. 3/0 CONDUCTOR LENGTH OF 350' FROM EXISTING UTILITY SERVICE TO LOAD CENTER.

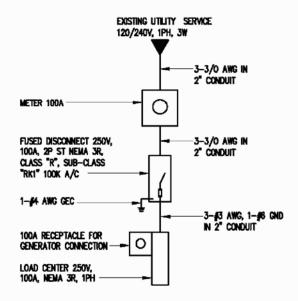

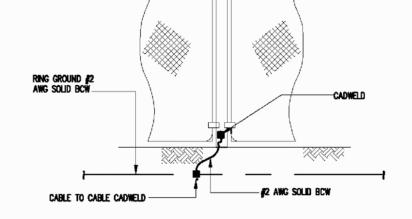

SCALE: N.T.S.



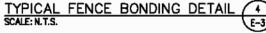






4400 CARILLON POINT KIRKLAND, WA 98033 (425) 216-7600 PH

SITE NUMBER: MO-STL0379 MASON GRAY SUMMIT #25


14550 S. OUTER 40 RD. CHESTERFIELD, MO 63017


GENERAL NOTES:


- 1. OBTAIN PERMITS AND PAY FEES RELATED TO ELECTRICAL WORK PERFORMED ON THIS PROJECT, DELIVER COPIES OF ALL PERMITS TO CLEARWIRE TECHNOLOGIES, INC.
- 2. SCHEDULE AND ATTEND INSPECTIONS RELATED TO ELECTRICAL WORK REQUIRED BY JURISDICTION HAVING AUTHORITY. CORRECT AND PAY FOR ANY WORK REQUIRED TO PASS ANY FAILED INSPECTION.
- 3. REDLINED AS-BUILTS ARE TO BE DELIVERED TO CLEARWIRE TECHNOLOGIES, INC. REPRESENTATIVE.
- 4. PROVIDE TWO COPIES OF OPERATION AND MAINTENANCE MANUALS IN THREE-RING BINDER.
- 5. FURNISH AND INSTALL THE COMPLETE ELECTRICAL SYSTEM, TELCO SYSTEM, AND THE GROUNDING SYSTEM AS SHOWN ON THESE DRAWINGS.
- 6. ALL WORK SHALL BE PERFORMED IN STRICT ACCORDANCE WITH ALL APPLICABLE BUILDING CODES AND LOCAL ORDINANCES, INSTALLED IN A NEAT MANNER AND SHALL BE SUBJECT TO APPROVAL BY CLEARWIRE TECHNOLOGIES, INC. REPRESENTATIVE.
- 7. CONDUCT A PRE-CONSTRUCTION SITE VISIT AND VERIFY EXISTING SITE CONDITIONS AFFECTING THIS WORK. REPORT ANY OMISSIONS OR DISCREPANCIES FOR CLARIFICATION PRIOR TO THE START OF CONSTRUCTION.
- 8. PROTECT ADJACENT STRUCTURES AND FINISHES FROM DAMAGE. REPAIR TO ORIGINAL CONDITION ANY DAMAGED AREA.
- REMOVE DEBRIS ON A DAILY BASIS, DEBRIS NOT REMOVED IN A TIMELY FASHION WILL BE REMOVED BY OTHERS AND THE RESPONSIBLE SUBCONTRACTOR SHALL BE CHARGED ACCORDINGLY. REMOVAL OF DEBRIS SHALL BE COORDINATED WITH THE SITE OWNERS REPRESENTATIVE, DEBRIS SHALL BE REMOVED FROM THE property and disposed of legally. Use of the property's dumpster is prohibited.
- 10. CONTRACTOR TO CONFIRM AVAILABLE CAPACITY AT EXISTING UTILITY PEDESTAL AND ADVISE ENGINEER OF SERVICE SIZE AND FAULT CURRENT LEVEL.
- 11. IF PEDESTAL DOES NOT HAVE ADEQUATE CAPACITY, CONTRACTOR TO SUBMIT COST QUOTATION TO UPGRADE, UPON APPROVAL OF SUBMITTED COST QUOTATION, THE CONTRACTOR SHALL PROVIDE NEW SERVICE AND/OR UPGRADE SERVICE. FEEDERS AND EQUIPMENT/ELECTRODE GROUNDING CONDUCTORS SIZE
- 12. CONTRACTOR SHALL VERIFY SEPERATION DIMENSION BETWEEN POWER COMPANY ELECTRICAL CONDUITS AND LP GAS PIPES AS PER UTILITY COMPANY, LOCAL CODES, NEC. NFPA, AND GAS TANK MANUFACTURER'S
- 13. CONTRACTOR SHALL VERIFY THAT THE TOTAL NUMBER OF SERVICE ENTRANCE DISCONNECTS IN THE EXISTING UTILITY COMPANY PEDESTAL MUST NOT EXCEED SIX. IF THE NEW SERVICE ADDED EXCEEDS THIS VALUE, CONTRACTOR MUST COORDINATE WITH THE UTILITY COMPANY AND AUTHORITY HAVING JURISDICTION. THE RUNNING OF AN ADDITIONAL EXCLUSIVE AND DEDICATED SERVICE LATERAL SET FOR THE NEW LOAD ADDED TO THE COMPOUND AS PER NEC ARTICLE 230-2(B).
- 14. THE EQUIPMENT/PROTECTIONS MUST BE RATED FOR STANDARD AIC RATE HIGHER THAN INCOMING EQUIPMENT AND/OR UTILITY COMPANY AIC RATE.

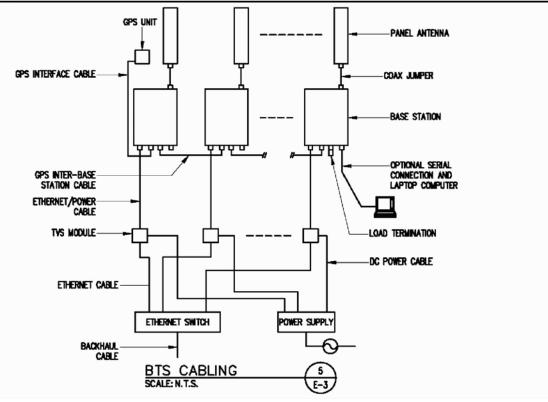



	04/22/10	PER CITY OF CHESTERFIELD COMMENTS	TCM	MM	MM	SHEET E-3		
	04/16/10	CHANGE TO POWER MOUNT	TCM	MM	MM	SHEET E-3		
	01/07/10	NEW ANTENNA CONFIG	TCM	MM	MM			
	11/02/09	PRELIMINARY CONSTRUCTION DRAWINGS	TCM	MM	MM	ELECTRICAL DETAILS		
_	06/01/09	PRELIMINARY DRAWINGS	CJL	MM	MM			
Э.	DATE	REVISIONS	BY	CHK	APP'D	DRAWING NUMBER		
CALE: AS SHOWN DESIGNED BY: MM						0938527		

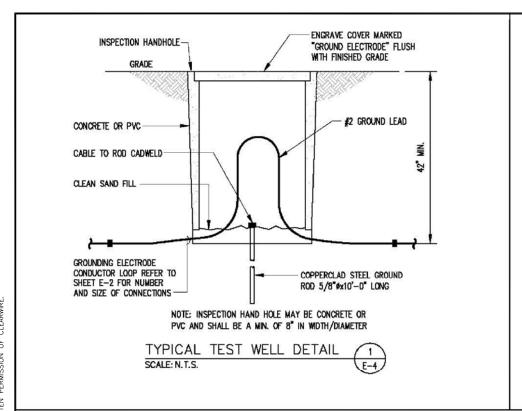

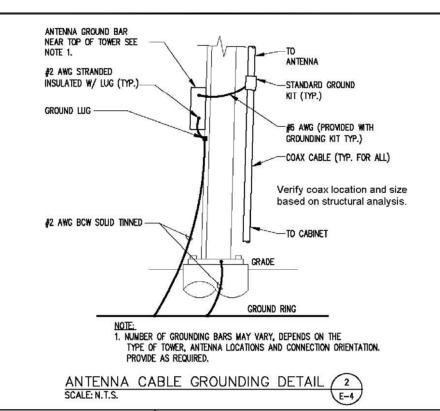

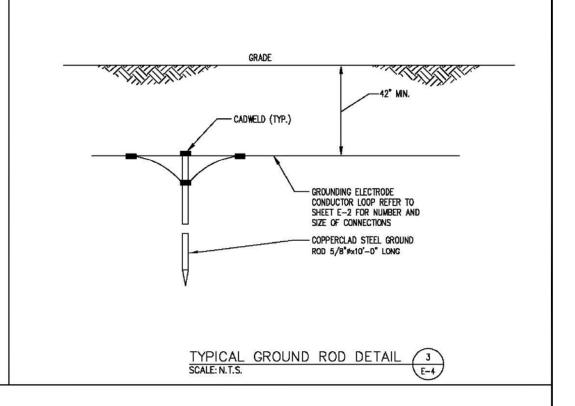

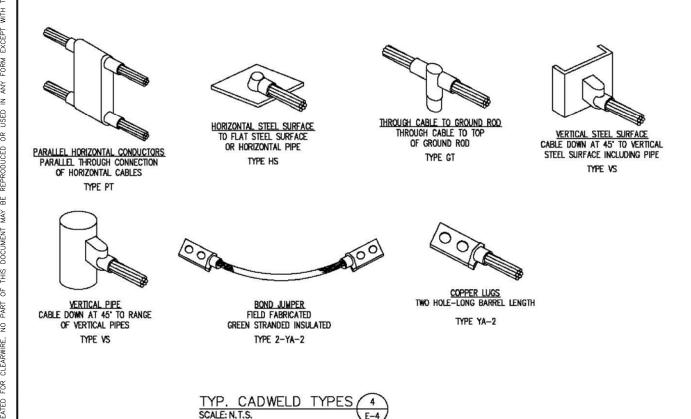

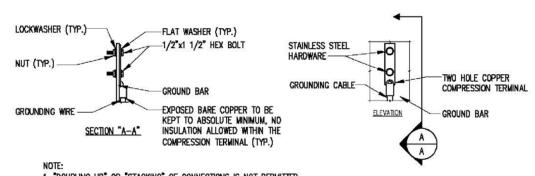

- "DOUBLING UP" OR "STACKING" OF CONNECTIONS IS NOT PERMITTED.
- 2. OXIDE INHIBITING COMPOUND TO BE USED AT ALL LOCATIONS AND TO BE APPLIED PRIOR TO ADDING HARDWARE.









4400 CARILLON POINT KIRKLAND, WA 98033 (425) 216-7600 PH (425) 216-7900 FAX SITE NUMBER: MO-STL0379 MASON GRAY SUMMIT #25

Ι	4	04/22/10	PER CITY OF CHESTERFIELD COMMENTS	TCM	MM	MM	SHEET E-4
I	3	04/16/10	CHANGE TO POWER MOUNT	TCM	MM	MM	SHEET E-4
	2	01/07/10	NEW ANTENNA CONFIG	TCM	MM	MM	
	1	11/02/09	PRELIMINARY CONSTRUCTION DRAWINGS	TCM	MM	MM	GROUNDING DETAILS & NOTES
Г	0	06/01/09	PRELIMINARY DRAWINGS	CJL	MM	MM	
r	10.	DATE	REVISIONS	BY	CHK	APP'D	DRAWING NUMBER
	SCALE: AS SHOWN DESIGNED BY: MM					0938527	

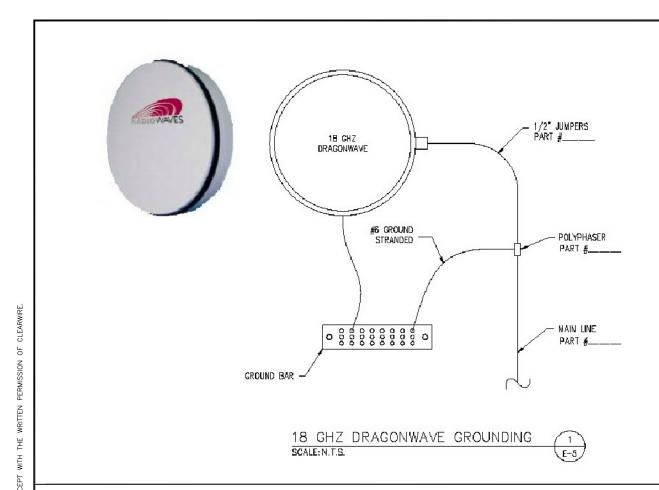

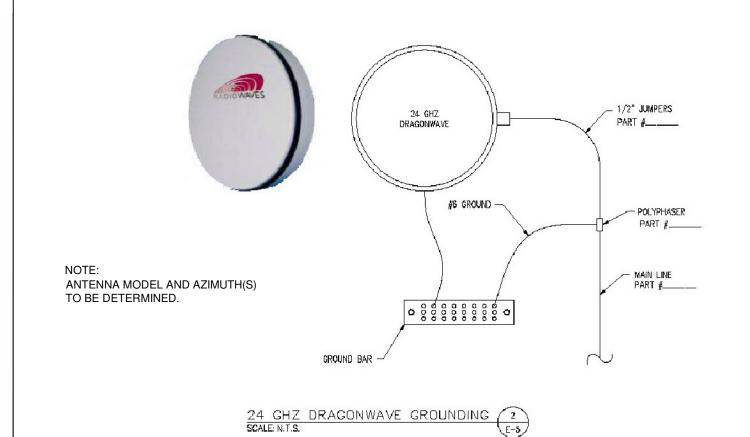

#6 GROUND AMP 18 GHZ DRAGONWAVE CROUND BAR 0 0 0 0 0 0 0 0 0 0 1/2" JUMPERS -PART #___

_ 1/2" JUMPERS ANDREW POLYPHASER PART #_ MAIN LINE PART #___ #6 GROUND -0 0 0 0 0 0 0 0 0 GROUND BAR ANDREW GROUNDING SCALE: N.T.S.

18 GHZ DRAGONWAVE/AMP GROUNDING 3





4400 CARILLON POINT KIRKLAND, WA 98033 (425) 216-7600 PH

SITE NUMBER: MO-STL0379 MASON GRAY SUMMIT #25

4	04/22/10	PER CITY OF CHESTERFIELD COMMENTS	TCM	MM	MM	SHEET E-5
3	04/16/10	CHANGE TO POWER MOUNT	TCM	MM	MM	SUEE1 E-3
2	01/07/10	NEW ANTENNA CONFIG	TCM	MM	MM	
1	11/02/09	PRELIMINARY CONSTRUCTION DRAWINGS	TCM	MM	MM	GROUNDING ANTENNA DETAILS
0	06/01/09	PRELIMINARY DRAWINGS	CJL	MM	MM	
10.	DATE	REVISIONS	BY	СНК	APP'D	DRAWING NUMBER
SCALE: AS SHOWN DESIGNED BY: MM						0938527