

VII. B.

690 Chesterfield Pkwy W • Chesterfield MO 63017-0760 Phone: 636-537-4000 • Fax 636-537-4798 • <u>www.chesterfield.mo.us</u>

## **Planning Commission Staff Report**

| Project Type: | Sign Package   |
|---------------|--|
| Meeting Date: | March 11, 2019   |
| From:         | Mike Knight, Planner   |
| Location:     | 114 N Eatherton Rd.  |
| Description:  | Windsor Crossing Community Church, Sign Package: A request for a Sign Package for a 38 acre tract of land located east of Eatherton Road, directly north of the Pacific Railroad tracks. |

## **PROPOSAL SUMMARY**

Summit Sign and Graphics, on behalf of The Crossing Church, has submitted a request for a Sign Package for the Windsor Crossing Community Church Subdivision. In accordance with the Unified Development Code (UDC), if approved, the proposed Sign Package would serve as the site specific regulations pertaining to signage for this development.

The purpose of a Sign Package is to provide comprehensive and complementary signage throughout a development. The UDC states that "in order to encourage superior design, quality and character, Comprehensive Sign Packages allow for specialized review of signs and flexibility from standard signage requirements."

This Sign Package is being requested to allow for two additional free-standing identification signs and one projecting sign on the west elevation. The site's current and requested signage will be detailed throughout this report.



Figure 1: Aerial Image

## <u>HISTORY</u>

The subject site was zoned "NU" Non-Urban by St. Louis County prior to the incorporation of the City of Chesterfield. The original site plan for a 32,183 square foot church for Windsor Crossing Community Church was approved in 2002. While there have been several amendments since that time, the most notable were for additions in 2005, 2007, 2012, and 2018, which brought the building to its current size of 93,486 square feet. The building contains a large sanctuary space, offices, gathering spaces, and spaces for ministries to meet, including children and youth.

The site currently does not have a Comprehensive Sign Package. In 2009, Planning Commission provided approval for a freestanding identification sign in which the height was over 6 feet tall and the base of the sign exceeded 3 feet in height. The sign currently resides at the entrance to the site off of Eatherton, and will be shown later in this report.

## LAND USE AND ZONING OF SURROUNDING PROPERTIES

The predominant land uses and zoning for surrounding properties are described below:

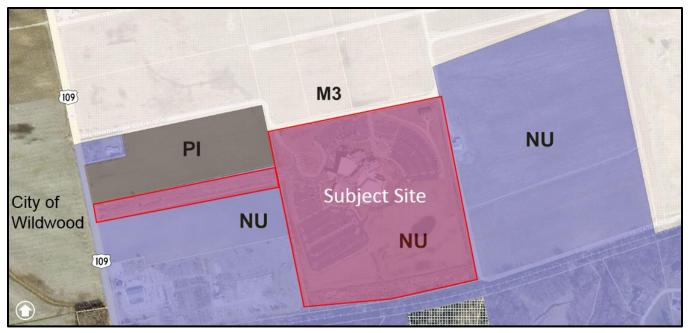


Figure 2: Zoning

| Direction | Zoning                           | Land Use                     |
|-----------|----------------------------------|------------------------------|
| North     | "M3" Planned Industrial District | Spirit of St. Louis Air Park |
| East      | "NU" Non-Urban District          | Undeveloped                  |
| South     | "NU" Non-Urban District          | Railroad Tracts/Bluff        |
| West      | "NU" Non-Urban District          | Nursery                      |
| West      | "PI" Planned Industrial District | Undeveloped                  |

Table 1: Land Use

## **SUBMITTAL OVERVIEW**

Section 31-04-05(F)8 of the Unified Development Code identifies the signage regulations for churches. It states that a church or house of worship shall be permitted one freestanding identification and one attached identification sign with size requirements in accordance to Section 31-04-05(G) of the same Article, "Sign Regulations-Permanent Signs". The site currently has one freestanding identification sign and one approved attached wall identification sign. The applicant is requesting, within the mechanism of the Comprehensive Sign package, two additional freestanding-identification signs and one projecting wall sign. This report will first describe the current signage and its location within the site, followed by the requested signage.

## STAFF ANALYSIS

#### **Current Signage:**

Currently residing on the 38 acres site at 114 N Eatherton Road is the 93,486 square foot building known as The Crossing Church. There are currently no wall signs attached to the church, although there is one approved for the west elevation (Figure 5). The sign is 49 square feet in size, well under the amount permitted. In regards to site signage, the development has one freestanding identification sign located at the entrance of the site. The freestanding identification sign was approved by Planning Commission in 2009 and has a signage outline area of 47.25 SF and is 12' 6" tall. There is approximately 1,500 feet in distance from Eatherton Road to The Crossing Church. Figures 4 and 5 show the approved freestanding identification sign and the approved wall sign, followed by Figure 6 providing their locations within the site.

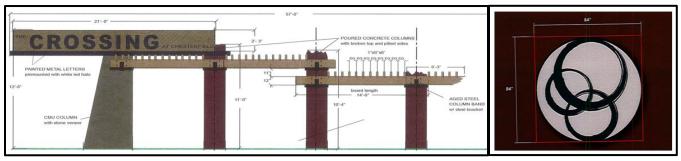


Figure 4: Existing Freestanding Identification Sign

Figure 5: Approved Wall Sign



Figure 6: Current Signage Location

#### **Requested Signage:**

The applicant is requesting 3 additional signs within the mechanism of the Comprehensive Sign Package, which exceed what is allowed by the UDC. The request contains two additional monument/freestanding identification signs and one projecting sign attached to the west elevation near the approved wall sign. The applicant states that the primary focus of the sign package is to improve wayfinding to the Main Entrance and enhance the overall look of the property. Below is a description of each sign and how the signs correspond to the UDC requirements.

**Sign 1** - The freestanding identification sign is 39.3 square feet in outline area and just over 5 feet in height. The location of the sign is roughly at the intersection of the private drive to the north and the northwest parking lot entrance. The Unified Development Code permits identification signs to be up to 50 square feet in size and up to 6 feet in height. The maximum outline area and/or height of any freestanding sign may be increased to a maximum of 100 square feet in outline area and/or 20 feet in height above the average existing finished grade elevation at the base of the sign or elevation of the adjacent street, whichever is higher, with no height restriction for the bottom of the sign face subject to Planning Commission approval. The size of the sign meets all UDC requirements, but this site only allows for one freestanding identification sign and this would be the second.

**Sign 2**- This freestanding identification sign is 17 square feet in outline area and 16 feet in height. The location of the sign is roughly where the parking lot meets the sidewalk to the main entrance. The size of the sign meets UDC requirements with Planning Commission approval, but this site only allows for one identification sign and this would be the third.

**Sign 3** – The projecting sign is 56 feet in outline area and the length is just over 13.5 feet in height. Projecting signs are identified as prohibited signs within the UDC. The definition of a projecting sign in the UDC is any sign, other than a flat or wall sign, affixed to a building or wall in such a manner that its back edge extends more than six (6) inches beyond the surface of such building or wall.



Figure 7: Sign 1

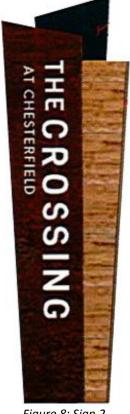




Figure 8: Sign 2

Figure 10 below is the location of all the signage if the comprehensive sign package were approved.

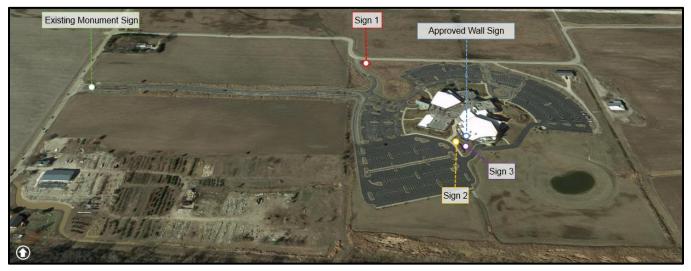


Figure 10: Signage Location if Approved

The applicant provided a rendered image of the main entrance with the signage, if approved, in Figure 11.



Figure 11: Rendered image of the Main Entrance

#### Comprehensive Table:

Below is a summary table of signage requested and how they relate to the UDC requirements.

|          | Summary Table            |           |           |              |                |            |
|----------|--------------------------|-----------|-----------|--------------|----------------|------------|
| Signs    | Turne                    | Total     | Total     | Sign Outline | Outline Area   | Prohibited |
| Signs    | Туре                     | Requested | Permitted | Area (SF)    | Permitted (SF) | Sign       |
| Duilding | ** West Wall             | 1         | 1         | 49           | 160.8          | No         |
| Building | West Projecting          | 1         | NA        | 56           | NA             | Yes        |
|          | ** Main Entrance         |           |           | 47.25        |                | No         |
|          | Private Entrance         | 3         | 1         | 39.3         | 100            | No         |
|          | <b>Building Entrance</b> |           |           | 17           |                | No         |

*Note 1: \*\* Previously Approved* 

Note 2: All Monument Signs under 20ft in height

#### Sign Packages

The purpose of a sign package, which serves as the mechanism for allowing modifications to the UDC sign regulations, is to provide comprehensive, complementary, and unified signage throughout a development. The UDC states that "in order to encourage superior design, quality and character, comprehensive sign packages allow for specialized review of signs and flexibility from standard signage requirements."

The UDC includes the following review factors that are to be considered by the Planning Commission when discussing the appropriateness of the requested flexibility in sign criteria:

- 1. The physical impact of the proposed comprehensive sign package;
- 2. The quality of the proposed comprehensive sign package; and
- 3. Mitigation of unfavorable conditions such as excessive signs, light spillover from signs, height, and other related conditions and potentially negative impacts.

The applicant's narrative, in conjunction with the stated purpose of the sign regulations, sign package review criteria, and policies of the Comprehensive Plan, all work together to create the foundation for the Planning Commission's review and consideration of the submittal.

The applicant states within their project narrative that the primary focus of the sign package is to improve wayfinding to the main entrance and enhance the overall look of the property. The applicant also states that any signage specifically identified in the Comprehensive Sign Package shall conform to Section 04-05 of the Unified Development Code.

### **RECOMMENDATION**

Staff has reviewed the proposed Sign Package for the Windsor Crossing Community Church subdivision and all required items have been included. The UDC provides the Planning Commission discretion in considering this Sign Package as there is not concrete criteria in which to review. As such, Staff recommends that the Planning Commission take action on this request.

## MOTION

The following options are provided to the Planning Commission for consideration relative to this application:

- 1) "I move to approve (or deny) the Sign Package for Windsor Crossing Community Church."
- 2) "I move to approve the Sign Package for Windsor Crossing Community Church with the following conditions......" (Conditions may be added, eliminated, altered or modified)

Attachments: Sign Package Submittal



#### March 1, 2019

#### To Whom It May Concern:

We are asking for your consideration for the following three signs as indicated on page 4 of the report:

- Sign 1 Freestanding identification sign
- Sign 2 Freestanding identification sign
- Sign 3 Projecting blade sign

At The Crossing, one of our main objectives is to create a warm, inviting, welcoming place where people can come and explore the truth of the Gospel, experience the grace of Jesus, and express love boldly. We feel we are offering this experience once people get into our building, but the approach to the building can lead to frustration because the current wayfinding signage is lacking.

Despite using cones and painting arrows on the parkway, we receive complaints from confused visitors, daily. This is causing issues with delivery companies and guests, and we are concerned that in an emergency, guiding emergency vehicles to the correct place could be difficult.

The freestanding identification sign along the private drive (to the golf course) will play an important role to those who attend our church, and even those who do not. This is a replacement for a sign that we removed when we updated our brand. Since removing that sign we've seen a drastic uptick in people walking into our building (sometimes in cleats) thinking we're the golf course. We've had to create a map showing how to get to the golf course from our campus to hand out to those who get lost on their way there. The existing rock formation there is a natural setting and will help people differentiate between The Crossing and the golf course.

The projecting sign attached to the side of the building will attract people from the parkway entrance as well as from the side of the building. Our building was initially designed with the main entrance under the portico, which is now the weekend family entrance, and is locked during the week. Many visitors coming for groups, classes, funerals, and other events during the week find themselves at entrances other than our main entrance, which can be very frustrating since they are locked for security purposes.

Once someone sees the blade sign and is headed in the right direction, we believe a large, entrance sign is necessary to help them know that they are in the right place.

With multiple roads entering the property and number of ways to enter the building, there is much confusion for the average visitor. We believe the addition of these three signs will improve the experience for our guests--an experience that begins in the parking lot.

All tenants, businesses, owners within the development shall receive a copy of the Comprehensive Sign Package from the owner at the time of lease/sale. Any signage not specifically identified in the Comprehensive Sign Package shall conform to Section 04-05 of the Unified Development Code.

We appreciate your consideration and look forward to hearing from you soon.

Sincerely, Correct

Lisa Korrect Director of Communication

## **EXISTING MONUMENT SIGN**







#### MATERIAL SPECIFICATIONS

#### Top Cabinet

Non-illuminated sign Constructed of aluminum Main cabinet area painted PMS 7530 C Top "fin" cabinet area painted PMS 7546 C Aluminum panel: 1/4" thick aluminum "The Crossing" letters are routed out of panel (but connected) Painted custom faux rust textured paint, Matte finish

"At Chesterfield" letters constructed of 1/4" thick acrylic, painted PMS Warm Gray 2 C

#### Base Cabinet

2


Constructed of aluminum with Texture Plus faux wood applied, Cedar Brown

Sign is pole mounted with (1) 5" steel pole Mounted into the ground behind existing rocks Sign to be spotlit


#### COLOR DETAILS

**Cedar Brown** 

Rusted Metal paint finish, Matte
PMS 7530 C (Mule Brown)
PMS 7546 C (Dark Spruce)
PMS Warm Gray 2 C (Bison Hide)
Texture Plus Wood

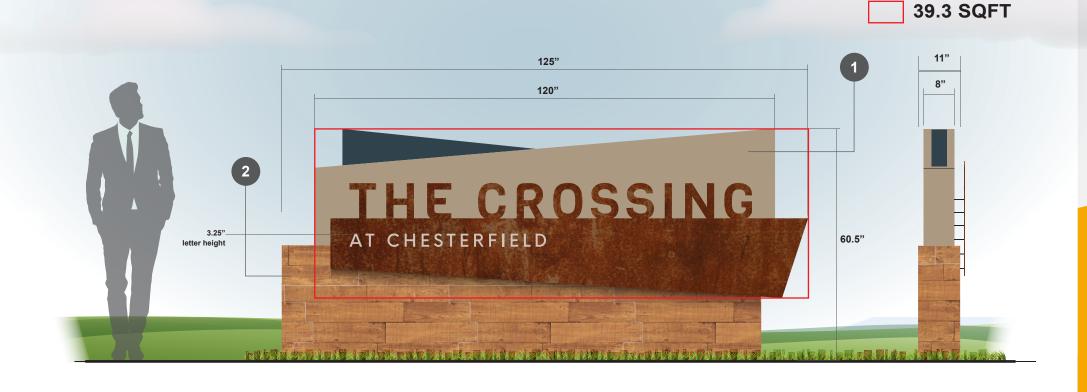

## **MOUNTING METHOD**

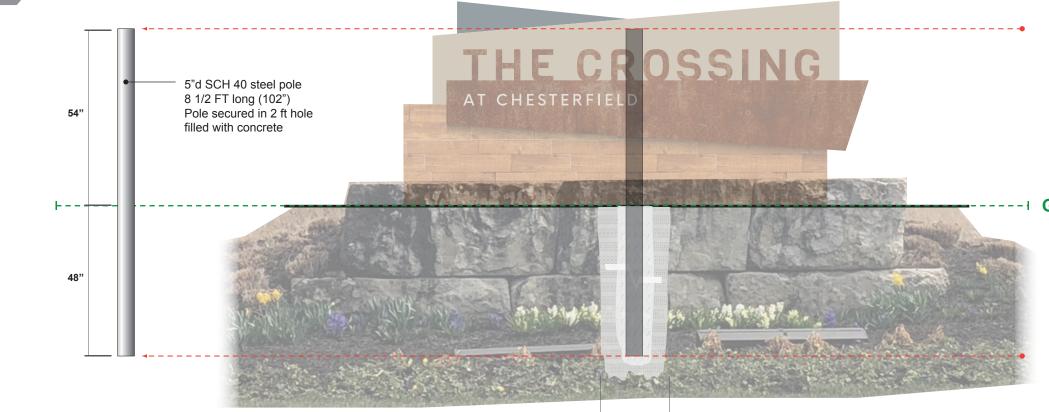



330 Southport Drive Columbia, IL 62236 Phone: 618.281.2639 Fax: 618.281.8703 summitsignandgraphics.com

PROJECT NUMBER 5193

PROJECT Exterior Sign Package

CLIENT The Crossing-Chesterfield

CONTACT Christy Schmidt

**PROOF DATE** 1/17/19

**REVISION DATE** 2/6/19

SALES REP Andy Hrdlicka


DRAWN BY Jillian Woosley


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### GRADE





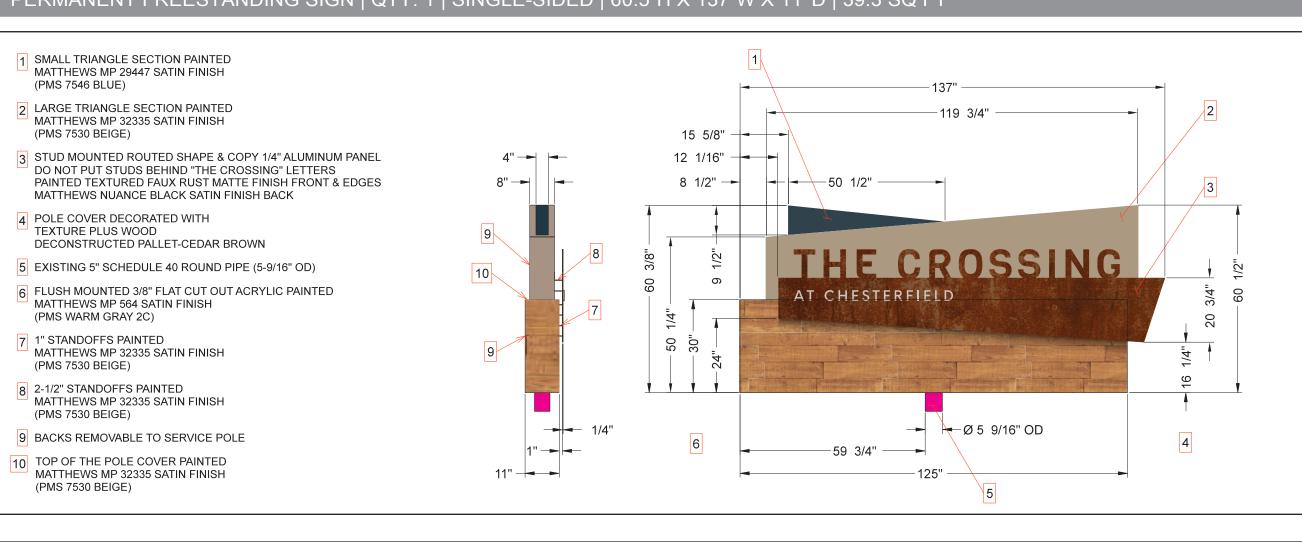

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## LANDSCAPING

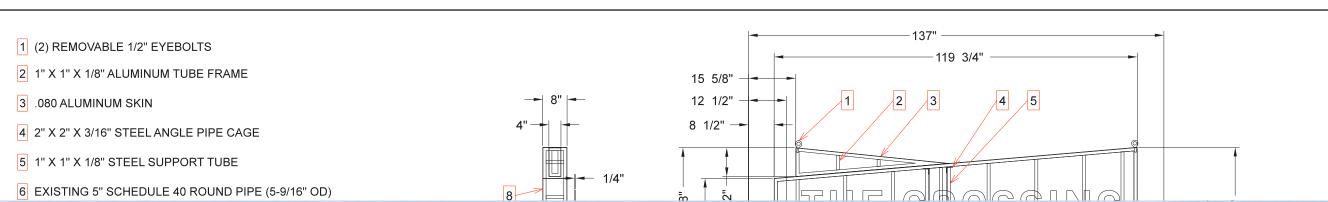

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Large rectangular rocks currently existing in sign location (sign installed behind rocks) Large mulch bed is surrounding the rocks Mixture of perennial and annual flowers placed around the front side of the sign Zinnias, Blanket flowers, Gerber Daises and Daylilies



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## RENDERING



| Deviation Matrix for Proposed Sign |  |  |                         |
|------------------------------------|--|--|-------------------------|
| Sign Type/Description              | Ordinance Standard (Section 31-04-05)  | Proposed Variance  | Difference              |
| Permanent<br>Freestanding Sign     | Sec. 31-04-05_F.2.b.3<br>100 SF Allowance in Overall Sign Area;<br>Not to Exceed 20' in Overall Height | Proposed Sign is 39.3 Square Feet in Area<br>and 5.03 Feet Above Grade | Proposed Sign is withir |



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## PERMANENT FREESTANDING SIGN | SIGN PLACEMENT | SITE MAP





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PROJECT NUMBER 5193

PROJECT

The Crossing-Chesterfield

CONTACT

PROOF DATE

**REVISION DATE** 

**SALES REP** Andy Hrdlicka


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## PERMANENT FREESTANDING SIGN | QTY: 1 | SINGLE-SIDED | 192"H X 57"W X 27"D | 17 SQ FT



LANDSCAPING Mulch bed surrounding sign, circular shape, approximately 8 ft in diameter Box Shrubs placed around the back side of the sign Mixture of perennial and annual flowers placed around the front side of the sign: Zinnias, Blanket flowers, Gerber Daises



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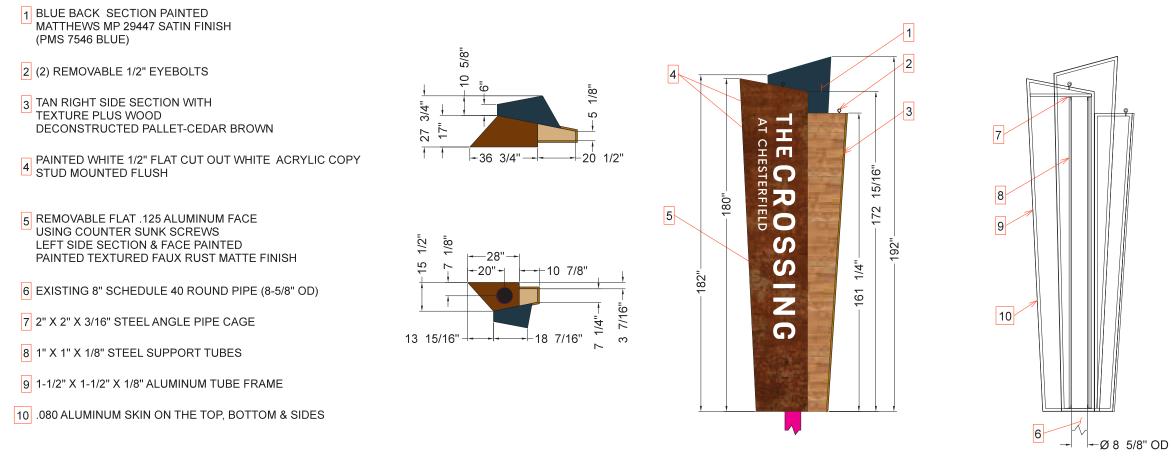
PT

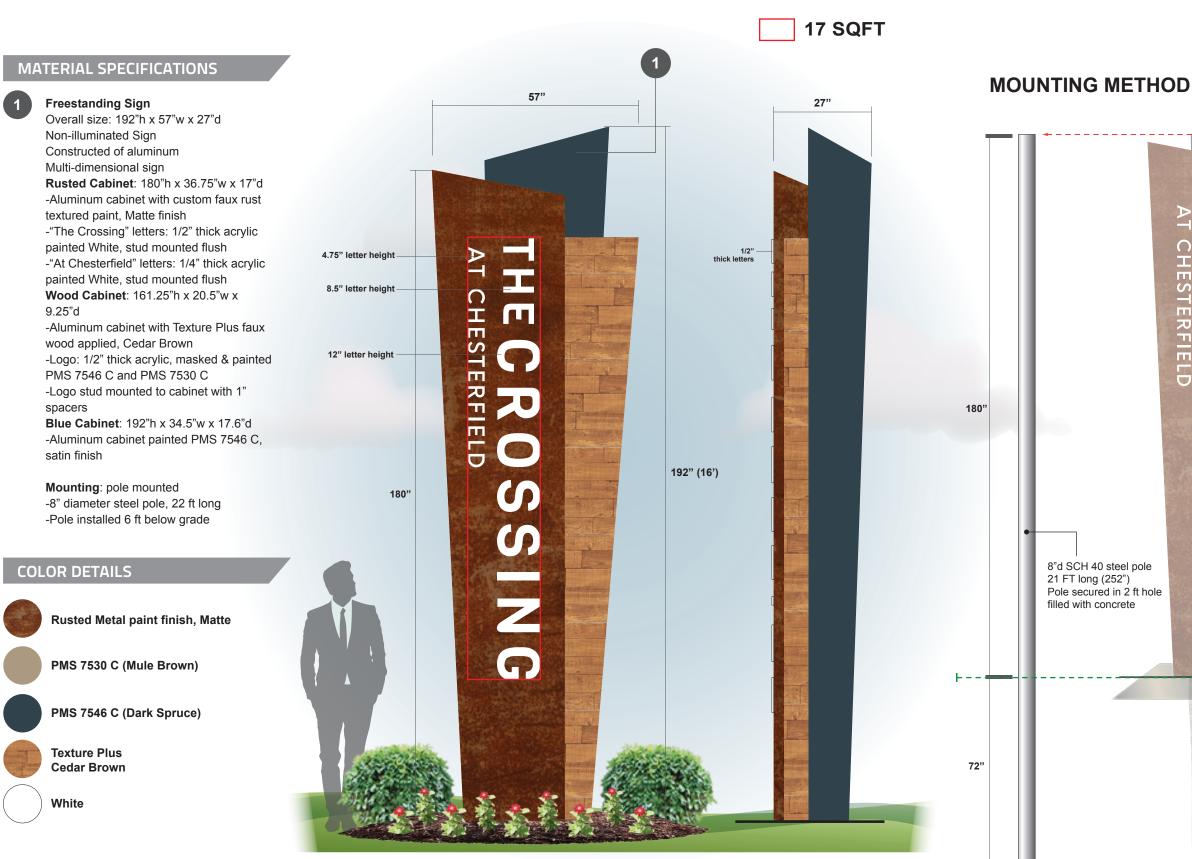
CHESTERFIELD


GRADE



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## PERMANENT FREESTANDING SIGN | QTY: 1 | SINGLE-SIDED | 192"H X 57"W X 27"D | 17 SQ FT

DAY

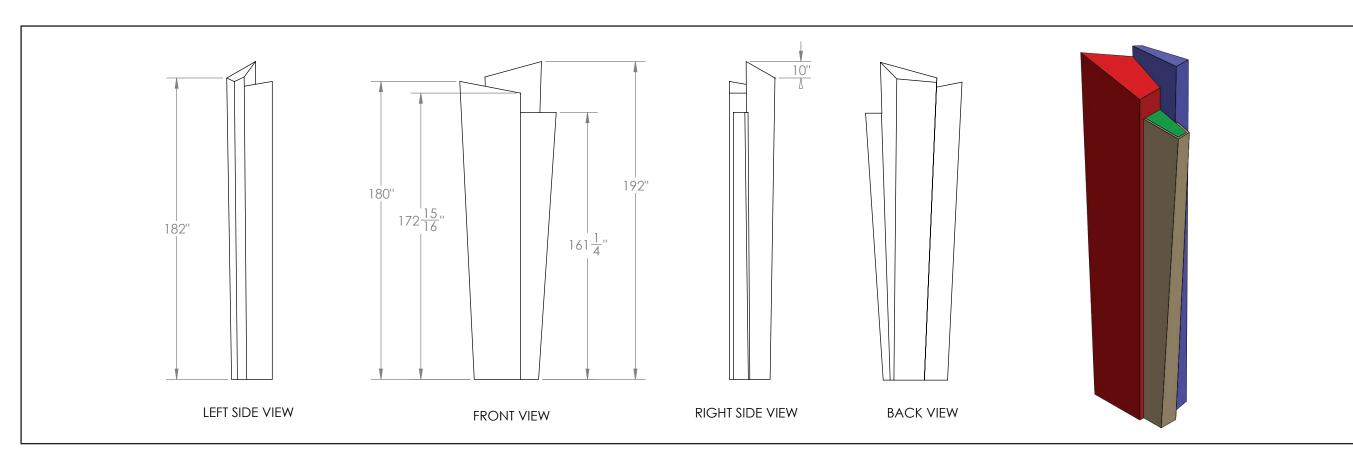NIGHT

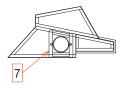

| Deviation Matrix for Proposed Sign |  |  |                         |
|------------------------------------|--|--|-------------------------|
| Sign Type/Description              | Ordinance Standard (Section 31-04-05)  | Proposed Variance  | Difference              |
| Permanent<br>Freestanding Sign     | Sec. 31-04-05_F.2.b.3<br>100 SF Allowance in Overall Sign Area;<br>Not to Exceed 20' in Overall Height | Proposed Sign is 17 Square Feet in Area<br>and 16 Feet Above Grade | Proposed Sign is withir |



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3

## PERMANENT FREESTANDING SIGN | SIGN PLACEMENT | SITE MAP



THE CROSSING

1





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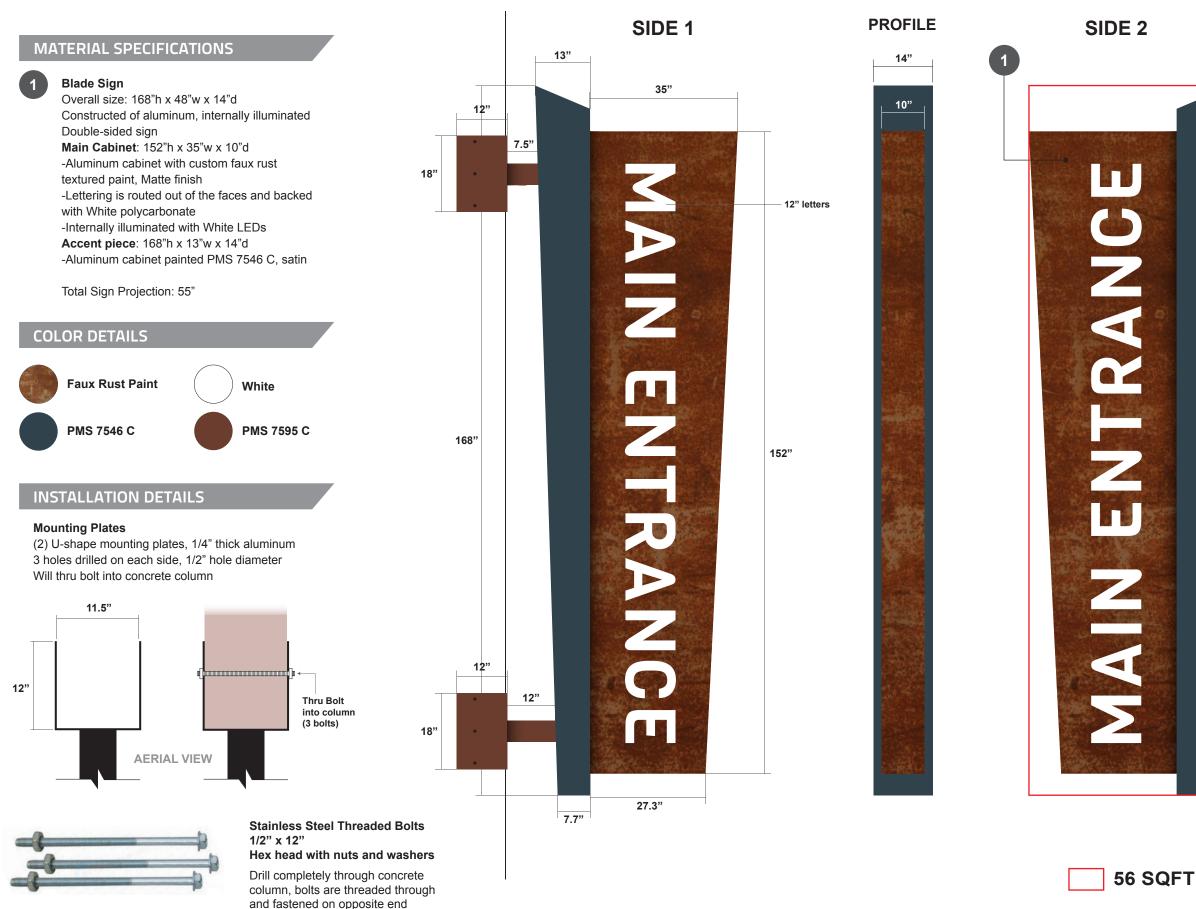
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| - BLOG CODE REQMNT - REINF CONC (ACI 318-83).<br>CODE FOR WELDING IN BUILDING CONSTRUCTION OF<br>AMERICAN WELDING SOCIETY.   |                | d- 5.7'read i   | use 3 + x 60 set                                       |
| - CURRENT SPECS - AMERICAN INST OF STEEL CONST<br>(ASIC) - DESIGN, FAB, & ERECTION.<br>CONCRETE 3000 P.S.L @ 21 DAYS COMPR STR, (150 P.C.F.)<br>REINF STL - ASTMI-815, GR 60, (IF REQD). WELDED WIRE                     |                | Q2 - ))   |  |
| FABRIC(WWF) - ASTM A185<br>- ALL REINF SHALL BE FREE FROM MUD, OIL, RUST OF<br>COATINGS THAT WOULD REDUCE OR DESTROY BOND<br>-ALL REINF BARS SHALL LAP 30 DIAMETERS OR 12"   | L.             | л<br>1  |  |
| MINIUM, EXCEPT AS NOTED.<br>MINIUM, EXCEPT AS NOTED.<br>MINICONC COVER ON TES, STURRUPS AND MAIN BAF<br>SHALL BE 1 INCH FOR SLAB, WALL'AND SURFACES<br>EXPOSED TO WEATHER OR IN CONTACT WITH GROU                        |                |   | OF MISSING   |
| INCHES FOR UNFORMED SURFACES DEPOSITED AGAI<br>GROUND EXCEPT AS NOTED.<br>STOUCTURAL STEEL AND PLATES - A-36.  | NST            |   | ALL ALL AND        |
| STRUCTURAL TUBING - ASTM A-500, GR B, FY-45 KSL<br>STRUCT PIPE- ASTM A-33, GR B, FY-35 KSL<br>ANCHOR BOLTS ASTM A-307, EXCEPT AS NOTED.<br>HI STRGTH BOLTS - CONNNECTIONS - ASTM A-325, U.N.O.                           |                | 1111  | PATRICK  |
| WELDING ELECTRODES - AWS D1.1-34, E70XX.<br>CONTRACTOR SHALL VERIFY ALL DIMENSIONS AND CONDI'  | NONS           | میں<br>1984ء<br>1984ء<br>1985ء                        |  |
| ENGINEER OF ANY DISCREPANCIES.<br>NO CABINET ENGINEERIG PROVIDED, IF CABINET ENGRG IS<br>REGID, CONTACT THE ENGINEER FOR ADD"TL 3<br>6" OF CONCRETE OR GRAVEL PLACED IN BOTTOM OF  | ivcs.          |   | E-18052  |
| FOUNDATION PRIOR TO MAIN POUR.<br>ISOLATE ALUMINUM FROM STEEL.<br>ALL BOLT HOLES TO BE DRILLED OR PUNCHED.<br>ALL PIPE SIZES SHOWN ARE MINIMUM SIZES. PIPE WITH A<br>ALL PIPE SIZES SHOWN ARE MINIMUM SIZES. PIPE WITH A |                |   |  |
| LARGER DIAMETER, GREATER TIELD STRUCT<br>AND/OR GREATER SCTW MOD MAY BE SUBSTIT  | UTED.          | ×.  | THE SALE AND       |
| ONLY. ACTUAL LENGTH MAY SLIGHTLY VARY<br>DEPENDING ON SICH CABINET CONDITIONS.<br>ALL WORK PERFORMED ON SITE SHALL BE DONE ACORDII<br>APPLICABLE OSHA REGULATIONS  | IG TO          |   | 18.11  |
| WATER SHOULD NOT BE ALLOWED TO POND IN THE<br>EXCAVATION PRIOR TO CONCRETE PLACEMEN<br>ABOVE CONCRETE AFTER THE FOTN IS COMP<br>EVENCIES CAPE AURING SECAVATION OF THE FOUNDATION  | IN TO          | 2<br>   | N  |
| MINIMIZE DISTRUBANCE TO THE SURROUNDING SOM  |                |   | aut 2000 015 170                                       |
| BASE POLEIS AND CONCRETE BASE FOUNDATION<br>SR = SECTION MODULUS REQUIRED<br>SP = SECTION MODULUS REQUIRED   | * <sup>*</sup> |   | CAE 2008010470   |
|  |                |   | CROCKER<br>3211 E. SHADY GLEN ST                       |

CROCKER 3211 E. SHADY GLEN ST SPRINGFIELD MO 65804 47.883.4056

## BUSINESS SIGN - PROJECTING MOUNT | QTY: 1 | DOUBLE-SIDED | 168"H X 48"W X 14"D | 56 SQ FT





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PROJECT NUMBER 5193

PROJECT

CLIENT The Crossing-Chesterfield

CONTACT

PROOF DATE

**REVISION DATE** 

SALES REP

DRAWN BY


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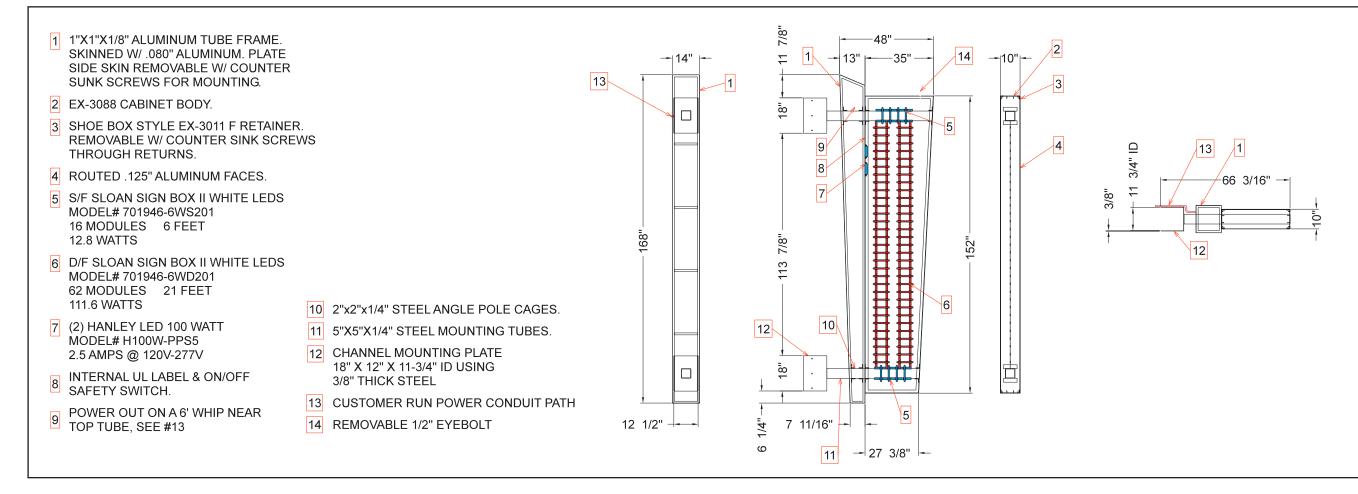
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132" on center







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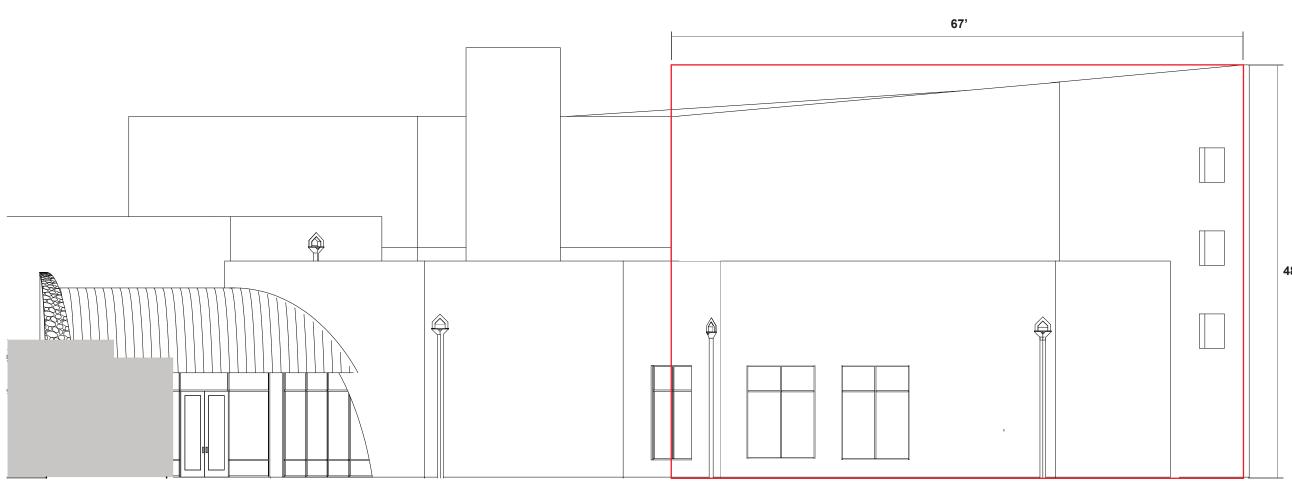
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## **WEST ELEVATION - MAIN ENTRANCE**
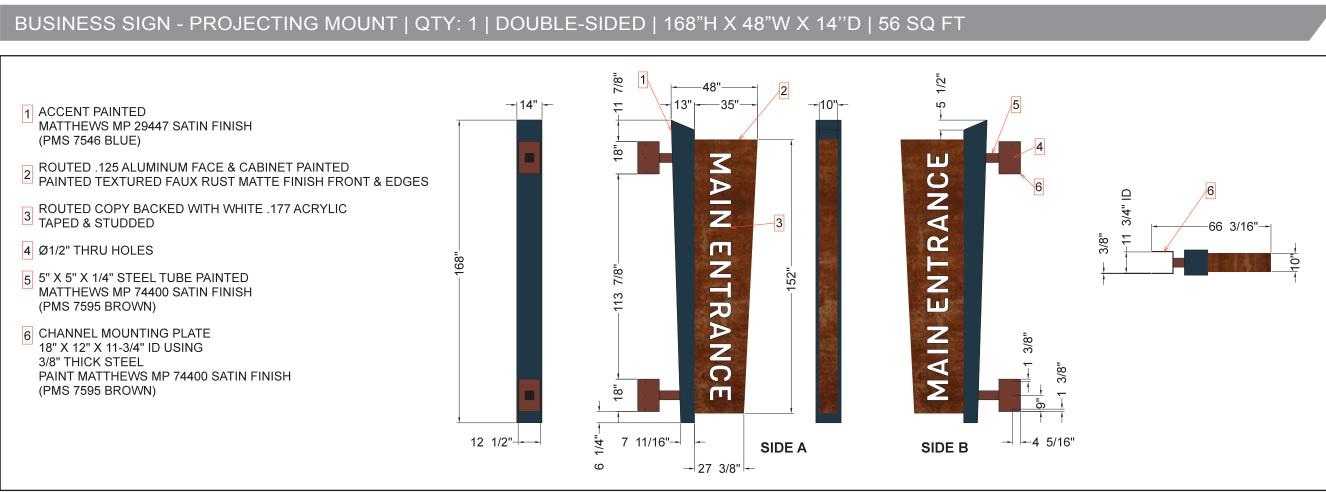
| Total Wall Square Footage | 3,216      |
|---------------------------|------------|
| 5% of Wall Sqft           | 160.8 sqft |

**160.8 sqft** allowance for signage

Business Sign (Projecting) 56 sqft



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-----

PROJECT NUMBER 5193

PROJECT

CLIENT The Crossing-Chesterfield

CONTACT

PROOF DATE

**REVISION DATE** 

**SALES REP** Andy Hrdlicka

DRAWN BY

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## BUSINESS SIGN | QTY: 1

## RENDERINGS

DAY



NIGHT



| Deviation Matrix for Proposed Sign |   |   |   |
|------------------------------------|---|---|---|
| Sign Type/Description              | Ordinance Standard (Section 31-04-05)   | Proposed Variance   | Difference  |
| Business Sign<br>Attached To Wall  | Sec. 31-04-05_F.3.a<br>The outline area of each sign shall not exceed<br>5% of the wall area where sign is be attached. | The wall area where the sign is be attached is 3,216 Square Feet. The allowable 5% of wall area is 160.80 SF. The Proposed Sign is 56 SF. | Proposed Sign is within allo<br>Sec. 31-04-05_H.2.g<br>Projecting Signs are prohibi |



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**PROJECT NUMBER** 5193

**PROJECT** Exterior Sign Package

CLIENT The Crossing-Chesterfield

CONTACT Christy Schmidt

**PROOF DATE** 1/17/19

**REVISION DATE** 2/6/19

**SALES REP** Andy Hrdlicka

**DRAWN BY** Jillian Woosley

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lowance for overall area.

bited.

## BUSINESS SIGN - PROJECTING MOUNT | SIGN PLACEMENT | SITE MAP







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PROJECT NUMBER 5193

**PROJECT** Exterior Sign Package

**CLIENT** The Crossing-Chesterfield

CONTACT Christy Schmidt

**PROOF DATE** 1/17/19

**REVISION DATE** 2/6/19


**SALES REP** Andy Hrdlicka

**DRAWN BY** Jillian Woosley

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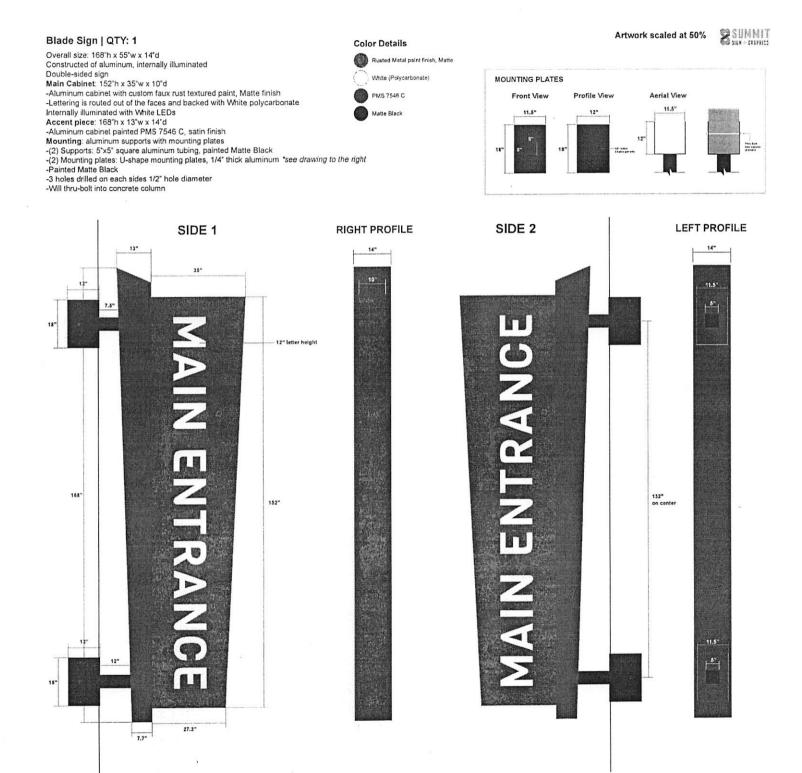


## BLADE SIGN 4,1x 12.7


SUMMIT SIGN THE CROSSINGS CHURCH

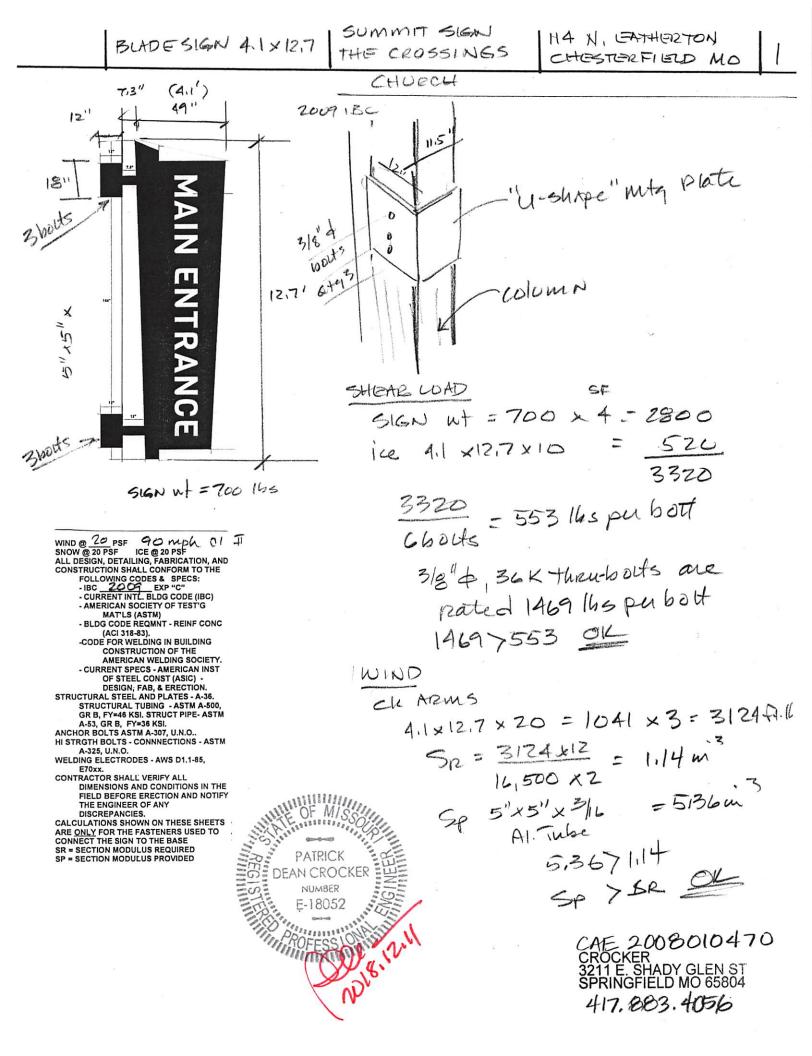


2





CROCKER 3211 E. SHADY GLEN ST SPRINGFIELD MO 65804 417, 883, 4056

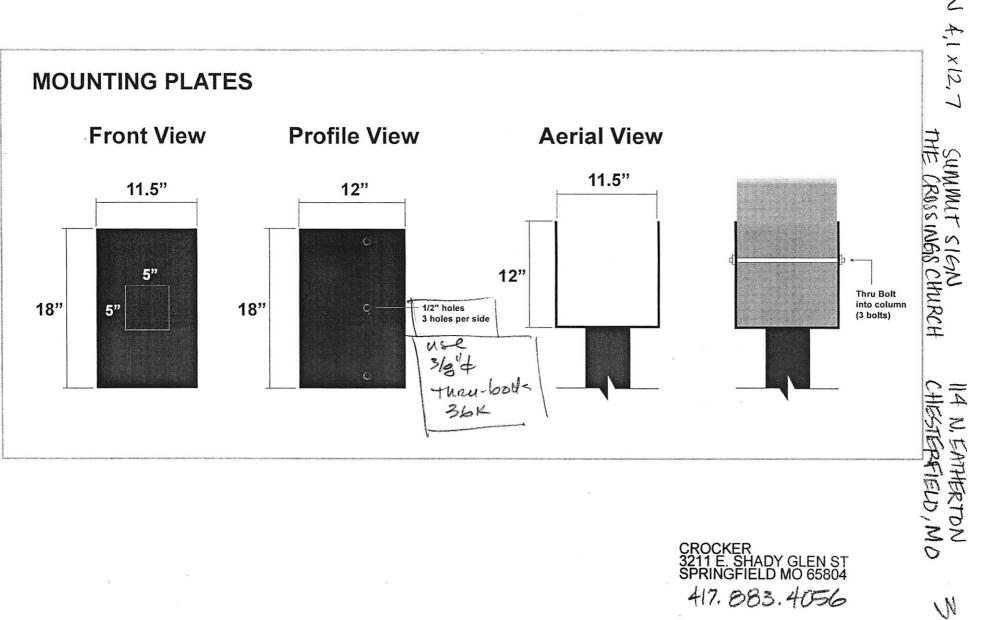


BUNDE SIGN 4,1 × 12,7

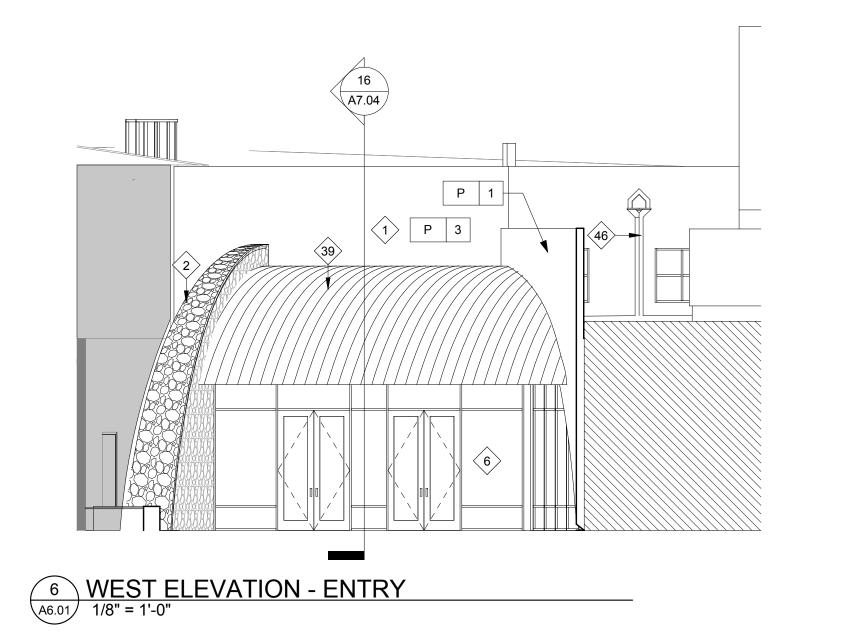

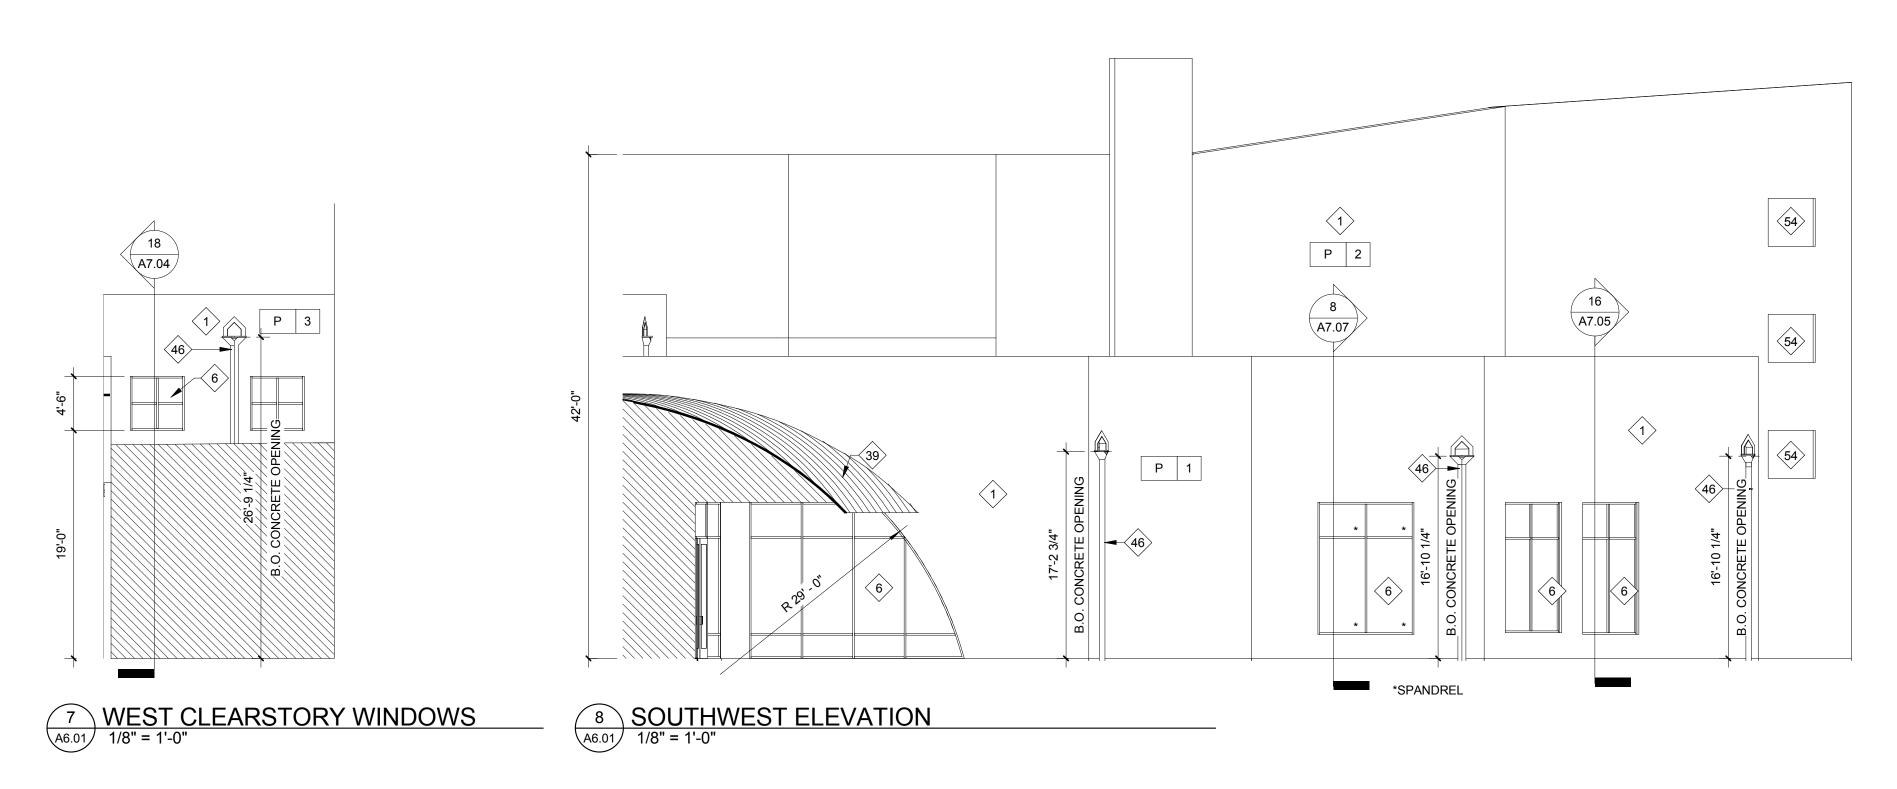

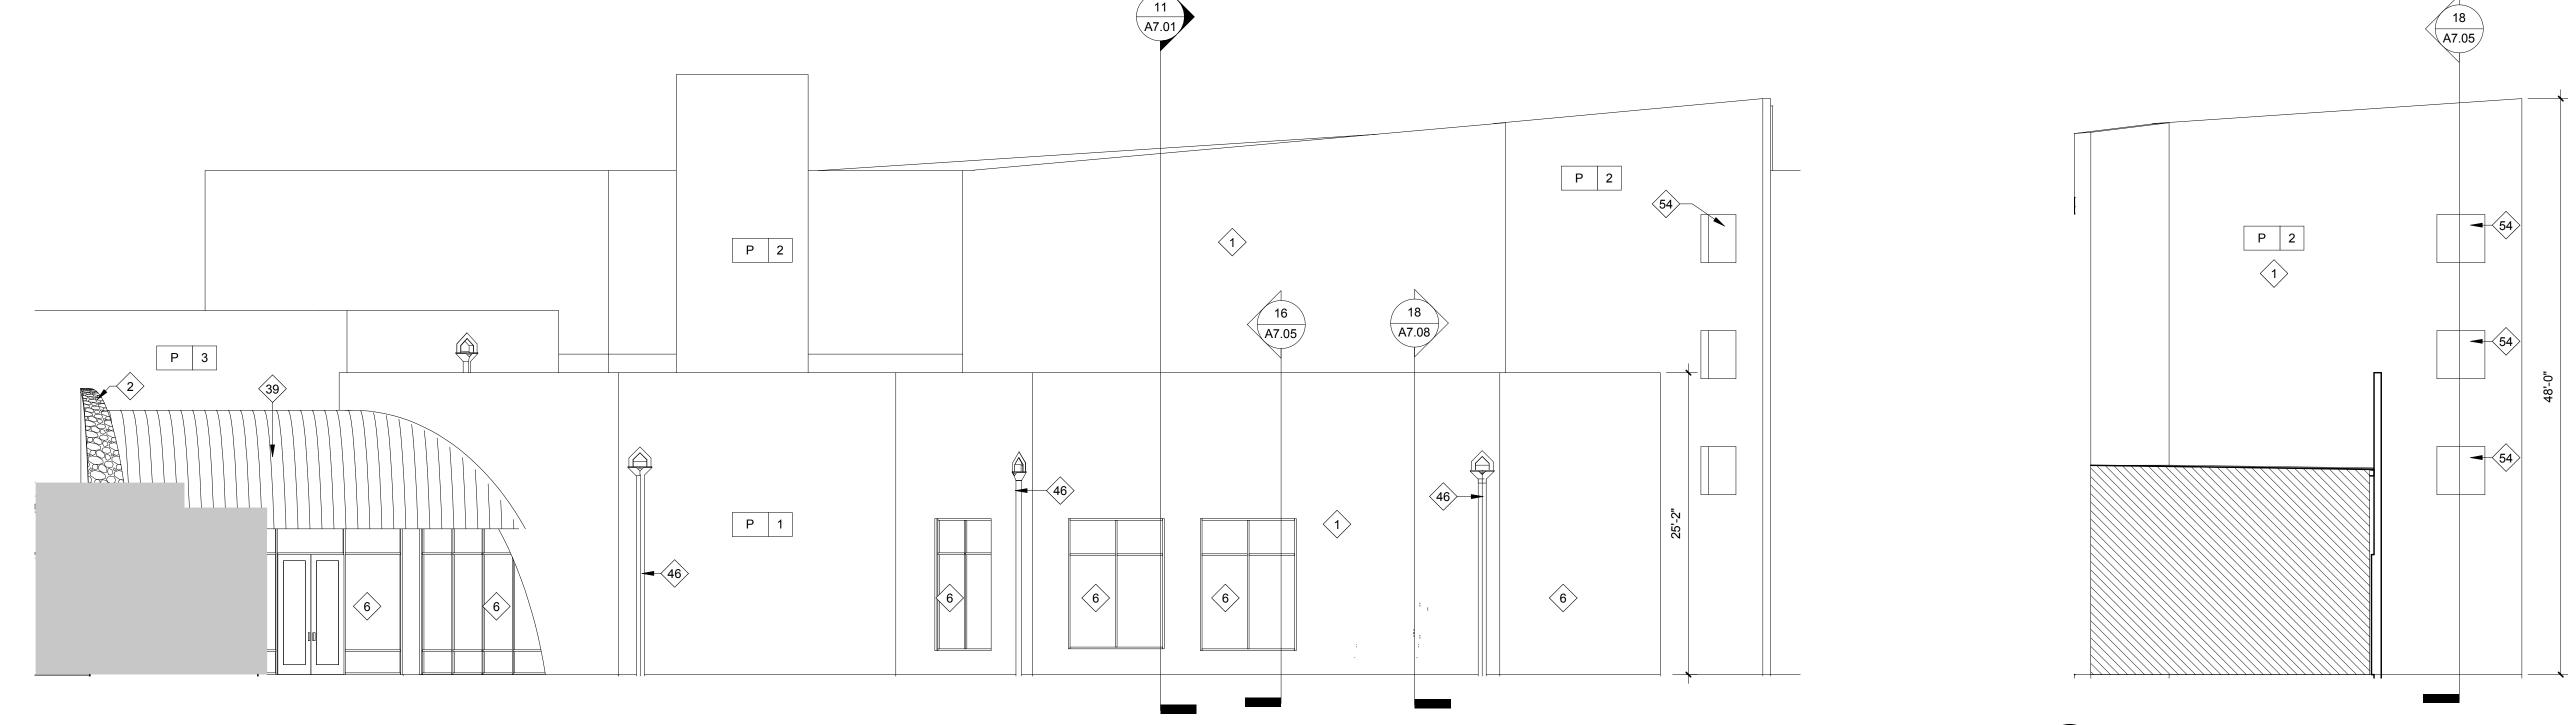



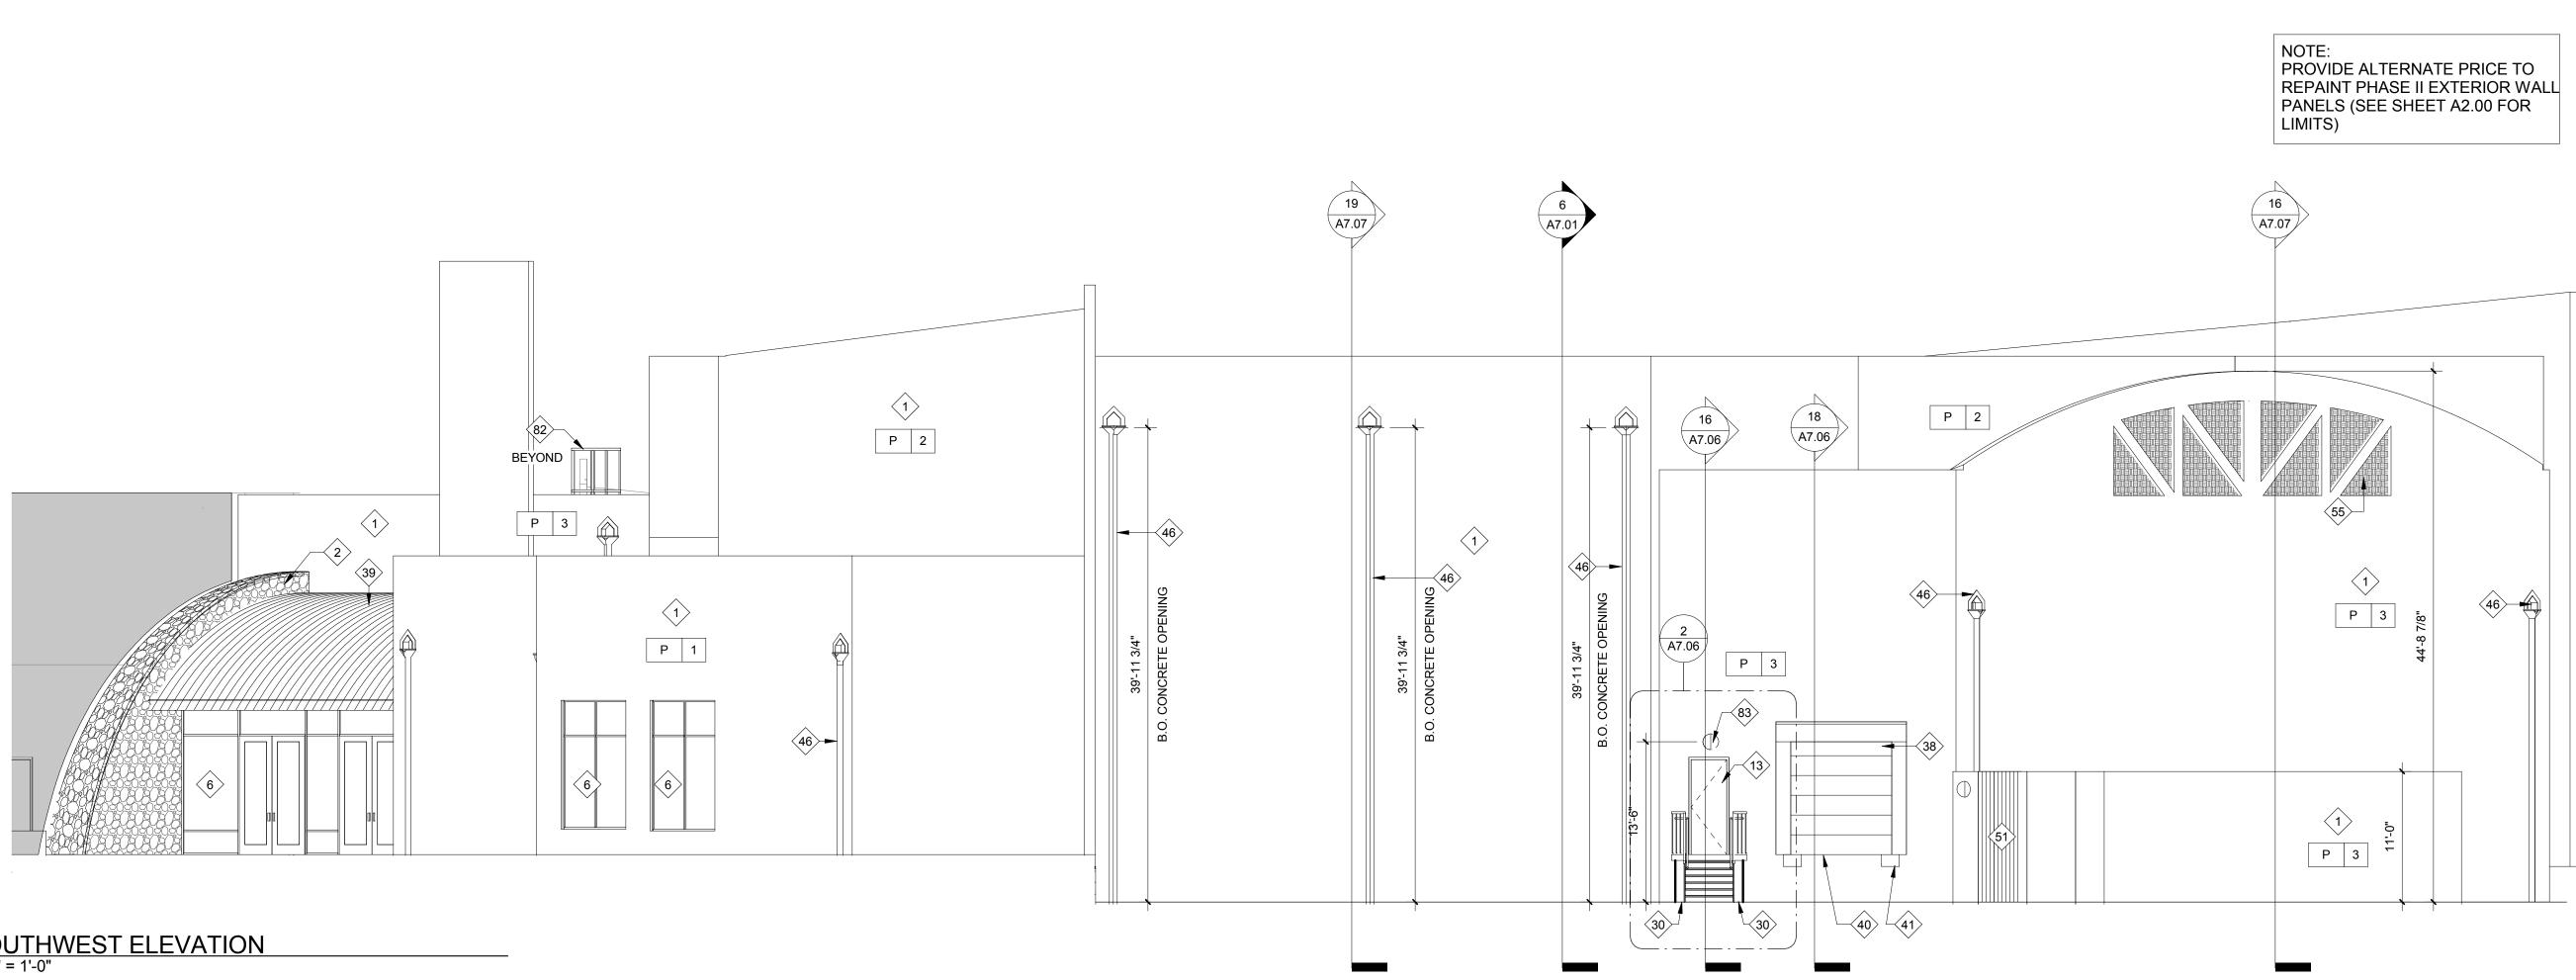

## 14 SOUTHWEST ELEVATION - WING A6.01 1/8" = 1'-0"


NOTE: REFER TO SHEET A5.06 FOR PAINT LEGEND.

## EXTERIOR ELEVATION/ SECTION **KEYED NOTES**


- (1) CONC. TILT-UP PANEL (PTD.) (SEE STRUCT. DWGS)
- CONCRETE TILT-UP PANEL CULTURED STONE APPLIED (SEE STRUCT. DWGS)
- $\langle 3 \rangle$  METAL DECK (SEE STRUCT. DWGS)
- AIR INFILTRATION BARRIER OVER 1/2" EXTERIOR GRADE GYP. BOARD SHEATHING
- $\langle 5 \rangle$  STEEL TUBE (SEE STRUCT)
- $\langle 6 \rangle$  1" INSUL. GLASS IN GREEN ANODIZED ALUM. FRAMES TO MATCH EXISTING
- 7 ALUMINUM SILL PAN, W.W.M. TO FIELD VERIFY LENGTH
- 8 2x FIRE-TREATED WD. BLOCKING
- 9 SHIM AND SEALANT EA. SIDE
- 10 ITEM SHOWN BEYOND
- 6" UN-REINFORCED CONC. SLAB ON 6 MIL.VAPOR BARRIER OVER 4" COMPACTED GRANULAR FILL (SEE STRUCT. DRWGS)
- 12 COMPACTED SUBGRADE
- 13 HOLLOW METAL DOOR. SEE DOOR SCHEDULE & PLANS
- 14 BACKER ROD AND SEALANT
- 15 SINGLE-PLY, 60 MIL WHITE T.P.O MEMBRANE ROOF. REFER TO ROOF PLAN FOR MEMBRANE TYPES AND LOCATIONS.
- <16> STEEL JOIST (SEE STRUCT. DWGS)
- 7 KICKERS AS REQUIRED
- (18) 3 5/8" METAL STUDS @ 16" O.C.
- 19 STEEL COLUMN (SEE STRUCT.DWGS)
- ALUMINUM COMPOSITE PANEL COLOR GREEN TO MATCH EXISTING
- FIBER CEMENT TRIM BOARD COLOR TO BE DETERMINED
- 22 TAPERED INSULATION
- 2'-6" THICKENED SLAB @ EXTERIOR DOORS (FROST HEAVE PROTECTION)-RE: STRUCT. DWGS.
- (24) CONCRETE FOOTING (SEE STRUCT. DWGS)
- 25 STEEL ANGLE (SEE STRUCT. DWGS.)
- $\langle 26 \rangle$  FINISH GRADE (SEE CIVIL DWGS.)
- 27 STRUCTURAL STEEL MEMBER (SEE STRUCT. DWGS) <sup>28</sup> FOIL FACED INSUL, TAPE ALL JOINTS. R-19 INSULATION.
- 29 EXT. GRADE SEALANT
- 30 STEEL PIPE BOLLARD (SEE DETAIL 16/A8.02).
- 1> 4" CONCRETE WALK (SEE CIVIL DRAWINGS)
- 32 3" RIGID INSULATION BOARD. 3" MIN. THICK. 2" RIGID PERIMETER FOUNDATION INSULATION. 2'-0" HORIZONTALLY AND THE
- HEIGHT ON THE FOUNDATION WALL VERTICALLY.
- (34) R30 POLYISOCYRANATE RIGID INSULATION.
- <sup>35</sup> 5/8" GYP. BOARD.
- 36 30# FELT UNDERLAYMENT. (37) METAL COPING, PRE-FINISHED.
- 38 HI-LIFT SECTIONAL DOCK DOOR INSTALLER TO PROVIDE ALL NECESSARY ANCHORAGE FOR INSTALLATION OF DOOR.
- $\langle 39 \rangle$  METAL STANDING SEAM ROOF GREEN TO MATCH EXISTING
- (40) CONTINUOUS STEEL CHANNEL, EMBEDDED IN CONCRETE SLAB.
- $\langle$ 41 $\rangle$  DOCK BUMPER AND DOCK SEAL
- 42 FIBER CEMENT 5/4x6 SOFFIT BOARDS
- (43) R30 GYPCRETE ROOF SYSTEM WITH 6" MONOLITHIC CONCRETE SLAB MIN.
- 44 5/8" EXTERIOR GRADE SHEATHING
- NEW METAL SCUPPER COLLECTOR HEAD PAINTED TO MATCH EXISTING. SEE DETAIL 1/A8.02
- 46 METAL DOWNSPOUTS PAINTED TO MATCH EXISTING (PIPE TO STORM DRAIN, SEE CIVIL DRAWINGS)
- $\langle 47 \rangle$  1/2" JOINT WITH COMPRESSIBLE FILLER.
- 48 CONCRETE SLAB. (SEE STRUCT.)
- (49) ALUMINUM STOREFRONT ENTRY DOORS.
- R-19 VINYL-FACED INSULATION COLOR BLACK (FASTEN TO WALL WITH
- / IMPALING PINS)
- 51 EQUIPMENT YARD. SEE ELEVATION 9/A6.03
- 52 EXISTING E.I.F.S., PATCH AS REQUIRED.
- $_{53}$  8" REINFORCED CONCRETE MASONRY UNIT WALL. GROUT CELLS SOLID BELOW SLAB. (SEE STRUCT.)
- 54 4'-0" x 4'-0" CUT OUT IN TILT-UP PANEL
- 55 METAL SCREEN, MCNICHOLS QUALITY 20 GAUGE (THICKNESS) 3/32" ROUND ON 3/16" STAGGERED PERFORATED METAL GALVANIZED- RUN PATTERN DIAGONAL (NO SPLICING OF PANELS)
- (56) EXPANSION JOINT
- NEW BUILDING ROOF STRUCTURE
- $58^{>}$  EXISTING BUILDING ROOF STRUCTURE AND PARAPET
- 59 EXISTING CONCRETE TILT-UP PANEL
- 60 EXISTING GYPSUM BOARD FURR OUT
- $5^{1}$  TAPE & SPACKLE JOINT
- 63 2 HOUR FIRE RATED INFILL, U.L. DESIGN NUMBER U-411, 2 1/2" 25 GA METAL STUDS @ 16" O.C. WITH 2 LAYERS 5/8" FIRECODE GYP. BD. EACH SIDE (TYP. ALL EXISTING PUNCHED OPENINGS IN 2 HOUR SEPARATION WALL) SEE
- PARTITION TYPE 31.
- $\langle 64 \rangle$  EXISTING TILT-UP PANEL OPENING (65) EXISTING CONCRETE SLAB TO REMAIN.
- 66 FLOOR LINE
- 67> 1/2" GYP. BOARD
- 68 2" METAL "Z" CHANNELS AT 24" O.C. (HORIZONTALLY)
- 69 CONTINUOUS 2 HOUR FIRE RATED SEALANT EACH SIDE OF PARTITION
- (70) COUNTERFLASHING AND REGLET WITH CONT. BEAD OF SEALANT.
- $\overline{\gamma_1}$  TERMINATE NEW MEMBRANE AT EXISTING ROOF W / NEW LAP JOINT DETAIL PER MANUFACTURE RECOMMENDATIONS
- (72) E.I.F.S. FINISH OVER 3/4" RIGID INSULATION W/ SPRAY APPLIED WEATHER
- BARRIER. 73 5/8" EXTERIOR GLASS FIBER SURFACE GYPSUM SHEATHING
- 74 2 1/2" METAL STUDS @ 16" O.C.
- <sup>5</sup> DECORATIVE GUARD RAILING
- <sup>6</sup> DECORATIVE ACOUSTICAL PANELS
- 7 PRE-FINISHED FLASHING WITH FULL PERIMETER SEALANT
- 78 1 5/8" METAL FRAMING AT 24" O.C.
- <sup>79</sup> 6" METAL FRAMING @ 16" O.C.
- 80 4" METAL FRAMING @ 16" O.C.
- ALUMINUM CLOSURE TRIM COLOR GREEN
- 82 ALUMINUM ROOF LADDER AND CAGE. RE: 13/A8.02
- (83) LIGHT FIXTURE. SEE ELECTRICAL DRAWINGS.
- 84 PROVIDE ICE AND SNOW STOPS. (CLEAR)
- 85 6 MIL VAPOR BARRIER BEHIND GYP. BOARD
- (86) 2" RIGID BOARD INSULATION


 $62^{>}$  5/8" GYPSUM BOARD FURR OUT TO MATCH EXISTING



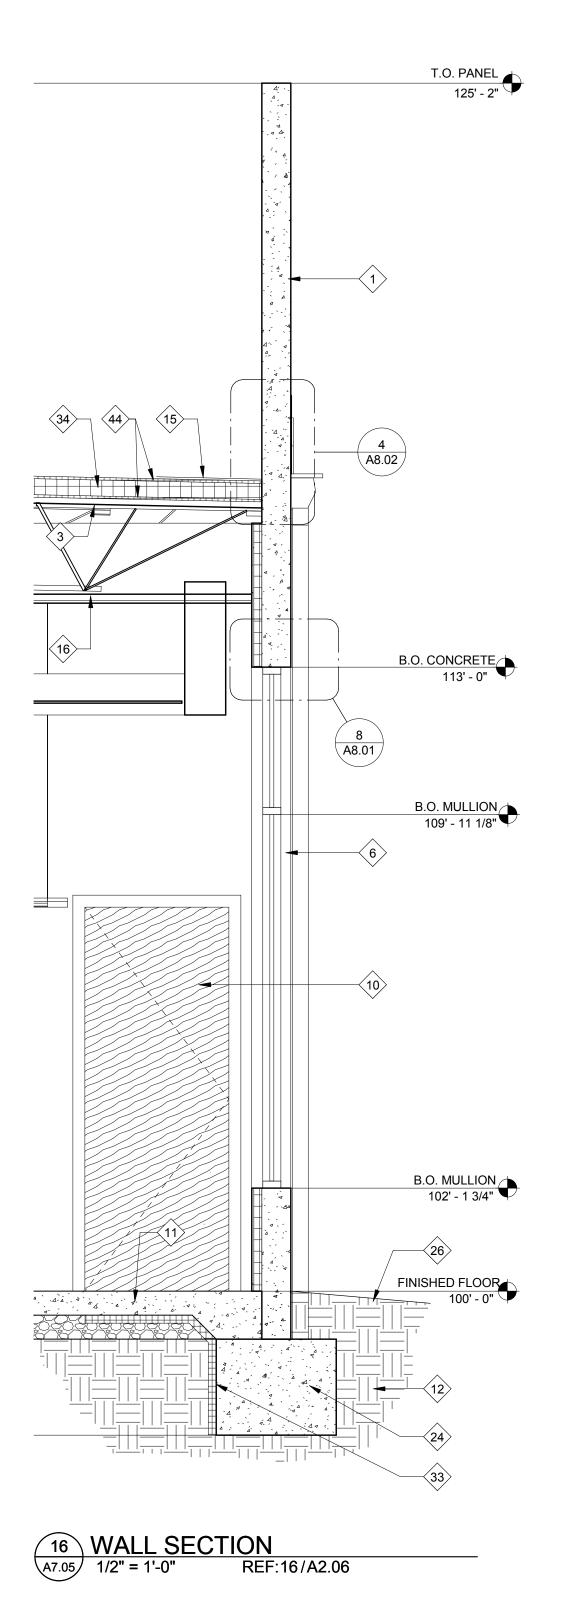



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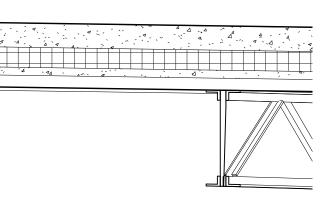


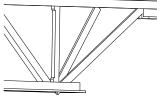

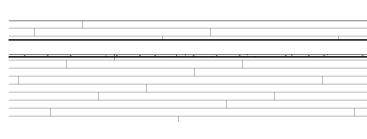17 WALL SECTION AT CATWALK LADDER A7.05 1/2" = 1'-0"



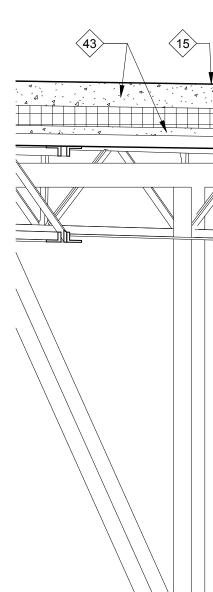

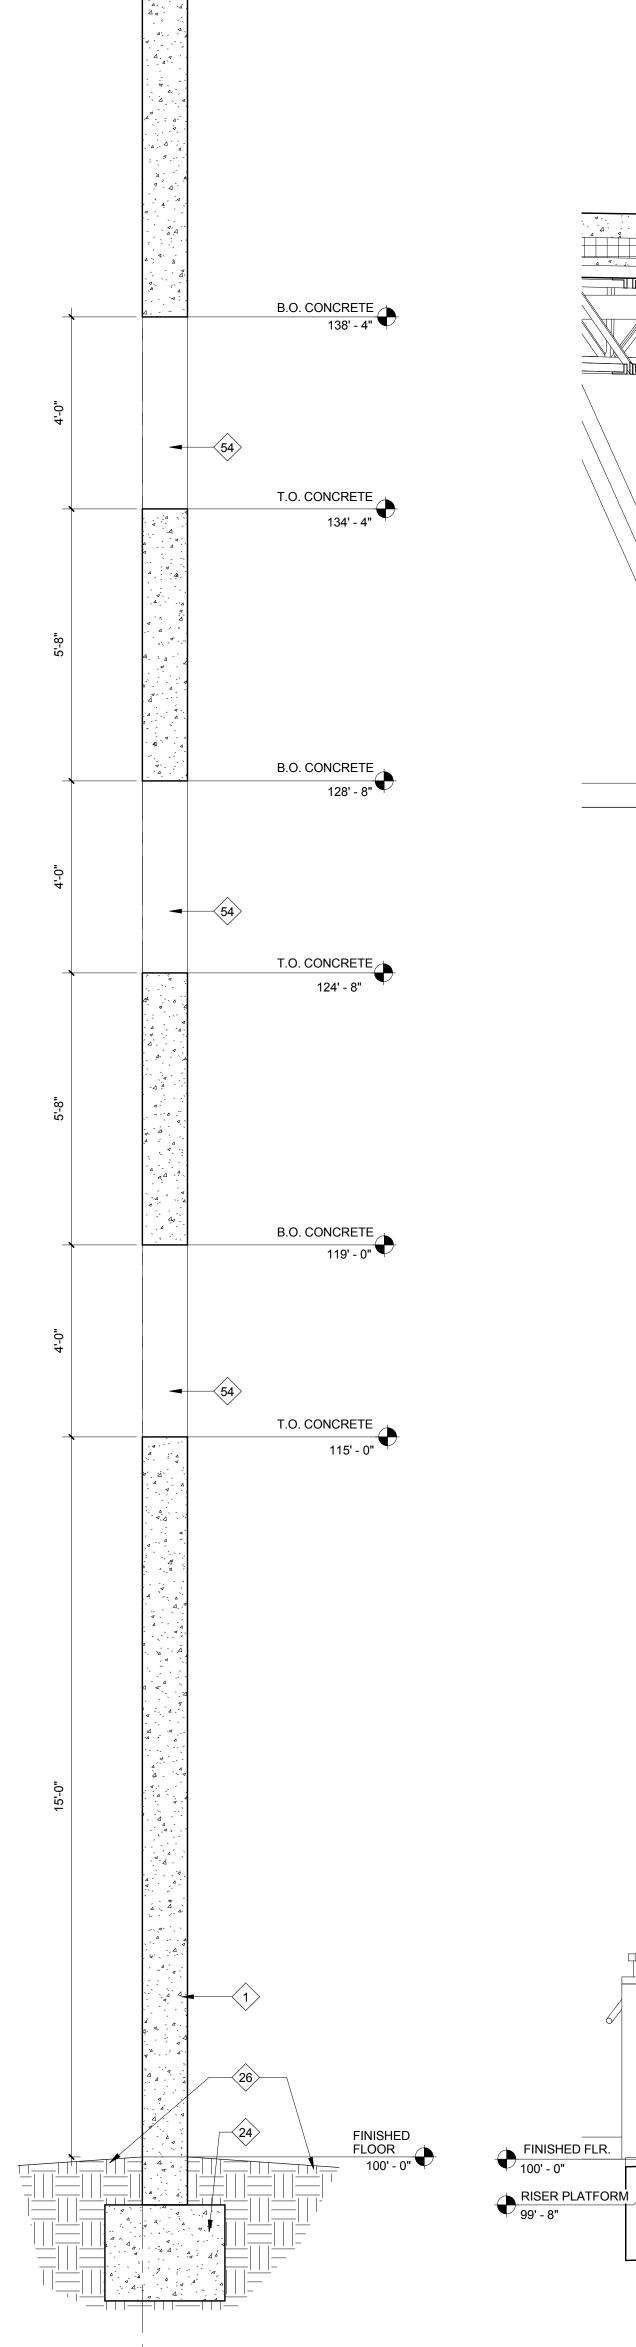




 18
 WALL SECTION AT WING WALL

 A7.05
 1/2" = 1'-0"
 REF:16/A2.06

19 WALL SECTION AT AUDITORIUM A7.05 1/2" = 1'-0" REF:16/A2.06

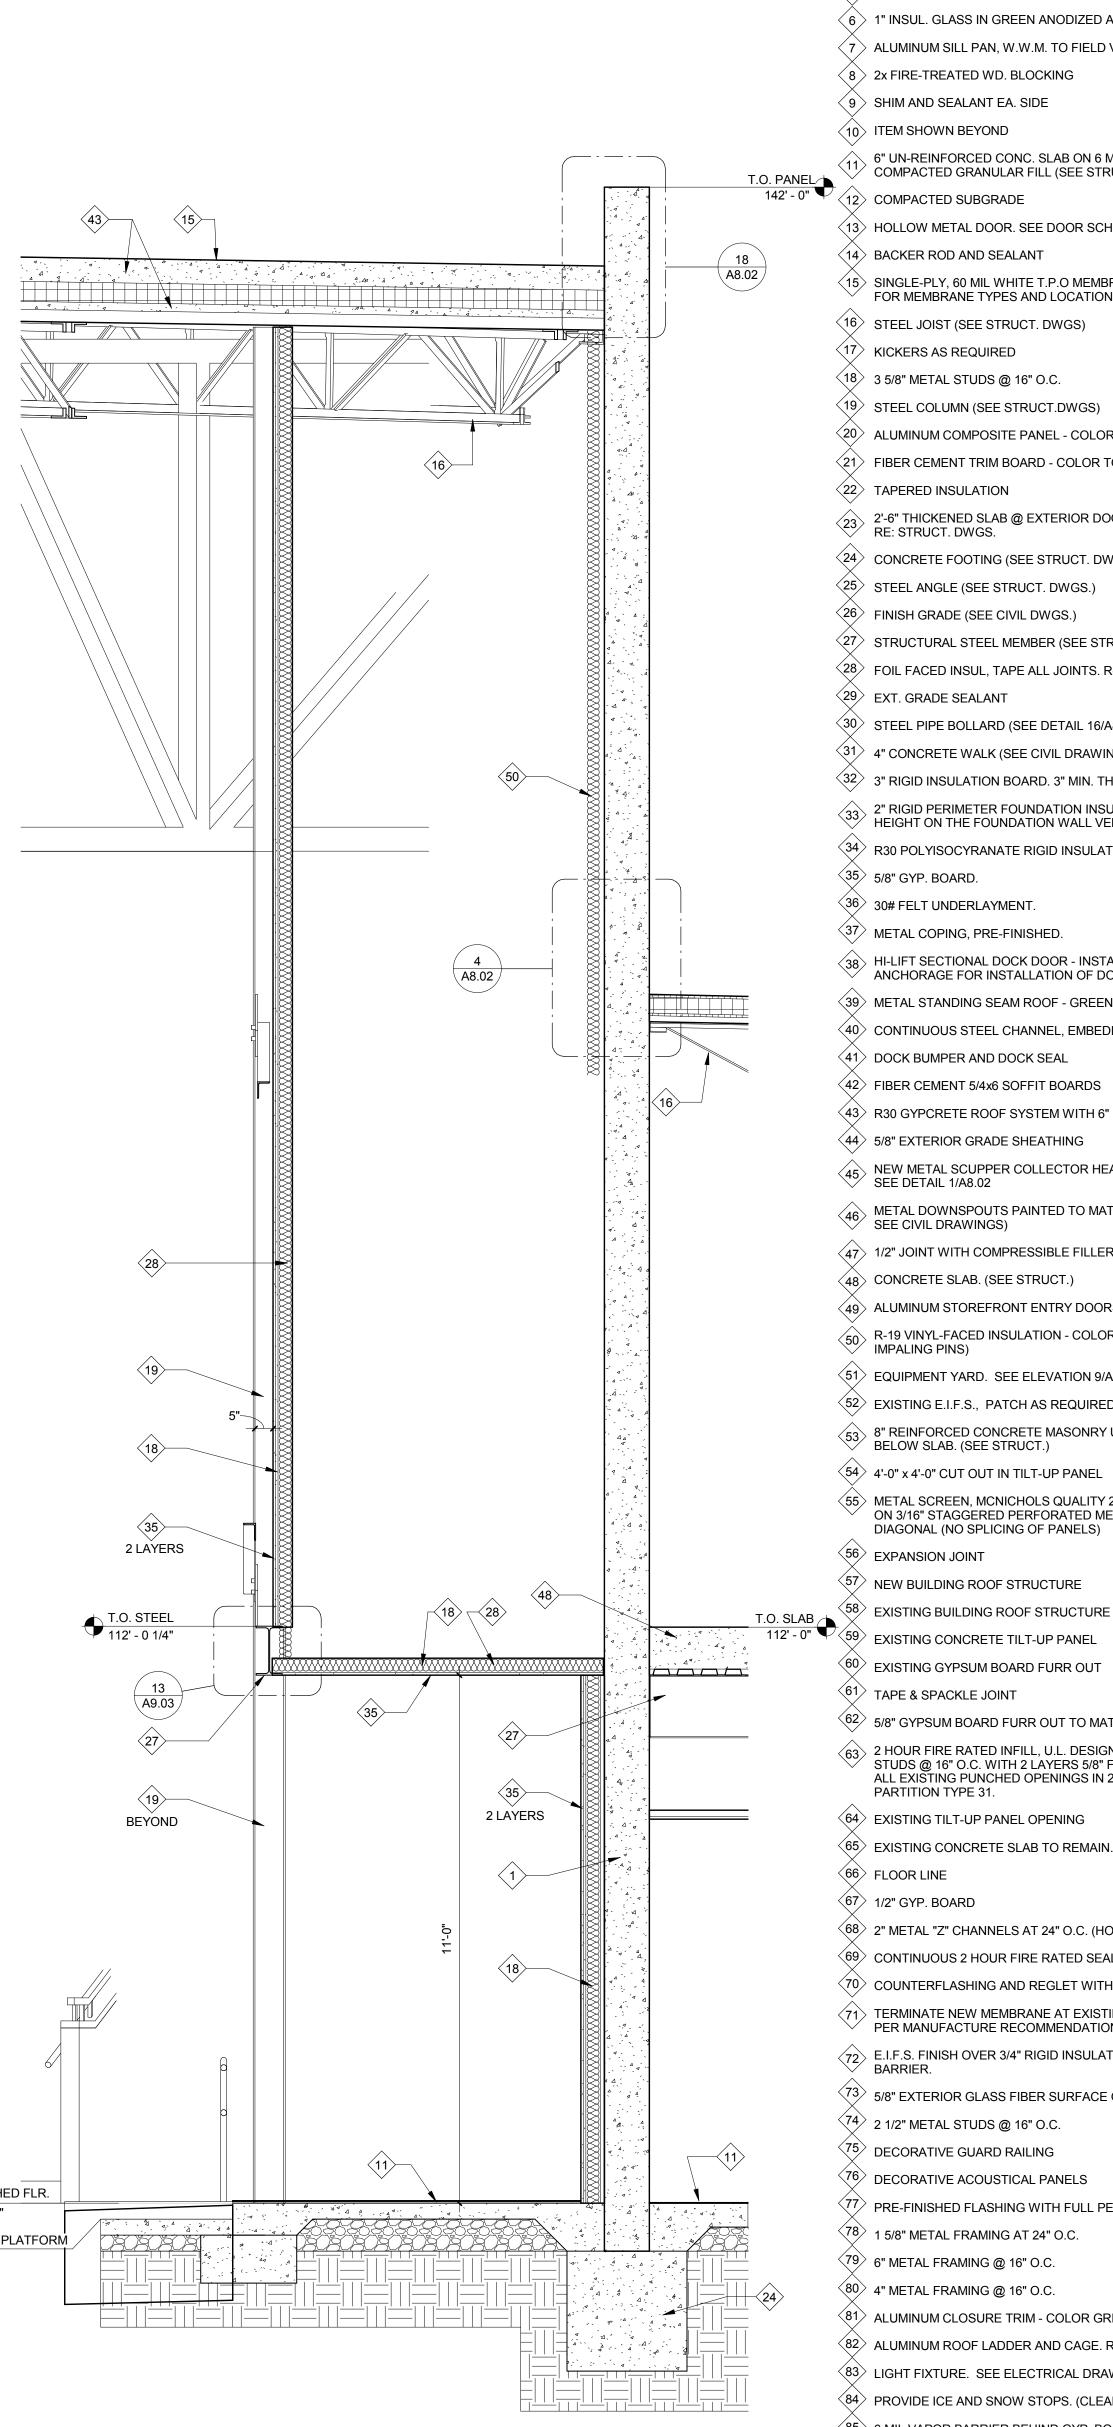

## EXTERIOR ELEVATION/ SECTION KEYED NOTES

- (1) CONC. TILT-UP PANEL (PTD.) (SEE STRUCT. DWGS)
- CONCRETE TILT-UP PANEL CULTURED STONE APPLIED (SEE STRUCT. DWGS)
- 3 METAL DECK (SEE STRUCT. DWGS)
- AIR INFILTRATION BARRIER OVER 1/2" EXTERIOR GRADE GYP. BOARD 4 SHEATHING
- $\langle 5 \rangle$  STEEL TUBE (SEE STRUCT)
- $\langle 6 \rangle$  1" INSUL. GLASS IN GREEN ANODIZED ALUM. FRAMES TO MATCH EXISTING
- 7 ALUMINUM SILL PAN, W.W.M. TO FIELD VERIFY LENGTH
- $\langle 8 \rangle$  2x FIRE-TREATED WD. BLOCKING
- 9 SHIM AND SEALANT EA. SIDE
- $\langle 10 \rangle$  ITEM SHOWN BEYOND
- 6" UN-REINFORCED CONC. SLAB ON 6 MIL.VAPOR BARRIER OVER 4"
- COMPACTED GRANULAR FILL (SEE STRUCT. DRWGS)
- 12 COMPACTED SUBGRADE
- 13 HOLLOW METAL DOOR. SEE DOOR SCHEDULE & PLANS
- 14 BACKER ROD AND SEALANT
- (15) SINGLE-PLY, 60 MIL WHITE T.P.O MEMBRANE ROOF. REFER TO ROOF PLAN ✓ FOR MEMBRANE TYPES AND LOCATIONS.
- (16) STEEL JOIST (SEE STRUCT. DWGS)
- 17> KICKERS AS REQUIRED
- (18) 3 5/8" METAL STUDS @ 16" O.C.
- (19) STEEL COLUMN (SEE STRUCT.DWGS)
- (20) ALUMINUM COMPOSITE PANEL COLOR GREEN TO MATCH EXISTING
- 21 FIBER CEMENT TRIM BOARD COLOR TO BE DETERMINED
- <22> TAPERED INSULATION
- 2'-6" THICKENED SLAB @ EXTERIOR DOORS (FROST HEAVE PROTECTION)-
- RE: STRUCT. DWGS.
- (24) CONCRETE FOOTING (SEE STRUCT. DWGS)
- (25) STEEL ANGLE (SEE STRUCT. DWGS.) <sup>(26)</sup> FINISH GRADE (SEE CIVIL DWGS.)
- 27 STRUCTURAL STEEL MEMBER (SEE STRUCT. DWGS)
- $\langle 28 \rangle$  FOIL FACED INSUL, TAPE ALL JOINTS. R-19 INSULATION.
- (29) EXT. GRADE SEALANT
- $\langle 30 \rangle$  STEEL PIPE BOLLARD (SEE DETAIL 16/A8.02).
- 31> 4" CONCRETE WALK (SEE CIVIL DRAWINGS)
- $\langle 32 \rangle$  3" RIGID INSULATION BOARD. 3" MIN. THICK.
- 2" RIGID PERIMETER FOUNDATION INSULATION. 2'-0" HORIZONTALLY AND THE HEIGHT ON THE FOUNDATION WALL VERTICALLY.
- 34 R30 POLYISOCYRANATE RIGID INSULATION.
- 35 5/8" GYP. BOARD.
- $\langle 36 \rangle$  30# FELT UNDERLAYMENT.
- (37) METAL COPING, PRE-FINISHED.
- HI-LIFT SECTIONAL DOCK DOOR INSTALLER TO PROVIDE ALL NECESSARY ANCHORAGE FOR INSTALLATION OF DOOR.
- $\langle 39 \rangle$  METAL STANDING SEAM ROOF GREEN TO MATCH EXISTING
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- $\langle 47 \rangle$  1/2" JOINT WITH COMPRESSIBLE FILLER.
- 48 CONCRETE SLAB. (SEE STRUCT.)
- $\langle 49 \rangle$  ALUMINUM STOREFRONT ENTRY DOORS.
- $\sim 50$  R-19 VINYL-FACED INSULATION COLOR BLACK (FASTEN TO WALL WITH MPALING PINS)
- (51) EQUIPMENT YARD. SEE ELEVATION 9/A6.03
- 52 EXISTING E.I.F.S., PATCH AS REQUIRED.
- 53 8" REINFORCED CONCRETE MASONRY UNIT WALL. GROUT CELLS SOLID BELOW SLAB. (SEE STRUCT.)
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- (56) EXPANSION JOINT
- 57 NEW BUILDING ROOF STRUCTURE
- EXISTING BUILDING ROOF STRUCTURE AND PARAPET
- EXISTING GYPSUM BOARD FURR OUT
- <sup>61</sup> TAPE & SPACKLE JOINT
- 62 5/8" GYPSUM BOARD FURR OUT TO MATCH EXISTING (63) 2 HOUR FIRE RATED INFILL, U.L. DESIGN NUMBER U-411, 2 1/2" 25 GA METAL
- STUDS @ 16" O.C. WITH 2 LAYERS 5/8" FIRECODE GYP. BD. EACH SIDE (TYP. ALL EXISTING PUNCHED OPENINGS IN 2 HOUR SEPARATION WALL) SEE PARTITION TYPE 31.
- (64) EXISTING TILT-UP PANEL OPENING
- 65 EXISTING CONCRETE SLAB TO REMAIN.
- 66 FLOOR LINE
- 67> 1/2" GYP. BOARD
- (68) 2" METAL "Z" CHANNELS AT 24" O.C. (HORIZONTALLY)
- (69) CONTINUOUS 2 HOUR FIRE RATED SEALANT EACH SIDE OF PARTITION
- (70) COUNTERFLASHING AND REGLET WITH CONT. BEAD OF SEALANT.
- TERMINATE NEW MEMBRANE AT EXISTING ROOF W / NEW LAP JOINT DETAIL ✓ PER MANUFACTURE RECOMMENDATIONS
- (72) E.I.F.S. FINISH OVER 3/4" RIGID INSULATION W/ SPRAY APPLIED WEATHER
- BARRIER.
- 73 5/8" EXTERIOR GLASS FIBER SURFACE GYPSUM SHEATHING
- 74 2 1/2" METAL STUDS @ 16" O.C.
- 75 DECORATIVE GUARD RAILING
- 76 DECORATIVE ACOUSTICAL PANELS
- 77 PRE-FINISHED FLASHING WITH FULL PERIMETER SEALANT
- 78> 1 5/8" METAL FRAMING AT 24" O.C. 79 6" METAL FRAMING @ 16" O.C.
- 80 4" METAL FRAMING @ 16" O.C.
- 81 ALUMINUM CLOSURE TRIM COLOR GREEN
- 82 ALUMINUM ROOF LADDER AND CAGE. RE: 13/A8.02
- $\langle 83 \rangle$  Light Fixture. See electrical drawings.
- 84 PROVIDE ICE AND SNOW STOPS. (CLEAR)
- 85 6 MIL VAPOR BARRIER BEHIND GYP. BOARD
- 86 2" RIGID BOARD INSULATION

## **GRAY DESIGN GROUP**

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9 Sunnen Drive, Suite 110 Saint Louis, Missouri 63143 Telephone 314.646.0400 www.graydesigngroup.com

| Construction Documents For:<br>THE CROSSING AT CHESTERFIELD<br>114 North Eatherton Road<br>Chesterfield, Missouri 63005 | Contact:<br>Produced By:<br>Reviewed By:<br>No. Dese<br>BID/ PERI<br>1 Addendun<br>2 Addendun<br>3 Addendun<br>6 ASI #1<br>10 ASI #3 | Sara V<br>Kent V<br>Toby H<br>Cription<br>MIT SET<br>n #1<br>n #2 | Vellman<br>Vagster<br>Ieddinghaus<br>Date                |
|---|--|---|--|
|   | Construction Documents For:  | THE CROSSING AT CHESTERFIELD                                      | 114 North Eatherton Road<br>Chesterfield, Missouri 63005 |
| Toby Heddinghaus<br>Architect<br>A-2007011296   |  |   | Architect  |

Job: 27111254.00

A7.05

